# Hadwick M7/16 Building Contractors

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Historic Building Photographic Record for

Property at 30 Oxford Street, Market Rasen, incolnshire Lincolnshire.

County Council

2 2 NOV 2007

Planning & Conservation

This record has been produced in accordance with Planning Condition No 2 of Approval Notice referenced M06/P/1018 dated 10th January 2007

Photographs were taken during July of 2007, prior to commencement of the works to convert the existing warehouse and retail unit into 11 No self-contained apartments.



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# **Elevation and Street Scene Photographs**



Adjoining Properties on Oxford Street



Street Scene Looking North on Oxford Street



Front Elevation of Two Storey section. Former 'Farmers' retail unit.



Front Elevation of Three Storey section.



Street Scene Looking South on Oxford Street.

## Internal Photographs Showing Existing Structure



Photograph Number 1
Ground floor of retail unit showing steel support to existing floor joists
Steelwork stamped Caledonian Steelwork Company
Brickwork pillars hide further steel stanchions



Photograph Number 2 Joint in steel beams at stanchions

Note joints in timber above line of steelwork. The staining on the timber suggests that the original support structure was not on the same line..

Also note slight difference in depth of steel and the inconsistency of jointing, which could suggest that these beams were replacing originally installed timber beams. Note also that the

steel beam in the background does not sit directly onto the padstone, which does suggest that the beams are later replacements.



Photograph Number 3
Openings formed in existing structure during previous occupancies
Note use of concrete lintels and that windows do not accord with brick coursing
Steel beams and stanchions with brick cladding.



Photograph Number 4
Ground floor of 3 storey warehouse with steelwork and timber floor joists exposed



Photograph Number 5
Timber stanchion at ground floor
To be retained within new development.
Stanchion appears to be original structure.



Photograph Number 6 As above.

Note amendments to floor joists and the addition of steelwork to provide opening for roller shutter during former occupancies.




Photograph Number 7
Shows original arched brick openings and bull-nosed bricks
Left Hand opening to be retained in development, Right hand opening to be infilled.




Photograph Number 8

First Floor showing the bottom chord of the timber truss which provides the second floor storage area. The oak support posts and floor spreaders appear to be later additions to the structure. These will be replaced with steel stanchions in the same positions as the structural engineers cannot prove their ability to support the existing and proposed loadings.

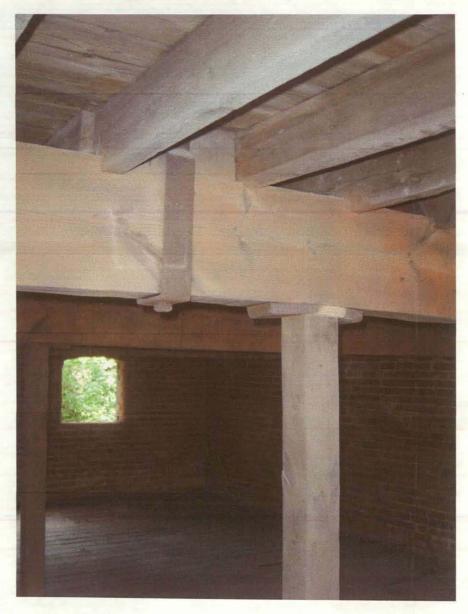

Photograph Number 9
Shows the connection between the oak stanchions to the bottom chord of the truss.
Also shows the steel strapping connecting bottom chord to the truss posts.

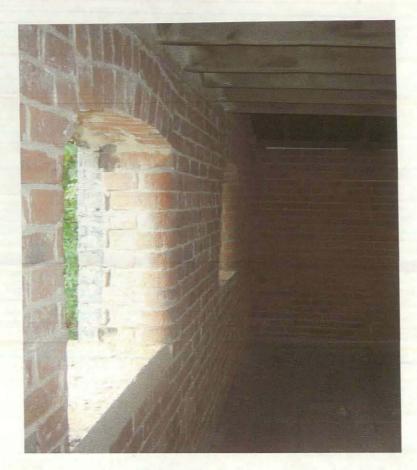


Photograph Number 10
Shows existing openings along rear elevation, which are to be retained in this development.



Photograph Number 11
Shows timber trusses and purlins that form the roof structure to the two storey section.
Note the bull-nosed brickwork pillars on the end bearing of the trusses.
The trusses are to be retained in this development and left semi-exposed in kitchen/living areas.



Photograph Number 12
Showing the high level window
New Aluminium windows to be installed in all openings and window to be retained in this development. Window will provide light to living/kitchen areas.

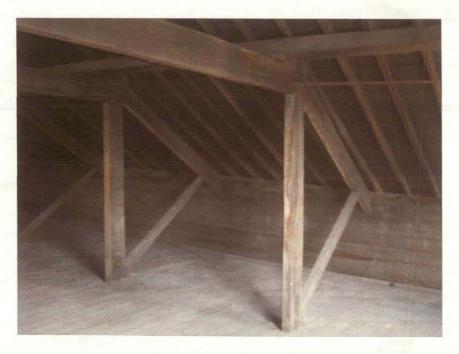


Photograph Number 13
Shows existing truss and rafters to second floor.



Photograph Number 14
Shows trusses at second floor and the exiting dormer and stair well.
Trusses to be retained and dormer modified in height only to provide additional headroom.




Photograph Number 15
Shows junction between truss and purlins at second floor level.

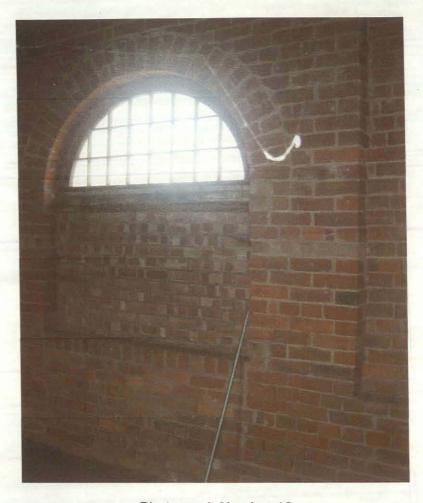

Photograph Number 16
Shows existing openings on rear elevation.
Window openings to be reformed to existing sill level in this development.



Photograph Number 17 Shows existing dormer above stair well.

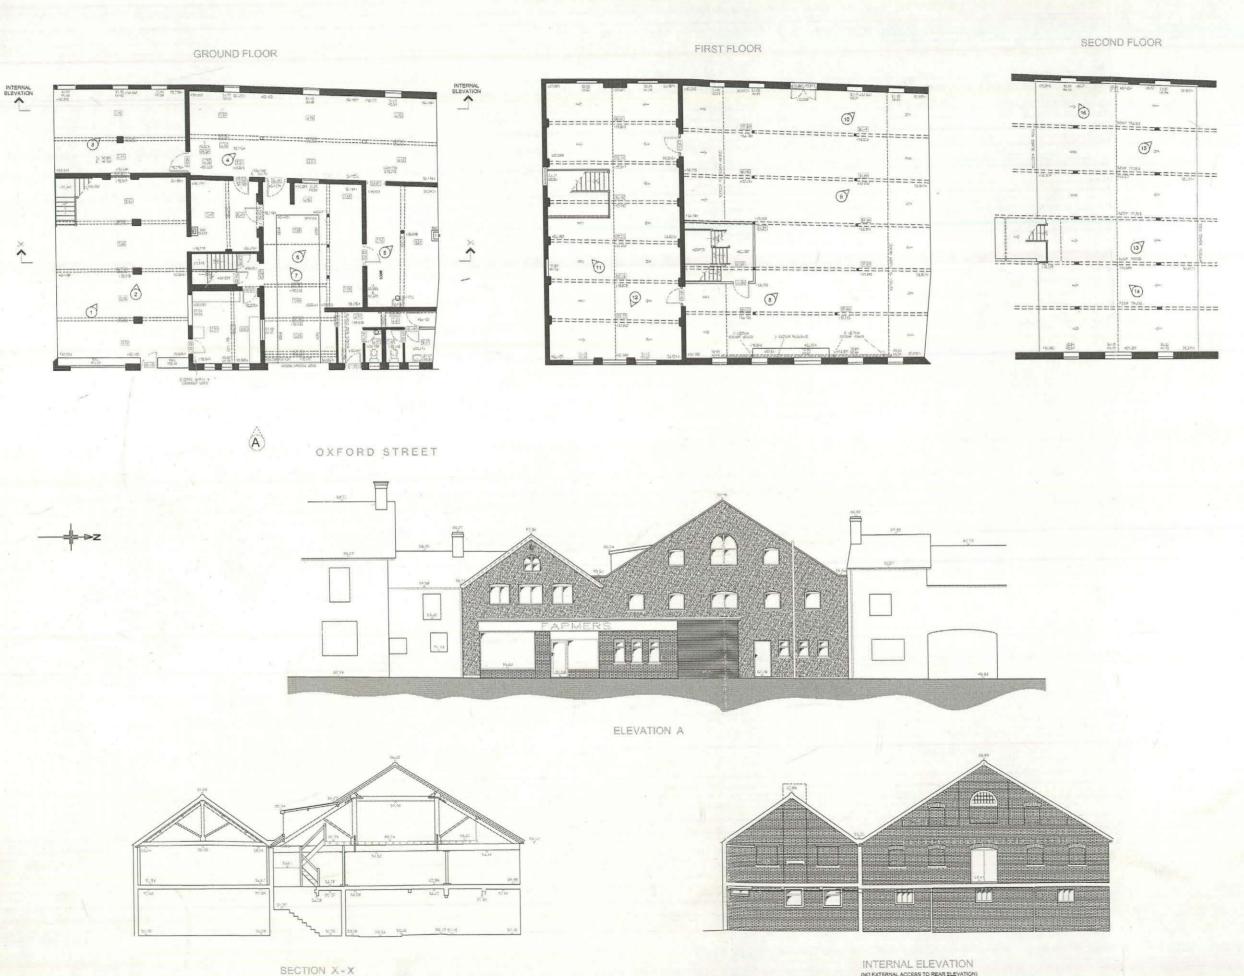

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-OOO - Canopy Line Trunk Line
Hedge
Wall Well Defined/Poorly Defined/Undefined eg. Conc Edge/Tormoc Edge/Track Edg Overhead Electric / Telephone Cab --:-- Surface Water Sewer Kerb / Drop Kerb / Symbols Borehole S Triol Pit Tree (Coniferous) - Survey Statio Abbreviations TC Telecom Cover BO Bollard CL Cover Level CATVCoble TV
EL Dietric Cover EP Electric Post ER Earth Point FFI. Floor Lif
FM Fire Hydrant FP Rog Pole CA Cos Cover GP Gate Post
G Gully IC Inspection Cover IL invert Level KO K'b Offlet
LP Lomp Post MH Monifole PIP Fost Box PO Post
RE Rodding Eye RWP Roin Water Pipe RS Road Sign SP Sign Post
SV Stop Valve IL Treffic Light TP Telegraph Pole VP Vent Pipe
WM Water Meter

Building / Building Overhang Changes to Surface Finish :

### Notes:

Legend: - Bank Top/Battam

- 1. Survey undertaken June 2006.
- 2. Survey plotted to assumed local metric grid.
- All levels related to assumed datum, station A. value 50.000m.
- All manhole / chamber pipe sizes and inverts are estimations made from surface level only. Pipe inverts shown are outgoing pipe unless otherwise stated.
- Whilst every effort has been made to locate all visible features it should be noted that at the time of survey some items may have been obscured and therefore not located.
- Physical boundary features shown on this survey do not necessarily represent the legal boundaries.

essential Finished Floor Level (Incl. carnet etc.)

Finished Floor Level to finished celling height

Finished Floor Level to beam soffit height

F Floor Level to approx door structural opening Finished Floor Level to wall height

Finished Floor Level to roof truss soffit height

Finished floor Level to window sill height Window sill to window head height

Ceiling Slope. Arrow denotes direction of rise

Overhead beam detail

Overhead ceiling detail

GRAPHIC SCALE 1:100



MEASURED BUILDING SURVEY

30 OXFORD STREET MARKET RASEN

Approved:	Drawn: S. Garton
Date: 22.04.06	Scale: 1:100
Digital file: Survey.dwg	Onginal Size: A1

# SHIRE SURVEYS

Westfield Cottage, 7 Crowle Bank Road Althorpe, Sounthorpe, North Lincs, DN17 3HZ Tel: 01724 783078 Fax: 01724 783224 Ernall : shiresurveys@tiscali.co.uk



Building Recording	
Name of building &	30 Oxford Street
Address	
	: Market Raxen
Parish	Market Rasen
Grid Reference	TF 1083 8896
Age (period)	victorian? (shown on 1905 OS)
Style	Vicability (Statistical Field Co.)
Date and source	
Architect or known	
history	
Building type	
Storeys	3
Main walling material	prick
3	DNCC
Other walling	
material(s)	
Roofing materials	pantile
Other distinctive	
materials	
Phases	
(i.e. how many major	
phases of building since	
the building was first	
erected)	
Layout:	terrace
detached/semi/terrace	
Interior layout	
(classic	
plan/multiphase)	
Photographs	
exterior elevations	
exterior features	
interior features	
Plan(s)	
Landscape context	
Associated buildings	
Current use	delict
Condition	undertaking renovation
Recorded by	Je J Hadwick
Date of record	July 2007