


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 Vineyard House
 Upper Hook Road
 Upton Upon Severn
 WR8 0SA
 OS 100km square = TL

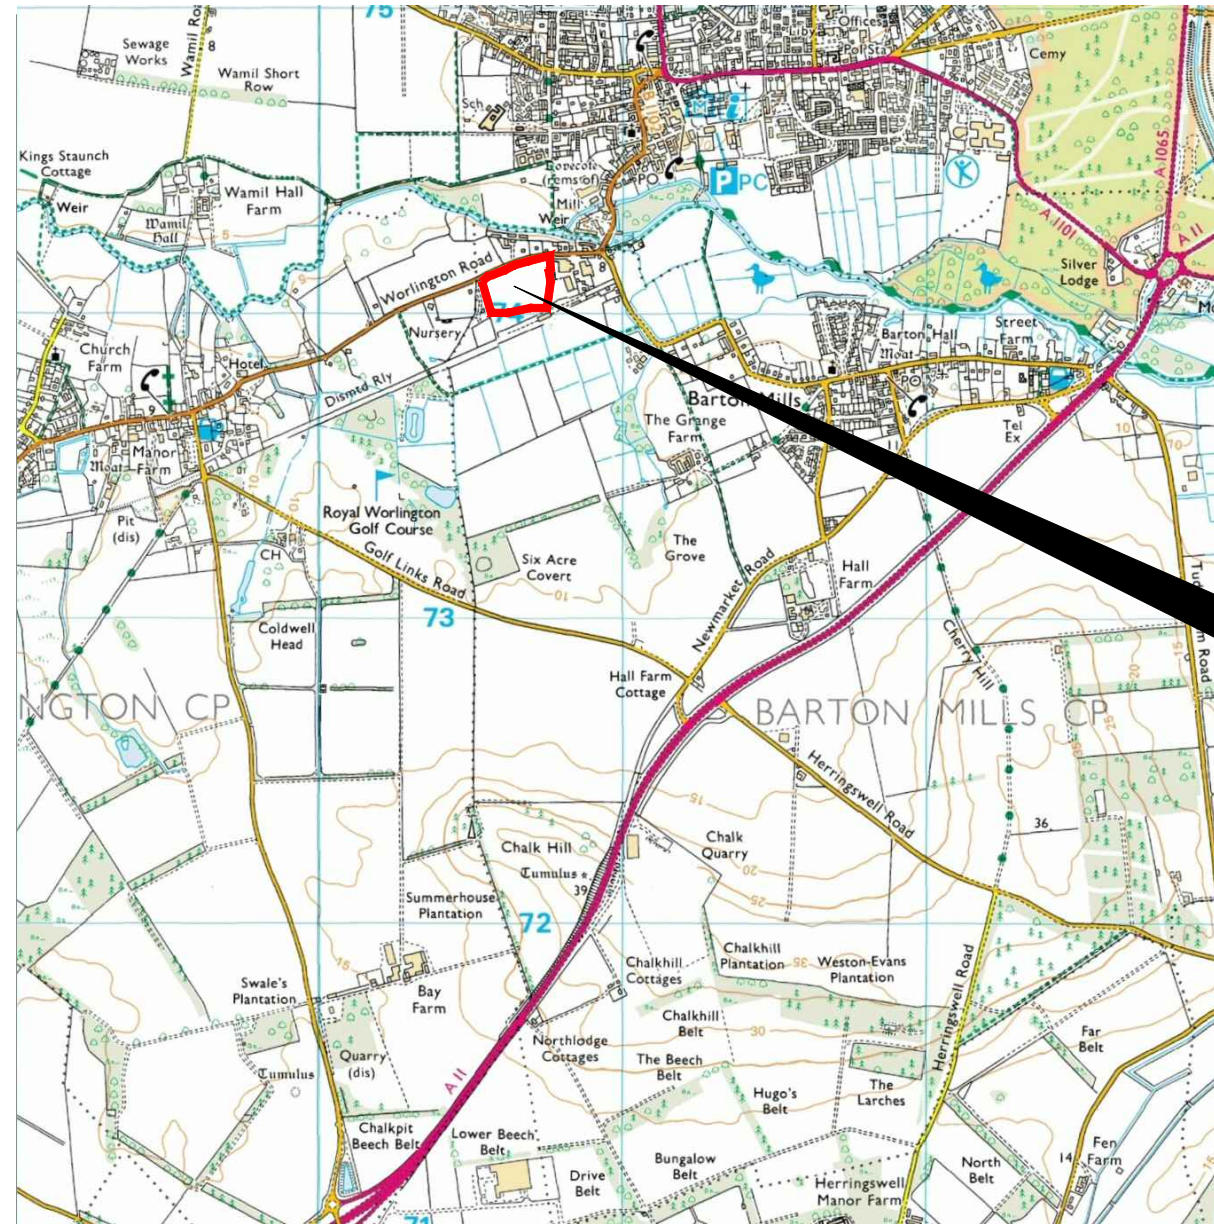

75
74
73
72
71



69 70 71 72 73

Amendments

Issue No.	Date	Description
-	-	-
-	-	-

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Site centred on NGR TL 706 741

Client
CgMs

Project Title Job No. J6008
**GEOPHYSICAL SURVEY -
 WORLINGTON ROAD, MILDENHALL**

Subject
LOCATION PLAN OF SURVEY AREA

STRATASCAN™
**GEOPHYSICS FOR ARCHAEOLOGY
 AND ENGINEERING**
 VINEYARD HOUSE T: 01684 592266
 UPTON UPON SEVERN E: info@stratascan.co.uk
 WR8 0SA www.stratascan.co.uk



Scale 1:25000
 0m 500m 1000m

Plot A3	Checked by DGE	Issue No. 01
Survey date OCT 2013	Drawn by OJP	Figure No. 01



Amendments

Issue No.	Date	Description
-	-	-
-	-	-

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KEY

	Survey area
	Numbered survey grid
	GPS referencing point

OS GRID REFERENCES


A	570554.72, 274073.42
B	570727.82, 274122.78

Client
CgMs

Project Title
GEOPHYSICAL SURVEY -
WORLINGTON ROAD, MILDENHALL

Job No. J6008

Subject
GENERAL SITE PLAN

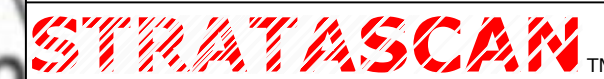

**GEOPHYSICS FOR ARCHAEOLOGY
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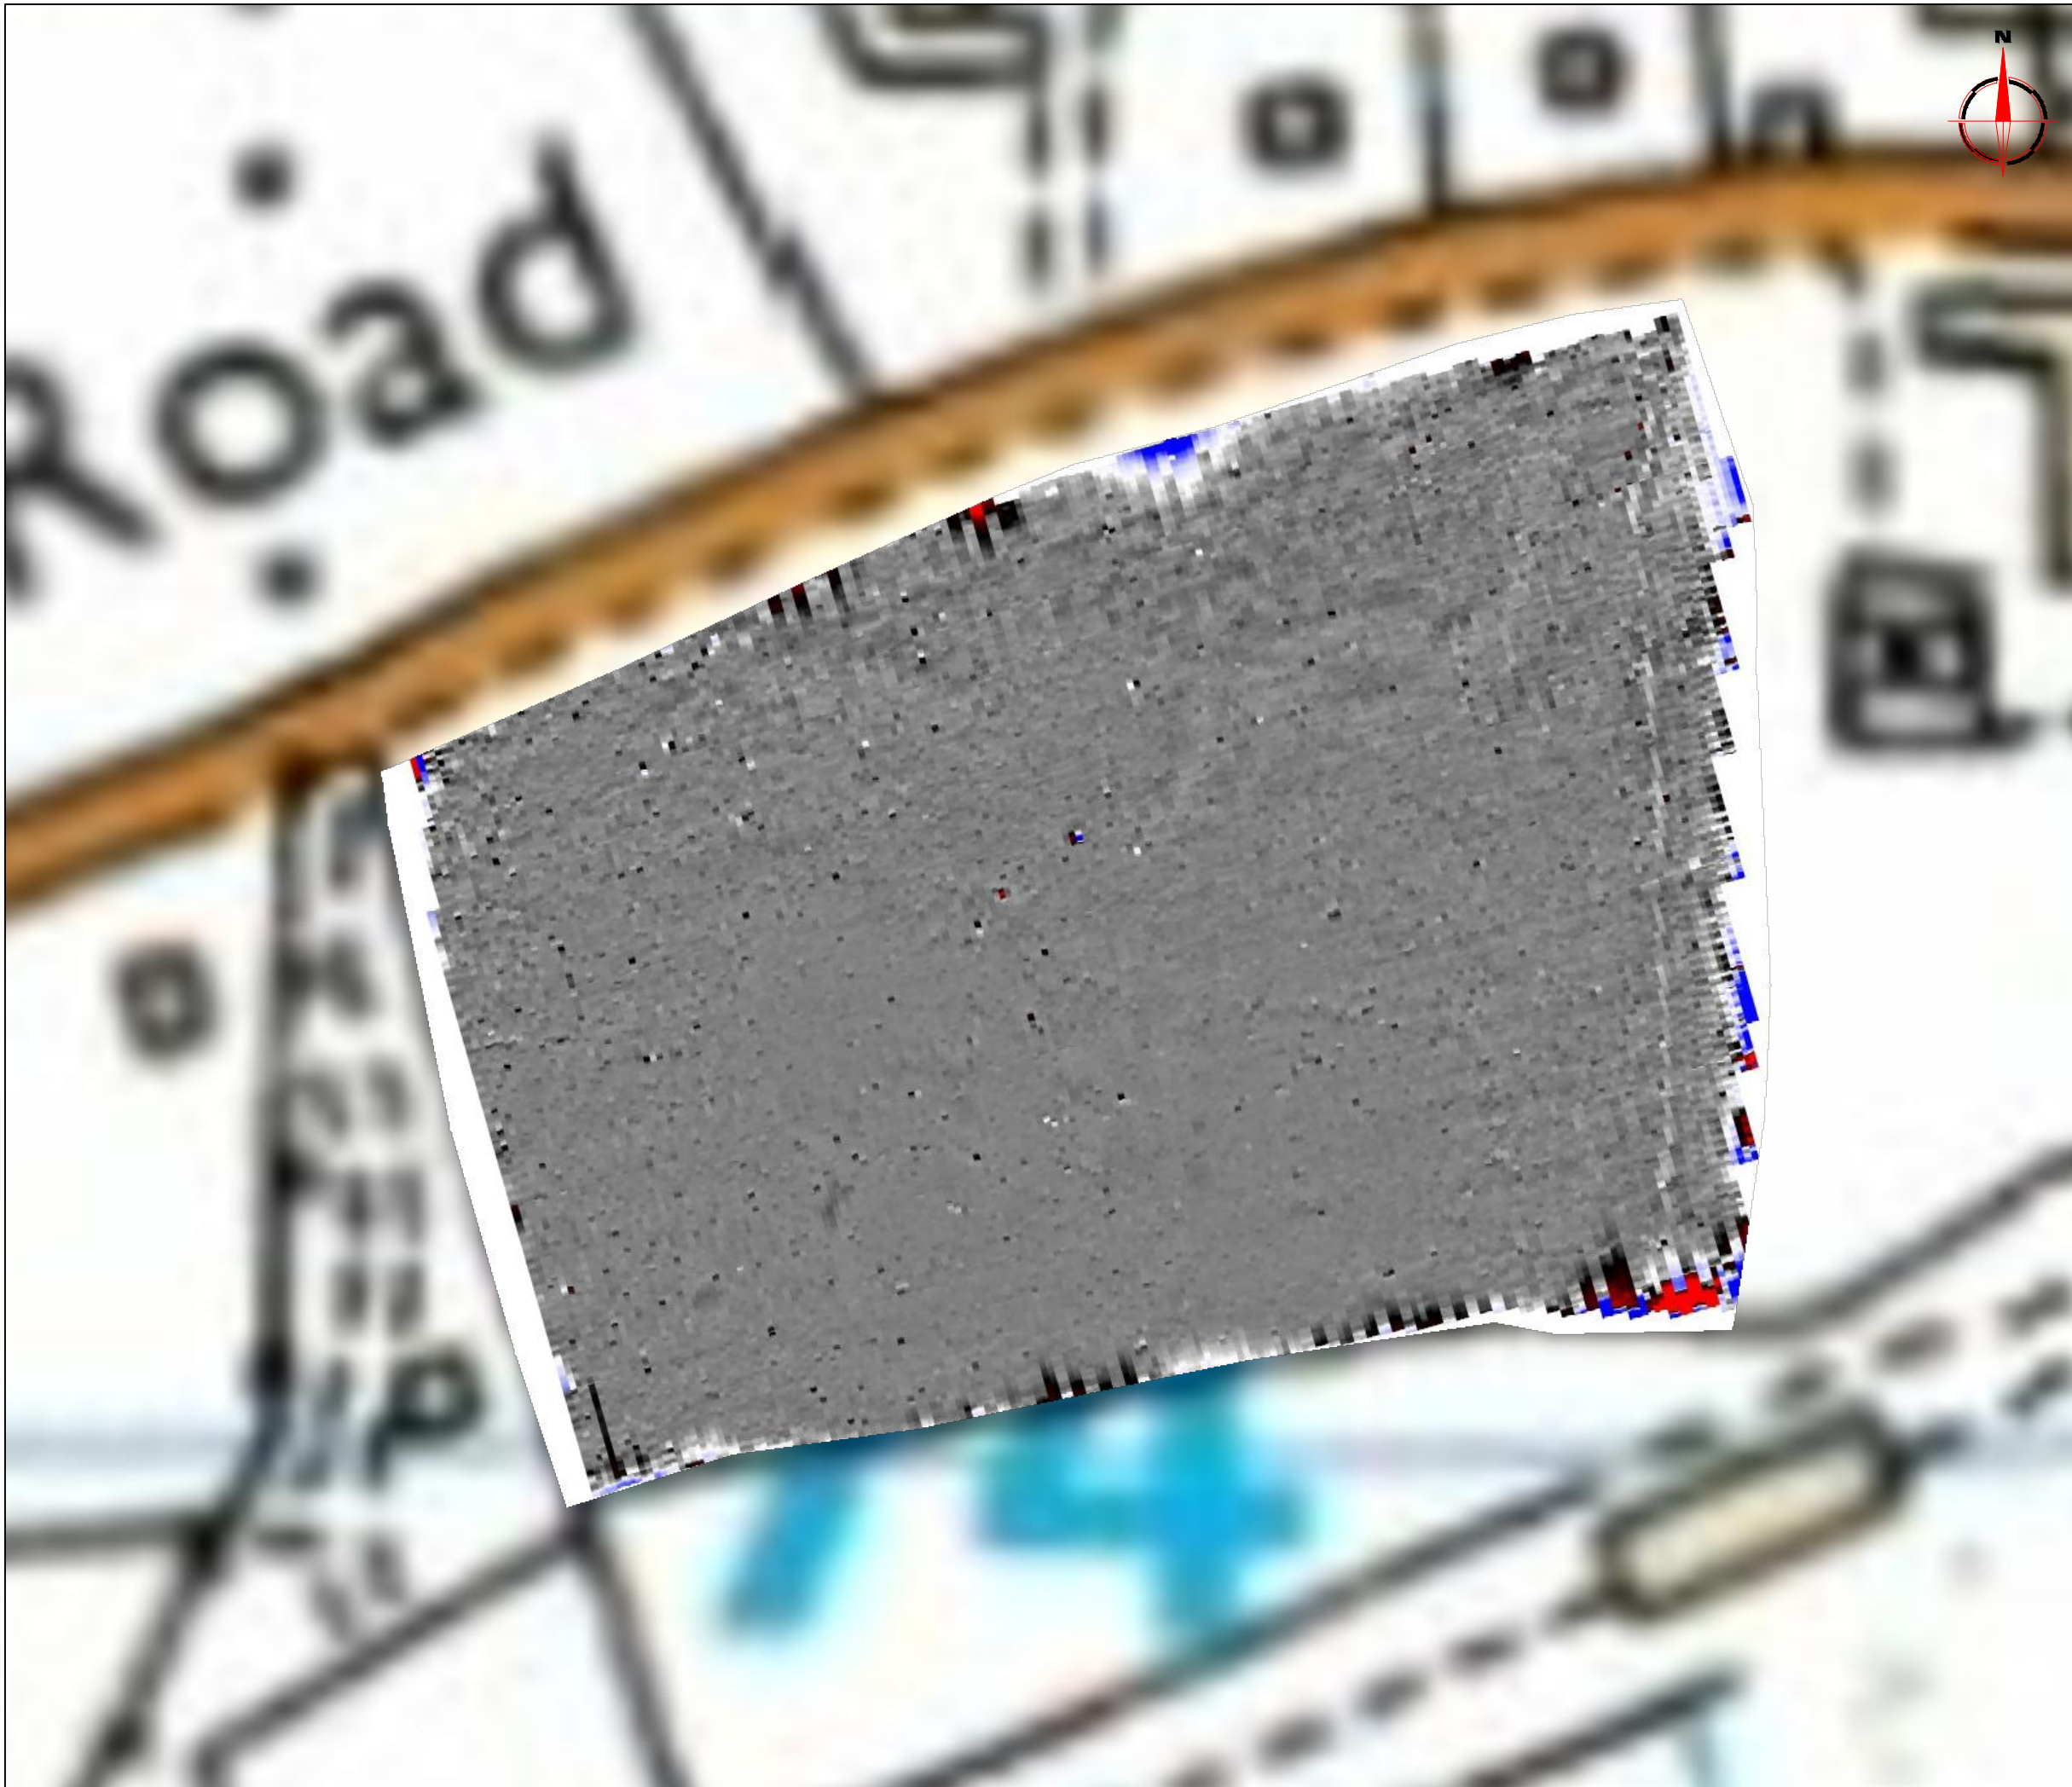


SUMO
GROUP
MEMBER



Scale 1:5000
0m 10 20 30 40 50

Plot A3	Checked by DGE	Issue No. 01
Survey date OCT 2013	Drawn by OJP	Figure No. 02



Amendments

Issue No.	Date	Description
-	-	-
-	-	-

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Plotting parameters

Maximum +100nT (red)
Minimum -100nT (blue)

Client
CgMs

Project Title **GEOPHYSICAL SURVEY - WORLINGTON ROAD, MILDENHALL** Job No. **J6008**

Subject
COLOUR PLOT OF GRADIOMETER DATA SHOWING EXTREME VALUES

STRATASCAN™
GEOPHYSICS FOR ARCHAEOLOGY AND ENGINEERING
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EUROPEAN GPR ASSOCIATION
SUMO SURVEY SERVICES SUMO GROUP MEMBER
 ISO 9001 certified UKAS ISO 14001 certified

Scale **1:1000** 0m 10 20 30 40 50


Plot A3	Checked by DGE	Issue No. 01
Survey date OCT 2013	Drawn by OJP	Figure No. 03



Amendments

Issue No.	Date	Description
-	-	-
-	-	-

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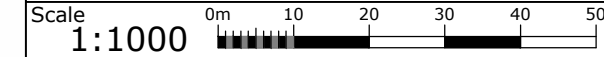
Client
CgMs

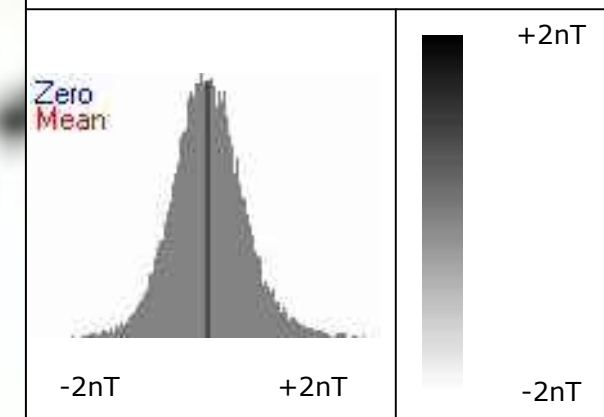Project Title **GEOPHYSICAL SURVEY - WORLINGTON ROAD, MILDENHALL** Job No. **J6008**


Subject
PLOT OF MINIMALLY PROCESSED GRADIOMETER DATA

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EUROPEAN GPR ASSOCIATION
sumo SUMO GROUP MEMBER
 ISO 9001 certified ISO 14001 certified



Plot A3	Checked by DGE	Issue No. 01
Survey date OCT 2013	Drawn by OJP	Figure No. 04

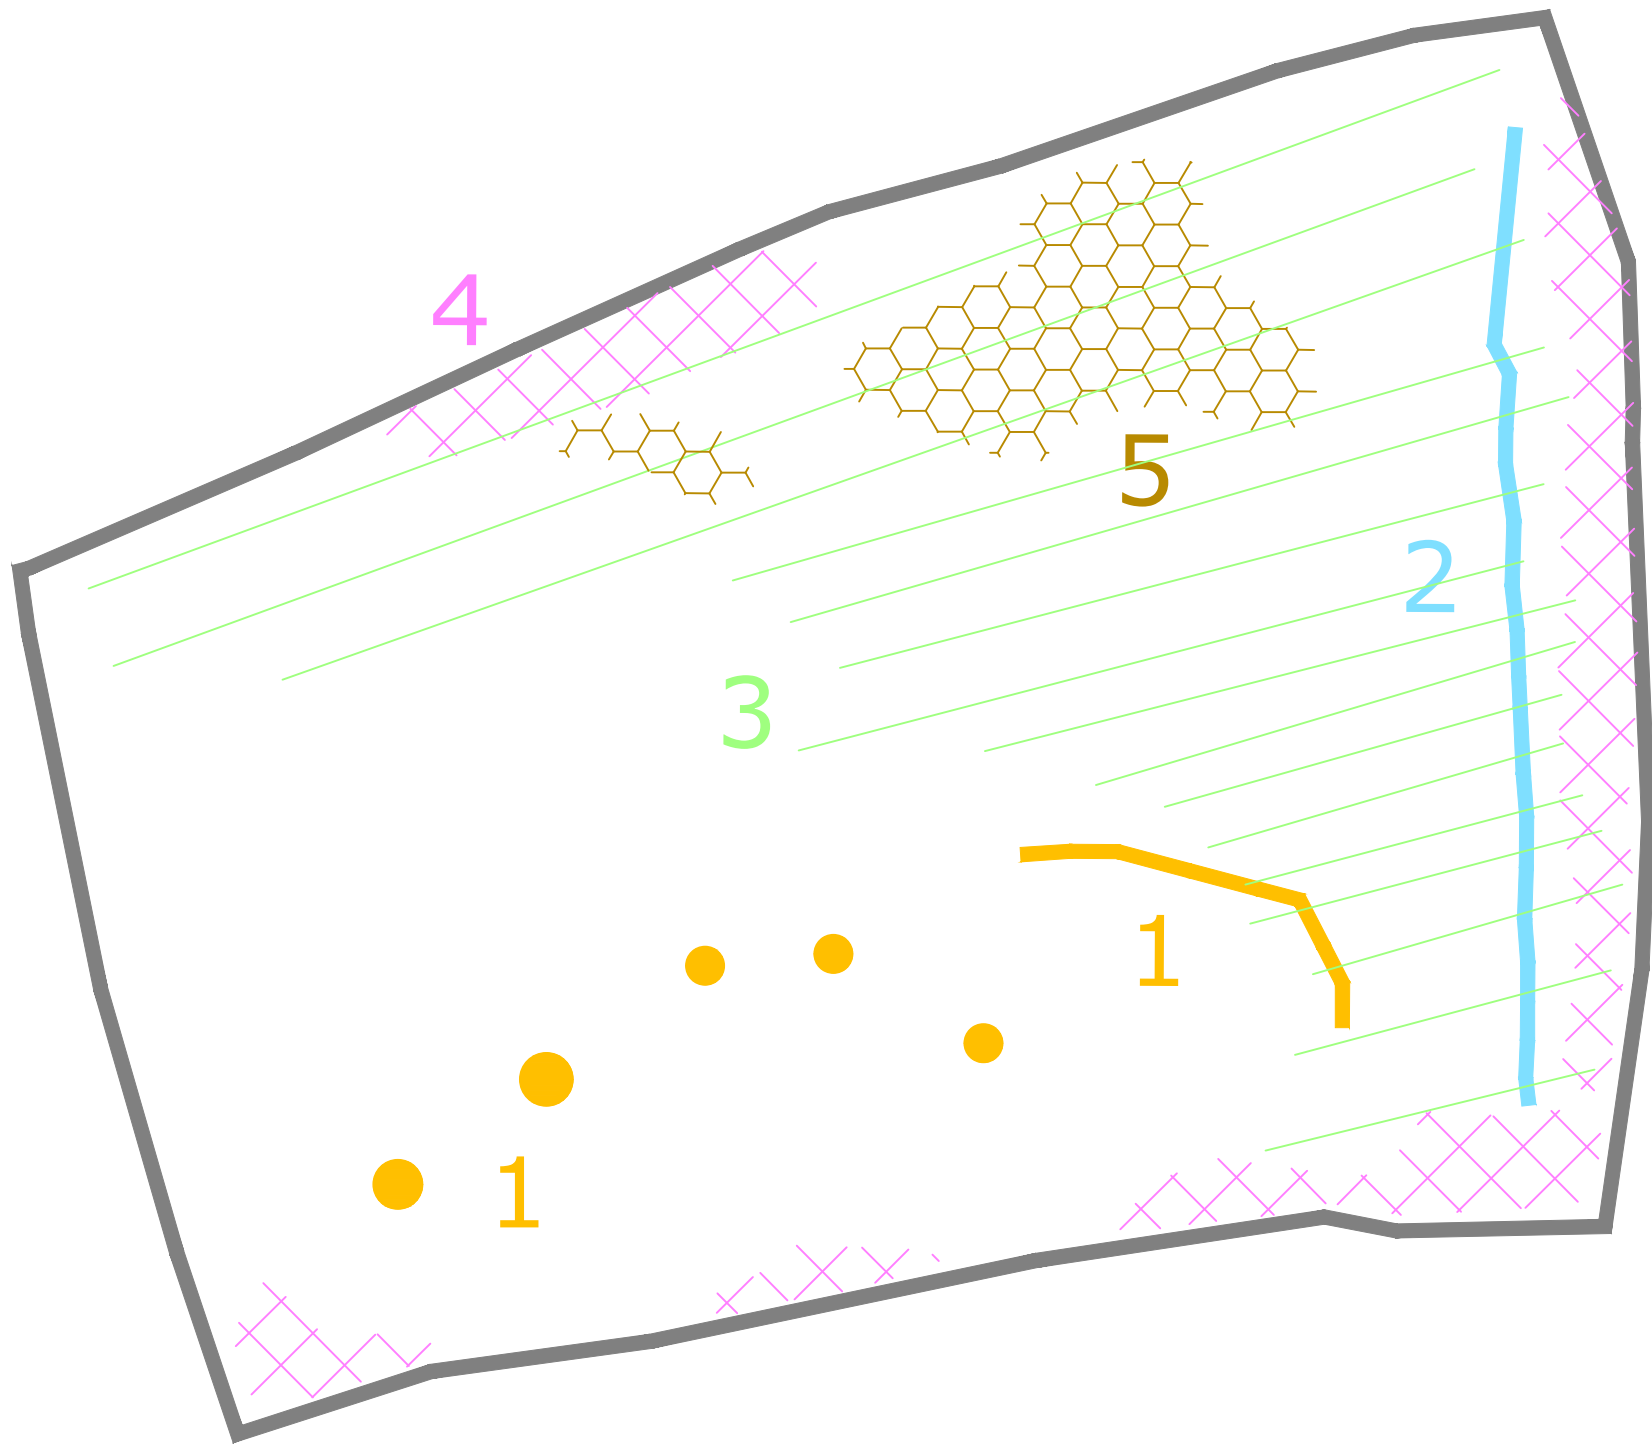

Amendments		
Issue No.	Date	Description
-	-	-
-	-	-
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KEY		
PROBABLE ARCHAEOLOGY		
	Positive anomaly / weak positive anomaly - probable cut feature of archaeological origin	
	Negative anomaly / weak negative anomaly - probable bank or earthwork of archaeological origin	
	Moderate strength discrete anomaly - probable thermoremanent feature	
	Widely spaced curving parallel linear anomalies - probably related to ridge-and-furrow	
POSSIBLE ARCHAEOLOGY		
	Positive anomaly / weak positive anomaly - possible cut feature of archaeological origin	
	Negative anomaly / weak negative anomaly - possible bank or earthwork of archaeological origin	
	Linear anomaly possibly relating to field boundary or ditch	
	Magnetic spike - probable ferrous object	
OTHER ANOMALIES		
	Closely spaced parallel linear anomalies - probably related to agricultural activity such as ploughing	
	Linear anomaly - probably related to pipe, cable or other modern service	
	Linear anomaly - possibly related to land drain	
	Magnetic disturbance associated with nearby metal object such as service or field boundary	
	Strong magnetic debris - possible disturbed or made ground	
	Scattered magnetic debris	
	Area of amorphous magnetic variation - probable natural (e.g. geological or pedological) origin	
Client		
CgMs		
Project Title		Job No. J6008
GEOPHYSICAL SURVEY - WORLINGTON ROAD, MILDENHALL		
Subject		
ABSTRACTION AND INTERPRETATION OF GRADIOMETER ANOMALIES		
STRATASCAN™		
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WR8 0SA		www.stratascan.co.uk
Scale		
1:1000		
Plot	Checked by	Issue No.
A3	DGE	01
Survey date	Drawn by	Figure No.
OCT 2013	OJP	05