


Reproduced from Ordnance Survey's 1:25 000 map of 1998 with the permission of the controller of Her Majesty's Stationary Office. Crown Copyright reserved. Licence No: AL 50125A  
 Licensee:  
 Stratascan Ltd.  
 Vineyard House  
 Upper Hook Road  
 Upton Upon Severn  
 WR8 0SA  
 OS 100km square = SP

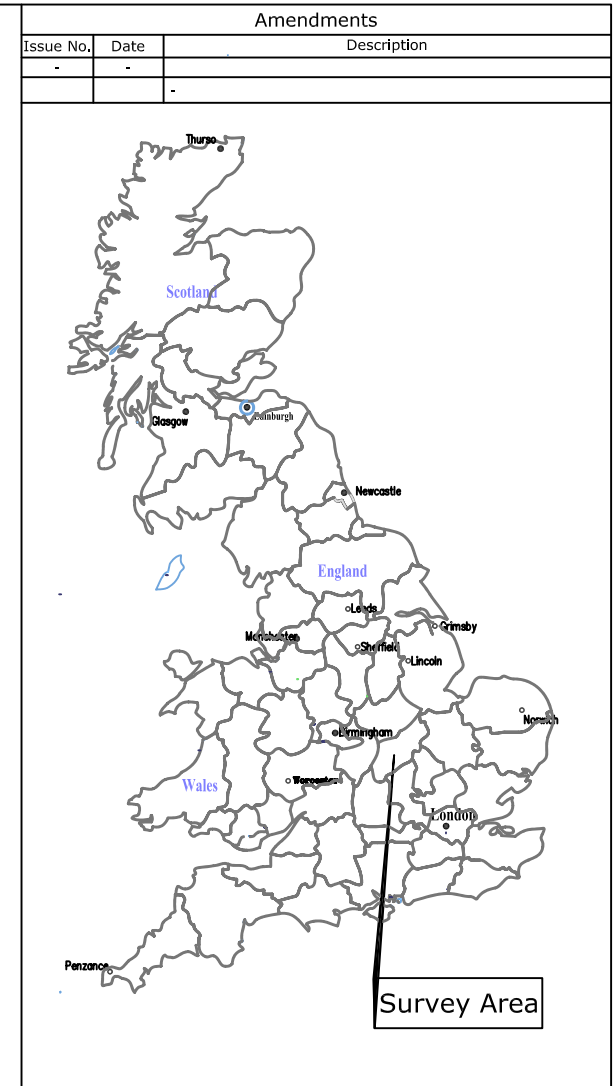

Site centred on NGR **SP 9943 7217**

Client **ASC**

Project Title **GEOPHYSICAL SURVEY - WELLINGTON ROAD RAUNDS** Job No. **1926**


Subject **LOCATION PLAN OF SURVEY AREA**


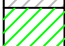


**STRATASCAN™**  
 GEOPHYSICS FOR ARCHAEOLOGY  
 AND ENGINEERING  
 VINEYARD HOUSE  
 UPPER HOOK ROAD  
 UPTON UPON SEVERN  
 UK  
 WR8 0SA  
 T: +44 (0)1684 592266  
 F: +44 (0)1684 594142  
 E: info@stratascan.co.uk  
 www.stratascan.co.uk



Scale **1:25 000** 0m 500 1000m

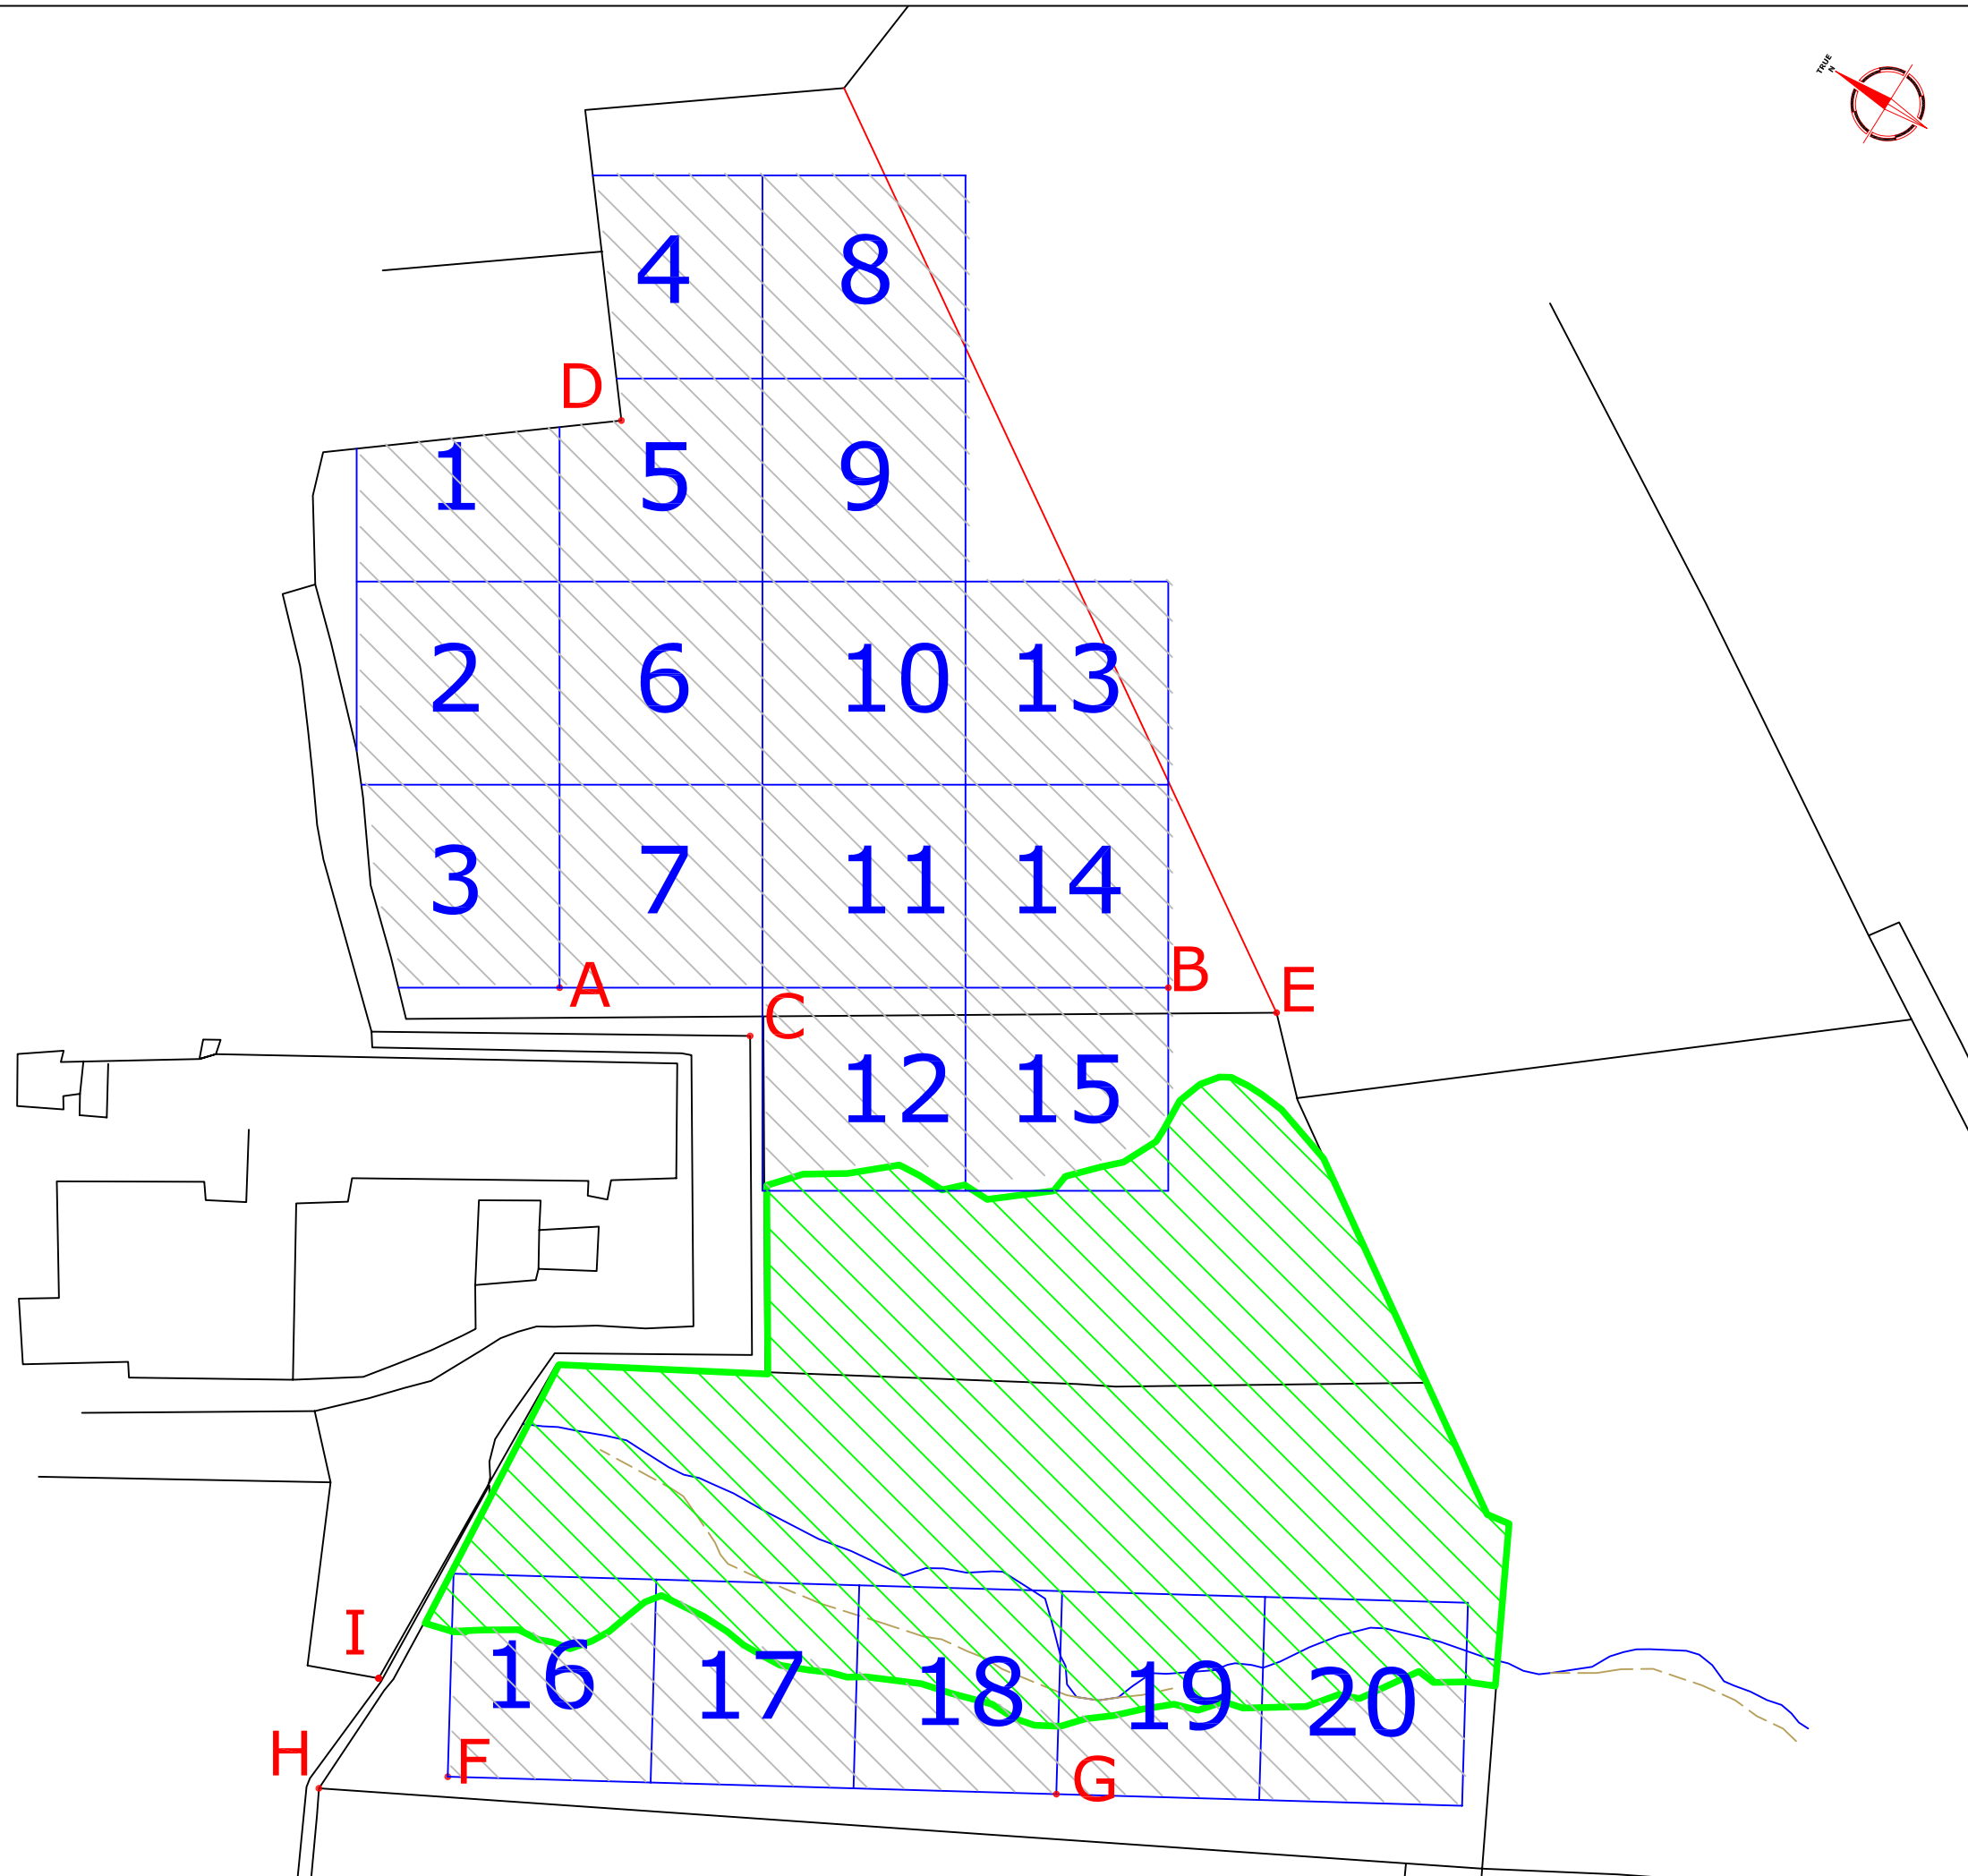Plot <b>A3</b>	Checked by <b>DJS</b>	Issue No. <b>01</b>
Survey date <b>OCT 04</b>	Drawn by <b>LB</b>	Figure No. <b>01</b>



Amendments					
Issue No.	Date	Description			
-	-	-			
REFERENCING INFORMATION					
A-B	90m	A-C	29.12m	A-D	84.35m
A-E	107.92m	B-C	61.48m	B-D	115.96m
B-E	18.47m	F-G	90m	F-H	19.14m
F-I	17.76m	G-H	108.83m	G-I	101.03m
CDE	Referencing points on fenceline				
H&I	Referencing points on fenceline				
A-B	Grid node pegs and baseline				
F-G	Grid node pegs and baseline				
2	Survey grid number				
	Area surveyed within grid				
	Area of thick vegetation				
Client	ASC				
Project Title	GEOPHYSICAL SURVEY - WELLINGTON ROAD RAUNDS		Job No.	1926	
Subject	SITE PLAN SHOWING LOCATION OF SURVEY GRIDS AND REFERENCING				
 <b>STRATASCAN™</b> GEOPHYSICS FOR ARCHAEOLOGY AND ENGINEERING VINEYARD HOUSE UPPER HOOK ROAD UPTON UPON SEVERN UK WR8 0SA T: +44 (0)1684 592266 F: +44 (0)1684 594142 E: info@stratascan.co.uk www.stratascan.co.uk					
Scale	1:1000 				
Plot	A3	Checked by	DJS	Issue No.	01
Survey date	OCT 04	Drawn by	LB	Figure No.	02



Amendments		
Issue No.	Date	Description
-	-	-
-	-	-
-	-	-

Plotting parameters Maximum +7.97nT (black) Minimum -8.20nT (white)		
Client ASC		
Project Title GEOPHYSICAL SURVEY - WELLINGTON ROAD RAUNDS		Job No. 1926
Subject PLOT OF RAW MAGNETOMETER DATA		
 <b>STRATASCAN™</b> GEOPHYSICS FOR ARCHAEOLOGY AND ENGINEERING VINEYARD HOUSE UPPER HOOK ROAD UPTON UPON SEVERN UK WR8 0SA T: +44 (0)1684 592266 F: +44 (0)1684 594142 E: info@stratascan.co.uk www.stratascan.co.uk		
Scale 1:1000		
Plot A3	Checked by DJS	Issue No. 01
Survey date OCT 04	Drawn by LB	Figure No. 03



Amendments		
Issue No.	Date	Description
-	-	-
-	-	-

<p>Plotting parameters</p> <p>Maximum +18.39nT (black) Minimum -22.61nT (white)</p>	
Client	ASC

Project Title	GEOPHYSICAL SURVEY - WELLINGTON ROAD RAUNDS	Job No.	1926
Subject	PLOT OF RAW MAGNETOMETER DATA - AREA 2		

**STRATASCAN™**  
 GEOPHYSICS FOR ARCHAEOLOGY  
 AND ENGINEERING  
 VINEYARD HOUSE  
 UPPER HOOK ROAD  
 UPTON UPON SEVERN  
 UK  
 WR8 0SA  
 T: +44 (0)1684 592266  
 F: +44 (0)1684 594142  
 E: info@stratascan.co.uk  
 www.stratascan.co.uk

Scale	1:1000				
Plot	A3	Checked by	DJS	Issue No.	01
Survey date	OCT 04	Drawn by	LB	Figure No.	04



Amendments		
Issue No.	Date	Description
-	-	-
-	-	-

Plotting parameters	200nT
+40nT	160nT
(Positive values displace above the trace line. Hidden values have not been plotted)	120nT
	80nT
	40nT
	0nT

Client	ASC
--------	-----


Project Title	Job No.
GEOPHYSICAL SURVEY - WELLINGTON ROAD RAUNDS	1926

Subject	TRACE PLOT OF RAW MAGNETOMETER DATA SHOWING POSITIVE VALUES
---------	---

**STRATASCAN™**  
 GEOPHYSICS FOR ARCHAEOLOGY  
 AND ENGINEERING  
 VINEYARD HOUSE  
 UPPER HOOK ROAD  
 UPTON UPON SEVERN  
 UK  
 WR8 0SA  
 T: +44 (0)1684 592266  
 F: +44 (0)1684 594142  
 E: info@stratascan.co.uk  
 www.stratascan.co.uk



Scale	0m 10 20 30 40m	
1:1000		

Plot	Checked by	Issue No.
A3	DJS	01
Survey date	Drawn by	Figure No.
OCT 04	LB	05



Amendments		
Issue No.	Date	Description
-	-	-
-	-	-
-	-	-

Plotting parameters	-200nT
-40nT	-160nT
(Negative values displace above the trace line. Hidden values have not been plotted)	-120nT
	-80nT
	-40nT
	0nT

Client	ASC
--------	-----

Project Title	Job No.
GEOPHYSICAL SURVEY - WELLINGTON ROAD RAUNDS	1926

Subject	TRACE PLOT OF RAW MAGNETOMETER DATA SHOWING NEGATIVE VALUES
---------	---


**STRATASCAN™**  
 GEOPHYSICS FOR ARCHAEOLOGY  
 AND ENGINEERING  
 VINEYARD HOUSE  
 UPPER HOOK ROAD  
 UPTON UPON SEVERN  
 UK  
 WR8 0SA  
 T: +44 (0)1684 592266  
 F: +44 (0)1684 594142  
 E: info@stratascan.co.uk  
 www.stratascan.co.uk

Scale	0m 10 20 30 40m	
1:1000		

Plot	Checked by	Issue No.
A3	DJS	01
Survey date	Drawn by	Figure No.
OCT 04	LB	06



Amendments		
Issue No.	Date	Description
-	-	-
-	-	-

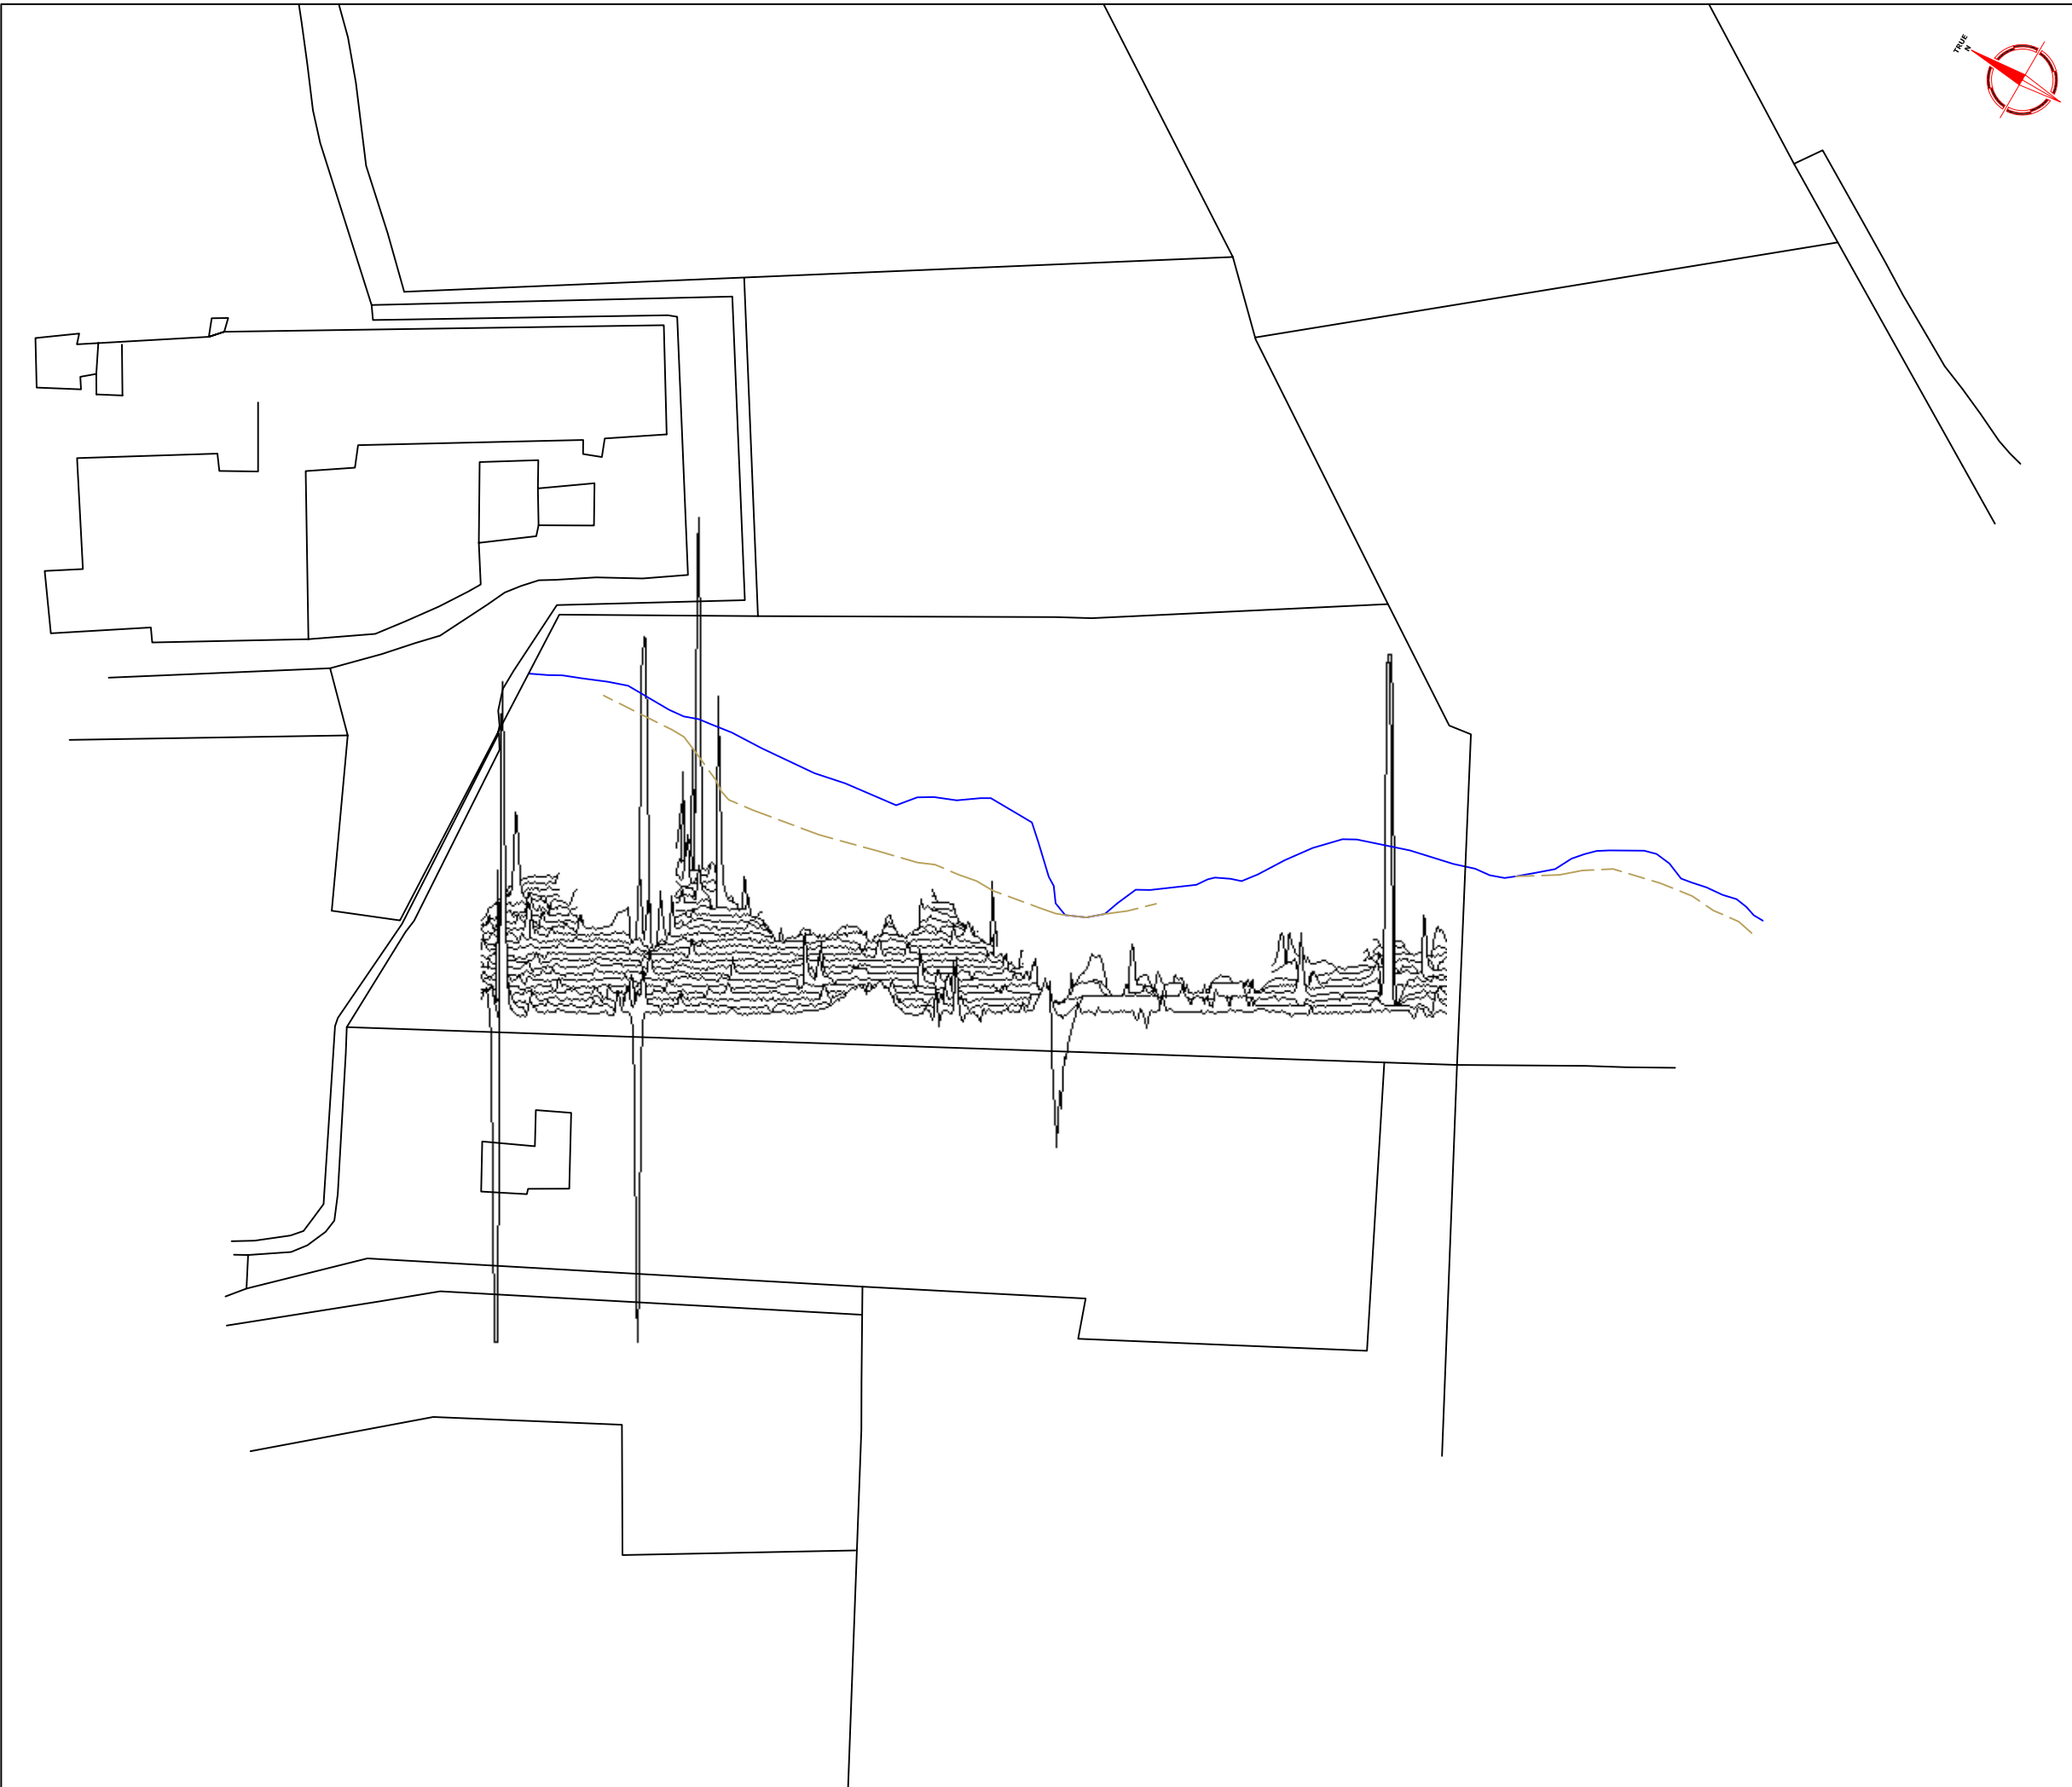Plotting parameters	200nT
+40nT	160nT
(Positive values displace above the trace line. Hidden values have not been plotted)	120nT
	80nT
	40nT
	0nT

Client	ASC
--------	-----

Project Title	Job No.	1926
GEOPHYSICAL SURVEY - WELLINGTON ROAD RAUNDS		

Subject	TRACE PLOT OF RAW MAGNETOMETER DATA SHOWING POSITIVE VALUES - AREA 2
---------	--

**STRATASCAN™**  
 GEOPHYSICS FOR ARCHAEOLOGY  
 AND ENGINEERING  
 VINEYARD HOUSE  
 UPPER HOOK ROAD  
 UPTON UPON SEVERN  
 UK  
 WR8 0SA  
 T: +44 (0)1684 592266  
 F: +44 (0)1684 594142  
 E: info@stratascan.co.uk  
 www.stratascan.co.uk

Scale	1:1000	
	0m 10 20 30 40m	

Plot	Checked by	Issue No.
A3	DJS	01
Survey date	Drawn by	Figure No.
OCT 04	LB	07



Amendments		
Issue No.	Date	Description
-	-	-
-	-	-
-	-	-

Plotting parameters	-200nT
-40nT	-160nT
(Negative values displace above the trace line. Hidden values have not been plotted)	-120nT
	-80nT
	-40nT
	0nT

Client	ASC
--------	-----

Project Title	Job No.	1926
GEOPHYSICAL SURVEY - WELLINGTON ROAD RAUNDS		

Subject	TRACE PLOT OF RAW MAGNETOMETER DATA SHOWING NEGATIVE VALUES - AREA 2
---------	--

**STRATASCAN™**  
 GEOPHYSICS FOR ARCHAEOLOGY  
 AND ENGINEERING  
 VINEYARD HOUSE  
 UPPER HOOK ROAD  
 UPTON UPON SEVERN  
 UK  
 WR8 0SA  
 T: +44 (0)1684 592266  
 F: +44 (0)1684 594142  
 E: info@stratascan.co.uk  
 www.stratascan.co.uk

Scale	0m 10 20 30 40m	
	<b>1:1000</b>	

Plot	Checked by	Issue No.
A3	DJS	01
Survey date	Drawn by	Figure No.
OCT 04	LB	08





Amendments		
Issue No.	Date	Description
-	-	-
-	-	-

Plotting parameters

Maximum +3nT (black)  
Minimum -3nT (white)

Client  
**ASC**

Project Title **GEOPHYSICAL SURVEY - WELLINGTON ROAD RAUNDS** Job No. **1926**

Subject  
**PLOT OF PROCESSED MAGNETOMETER DATA - AREA 1**

**STRATASCAN™**  
GEOPHYSICS FOR ARCHAEOLOGY  
AND ENGINEERING  
VINEYARD HOUSE  
UPPER HOOK ROAD  
UPTON UPON SEVERN  
UK  
WR8 0SA  
T: +44 (0)1684 592266  
F: +44 (0)1684 594142  
E: info@stratascan.co.uk  
www.stratascan.co.uk

Scale **1:1000**

Plot <b>A3</b>	Checked by <b>DJS</b>	Issue No. <b>01</b>
Survey date <b>OCT 04</b>	Drawn by <b>LB</b>	Figure No. <b>09</b>




Amendments		
Issue No.	Date	Description
-	-	-
-	-	-

<p>Plotting parameters</p> <p>Maximum +3nT (black) Minimum -3nT (white)</p> <p>-3SD                      +3SD</p>	<p>+3nT</p> <p>-3nT</p>
---	-------------------------

Client	ASC	
Project Title	GEOPHYSICAL SURVEY - WELLINGTON ROAD RAUNDS	Job No. 1926
Subject	PLOT OF PROCESSED MAGNETOMETER DATA - AREA 2	
<p><b>STRATASCAN™</b> GEOPHYSICS FOR ARCHAEOLOGY AND ENGINEERING VINEYARD HOUSE UPPER HOOK ROAD UPTON UPON SEVERN UK WR8 0SA T: +44 (0)1684 592266 F: +44 (0)1684 594142 E: info@stratascan.co.uk www.stratascan.co.uk</p>		
Scale	1:1000	
Plot	A3	Checked by DJS
		Issue No. 01
Survey date	OCT 04	Drawn by LB
		Figure No. 10

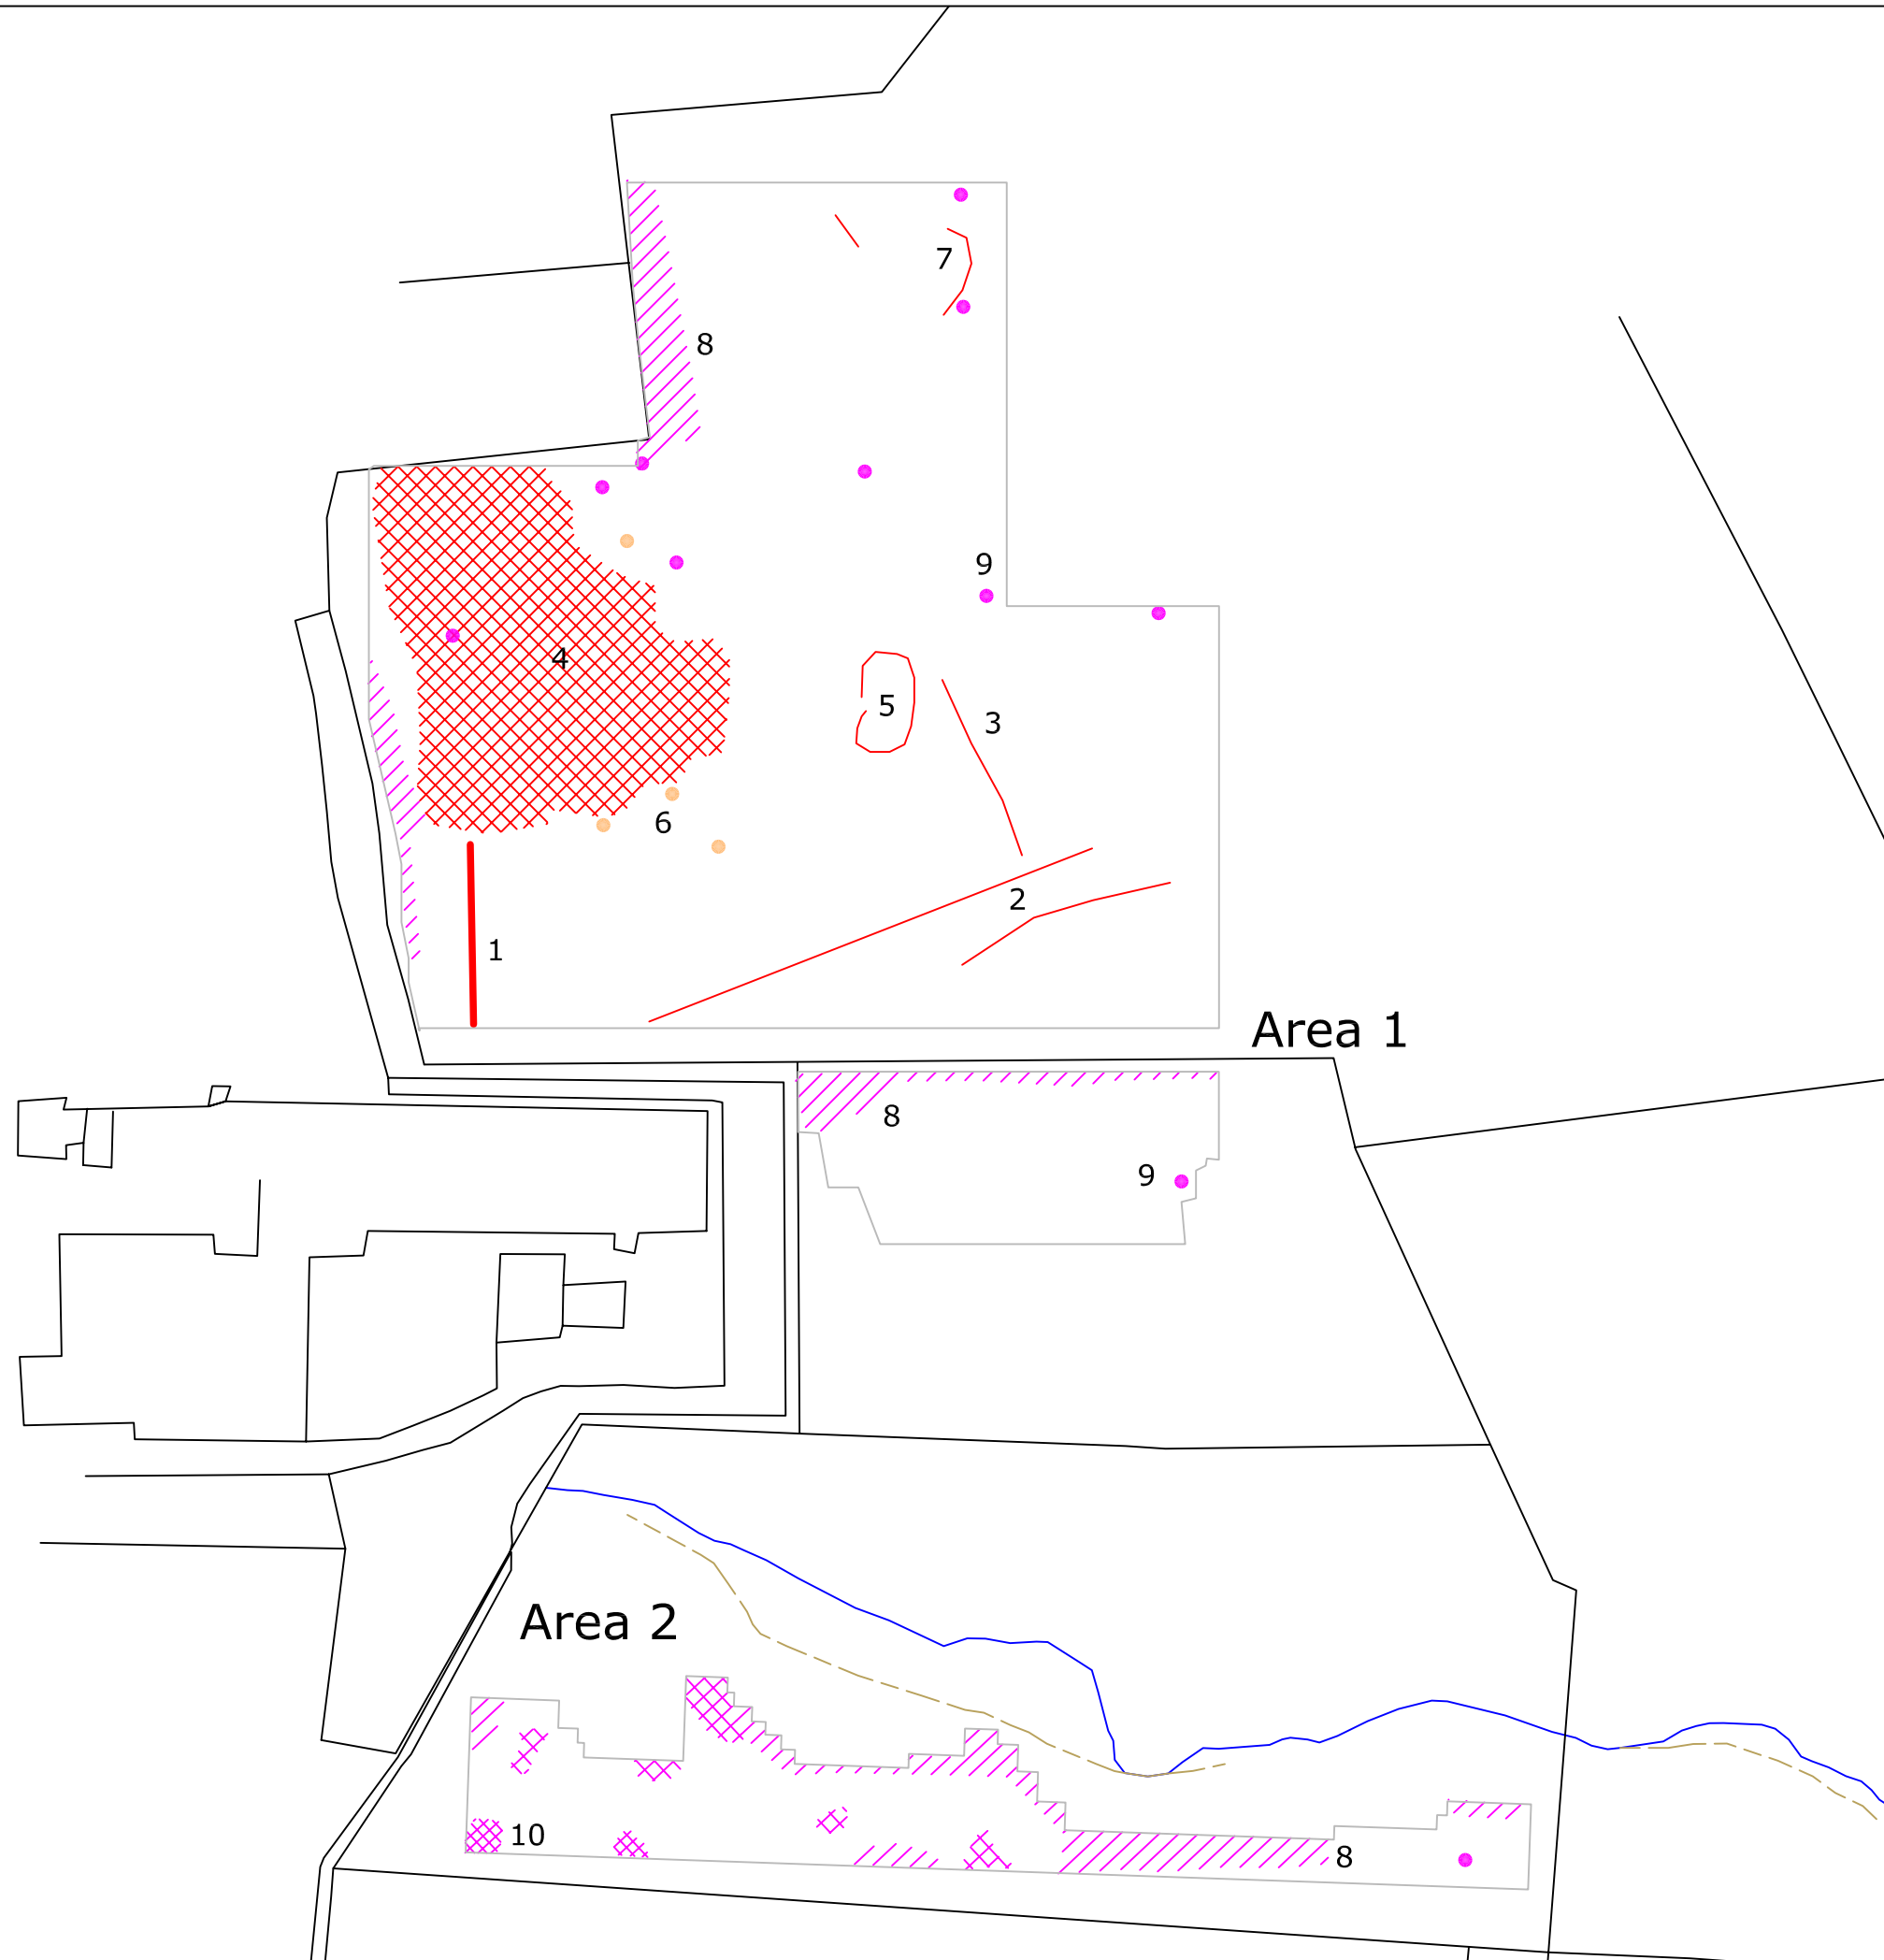

Amendments		
Issue No.	Date	Description
-	-	-
-	-	-
<b>KEY</b>		
	Positive linear anomaly - cut feature with possible archaeological origin	
	Positive area anomaly - possible quarry site?	
	Discrete low magnitude positive response - possible pit	
	Area of magnetic debris	
	Area of magnetic disturbance due to metal fencing	
	Strong discrete positive anomaly with negative return - ferrous object	
5	Anomaly code	
Client		
ASC		
Project Title		Job No. 1926
GEOPHYSICAL SURVEY - WELLINGTON ROAD RAUNDS		
Subject		
ABSTRACTION AND INTERPRETATION OF MAGNETOMETER ANOMALIES		
<b>STRATASCAN™</b>		
GEOPHYSICS FOR ARCHAEOLOGY AND ENGINEERING		
VINEYARD HOUSE UPPER HOOK ROAD UPTON UPON SEVERN UK		
WR8 0SA T: +44 (0)1684 592266 F: +44 (0)1684 594142 E: info@stratascan.co.uk www.stratascan.co.uk		
Scale	1:1000	
Plot	Checked by	Issue No.
A3	DJS	01
Survey date	Drawn by	Figure No.
OCT 04	LB/KTD	11