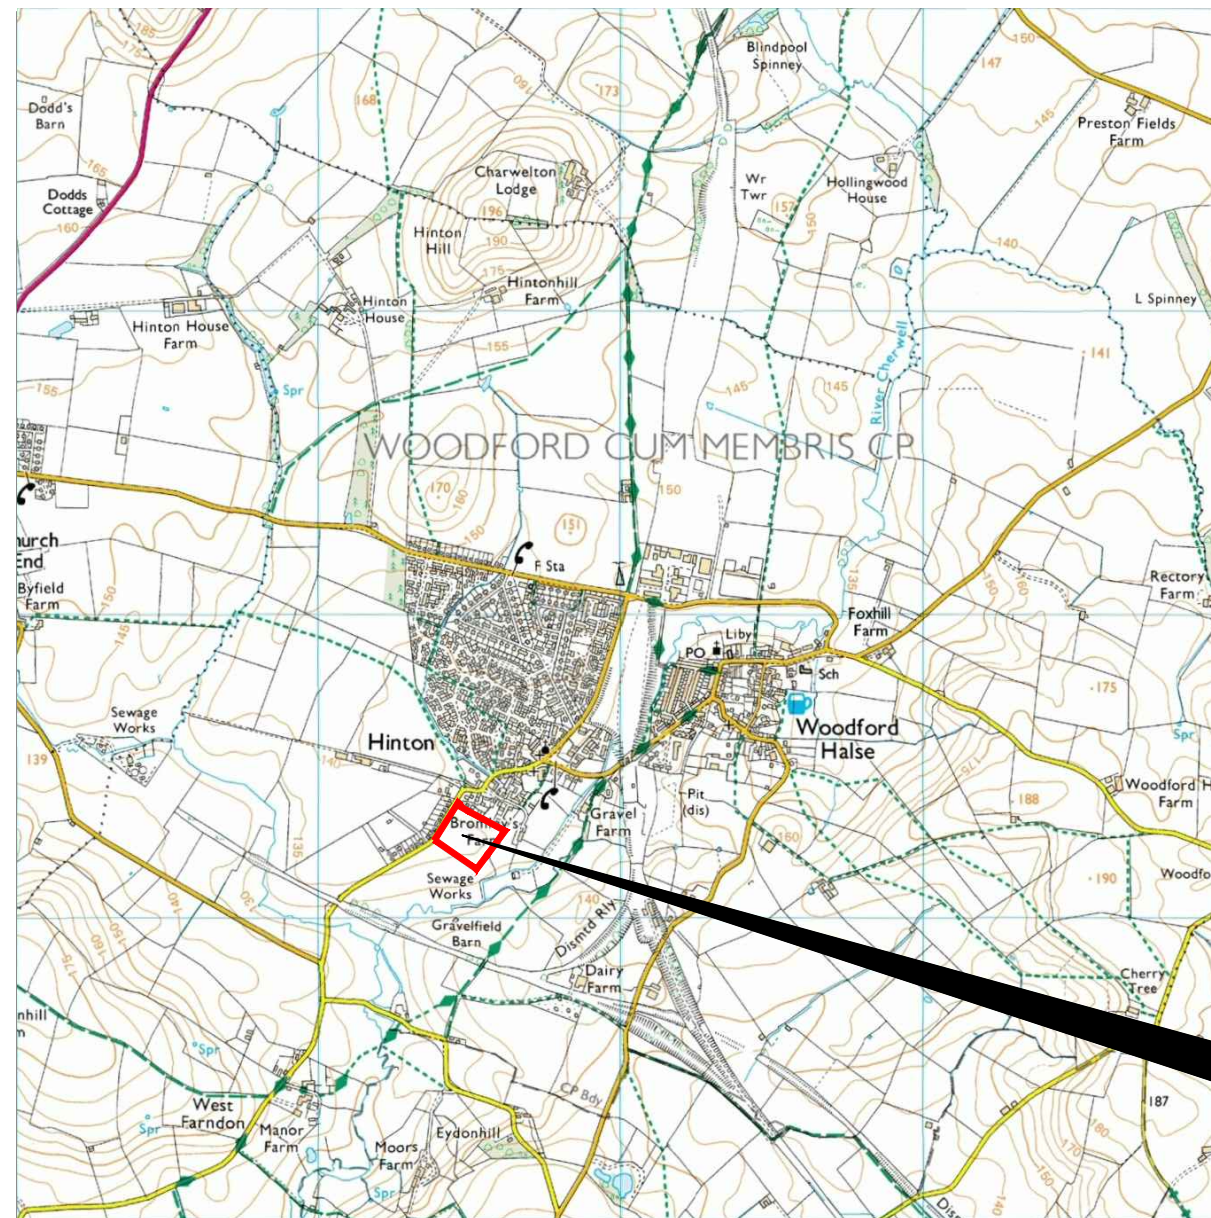


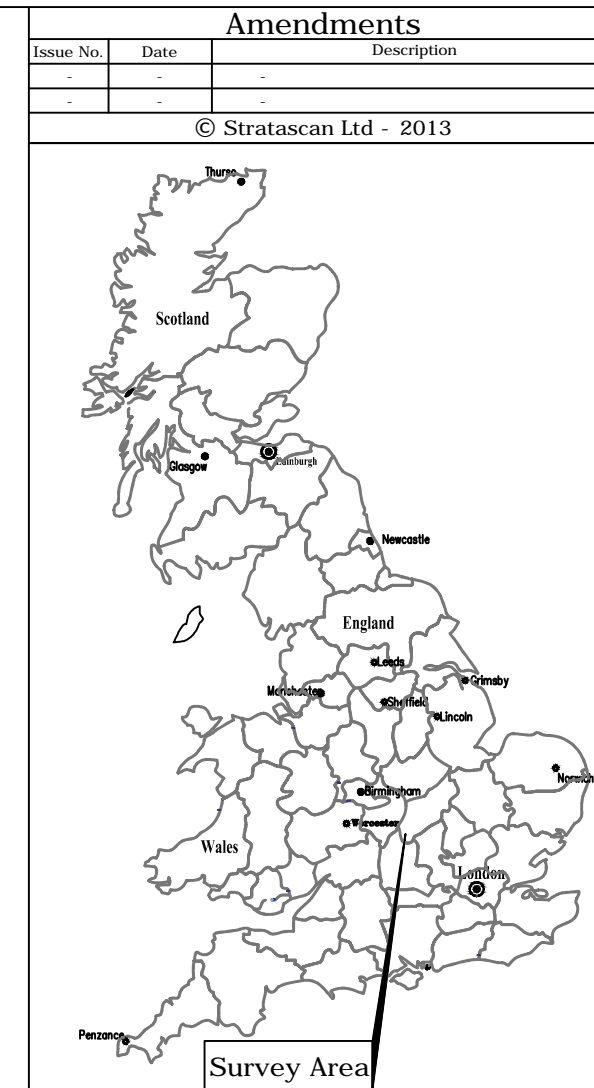
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 Vineyard House
 Upper Hook Road
 Upton Upon Severn
 WR8 0SA
 OS 100km square = SP



55
 54
 53
 52
 51



52 53 54 55 56



Site centred on NGR **SP 534 522**

Client
CgMs CONSULTING LTD

Project Title **GEOPHYSICAL SURVEY: FARNDON ROAD, HINTON, NORTHANTS** Job No. **5987**

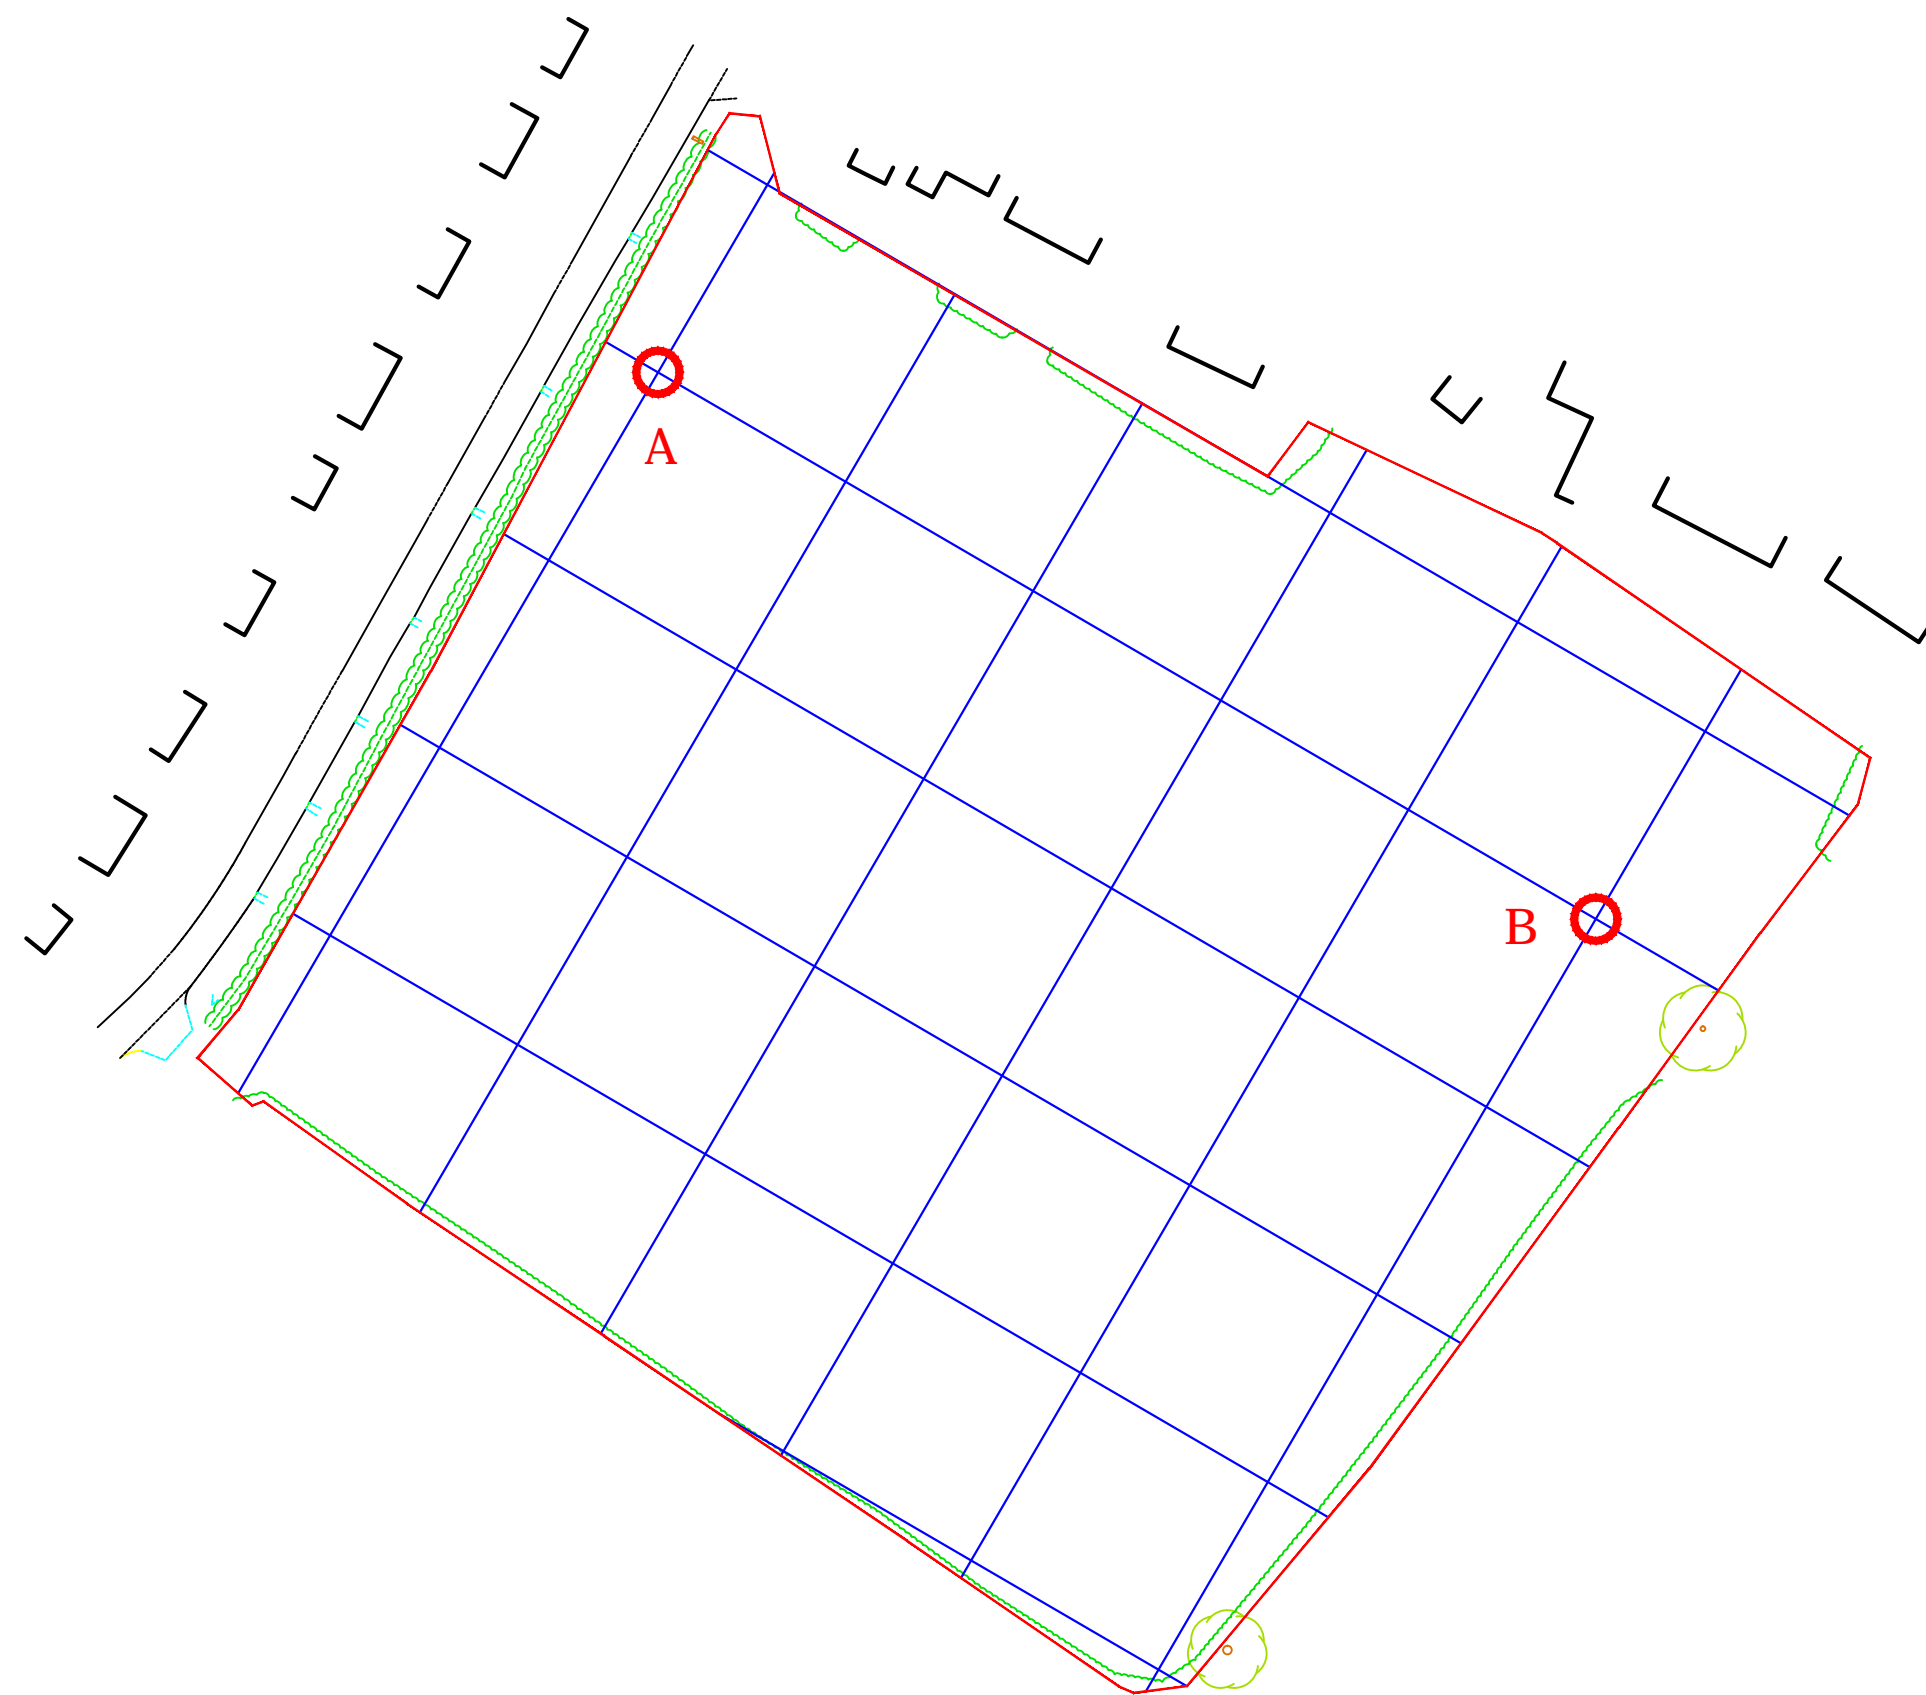
Subject
LOCATION PLAN OF SURVEY AREA

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 UPTON UPON SEVERN E: info@stratascan.co.uk
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Scale **1:25000**
 0m 500 1000m

Plot A3	Checked by PPB	Issue No. 01
Survey date OCT 2013	Drawn by OJP	Figure No. 01



Amendments

Issue No.	Date	Description
-	-	-
-	-	-

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KEY

	Survey area
	Survey grid
	GPS referencing point

OS GRID REFERENCES

A	453450.02, 252341.51
B	453579.62, 252265.99

Client
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Project Title Job No. 5987
GEOPHYSICAL SURVEY: FARNDON ROAD, HINTON, NORTHANTS

Subject
GENERAL SITE PLAN

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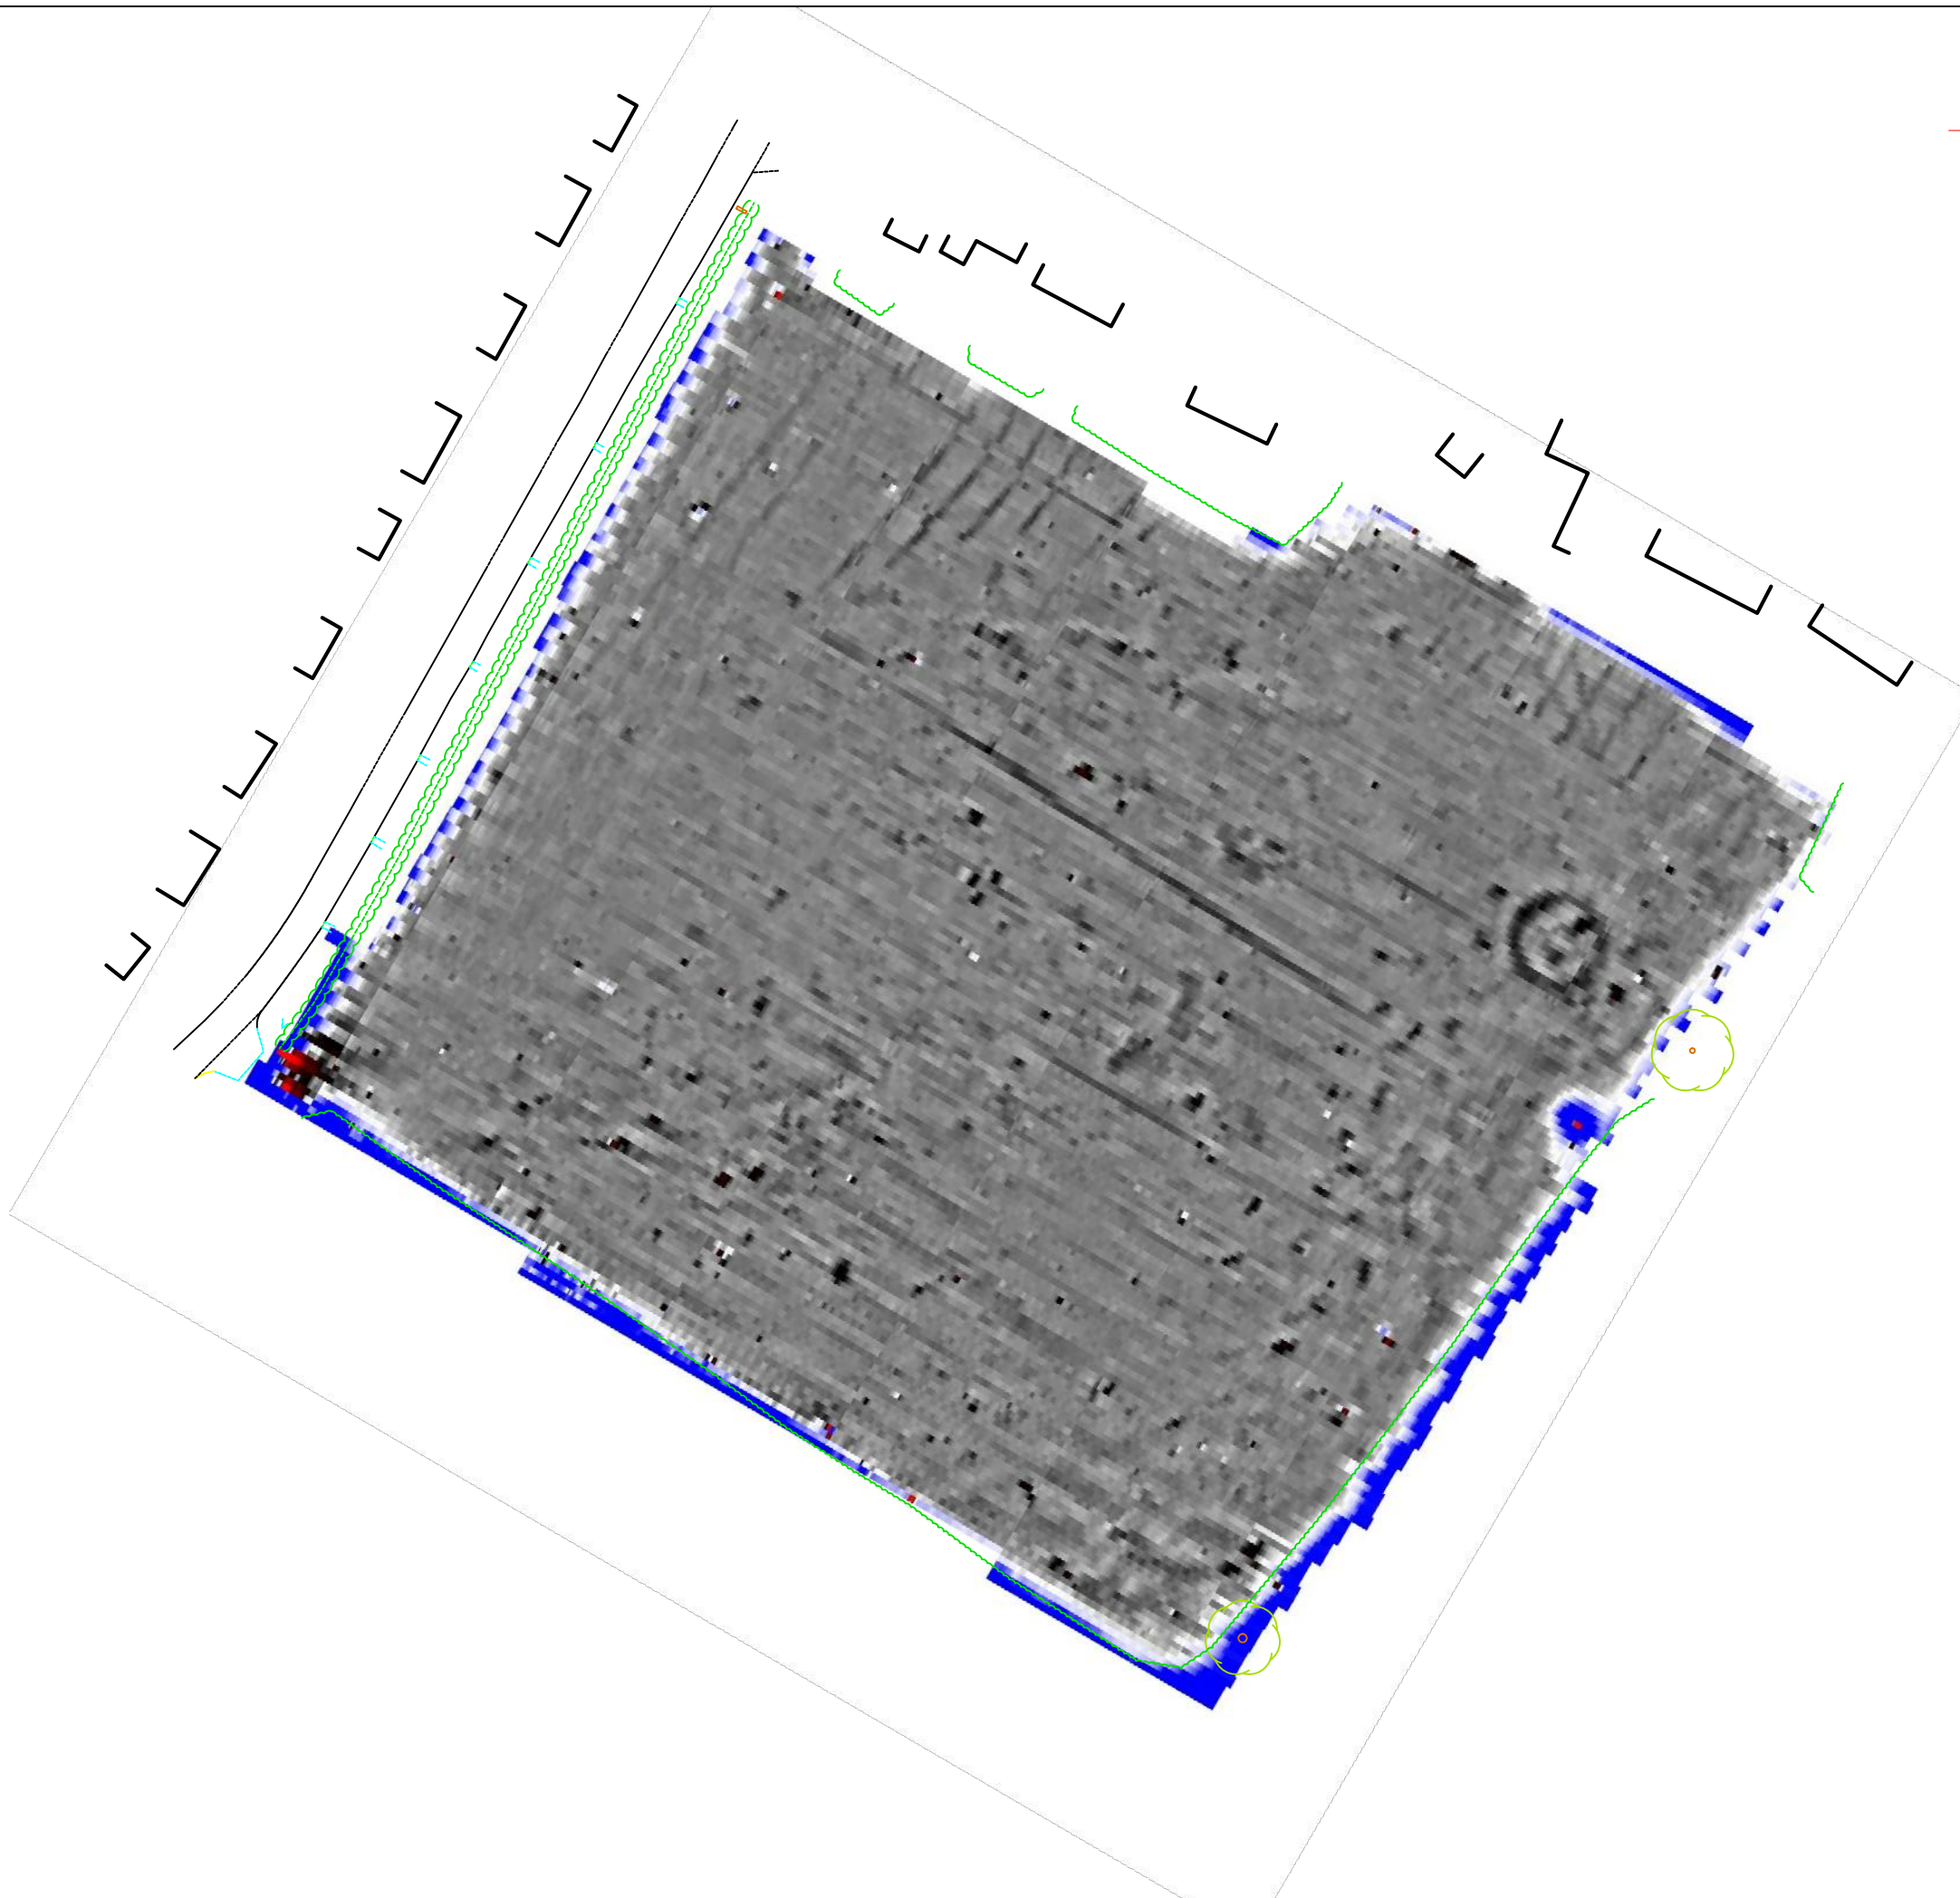


SUMO GROUP MEMBER



Scale 1:1000

Plot A3	Checked by PPB	Issue No. 01
Survey date OCT 2013	Drawn by OJP	Figure No. 02



Amendments

Issue No.	Date	Description
-	-	-
-	-	-

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Plotting parameters

Maximum + 100nT (red)
Minimum -100nT (blue)

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GEOPHYSICAL SURVEY: FARNDON ROAD, HINTON, NORTHANTS

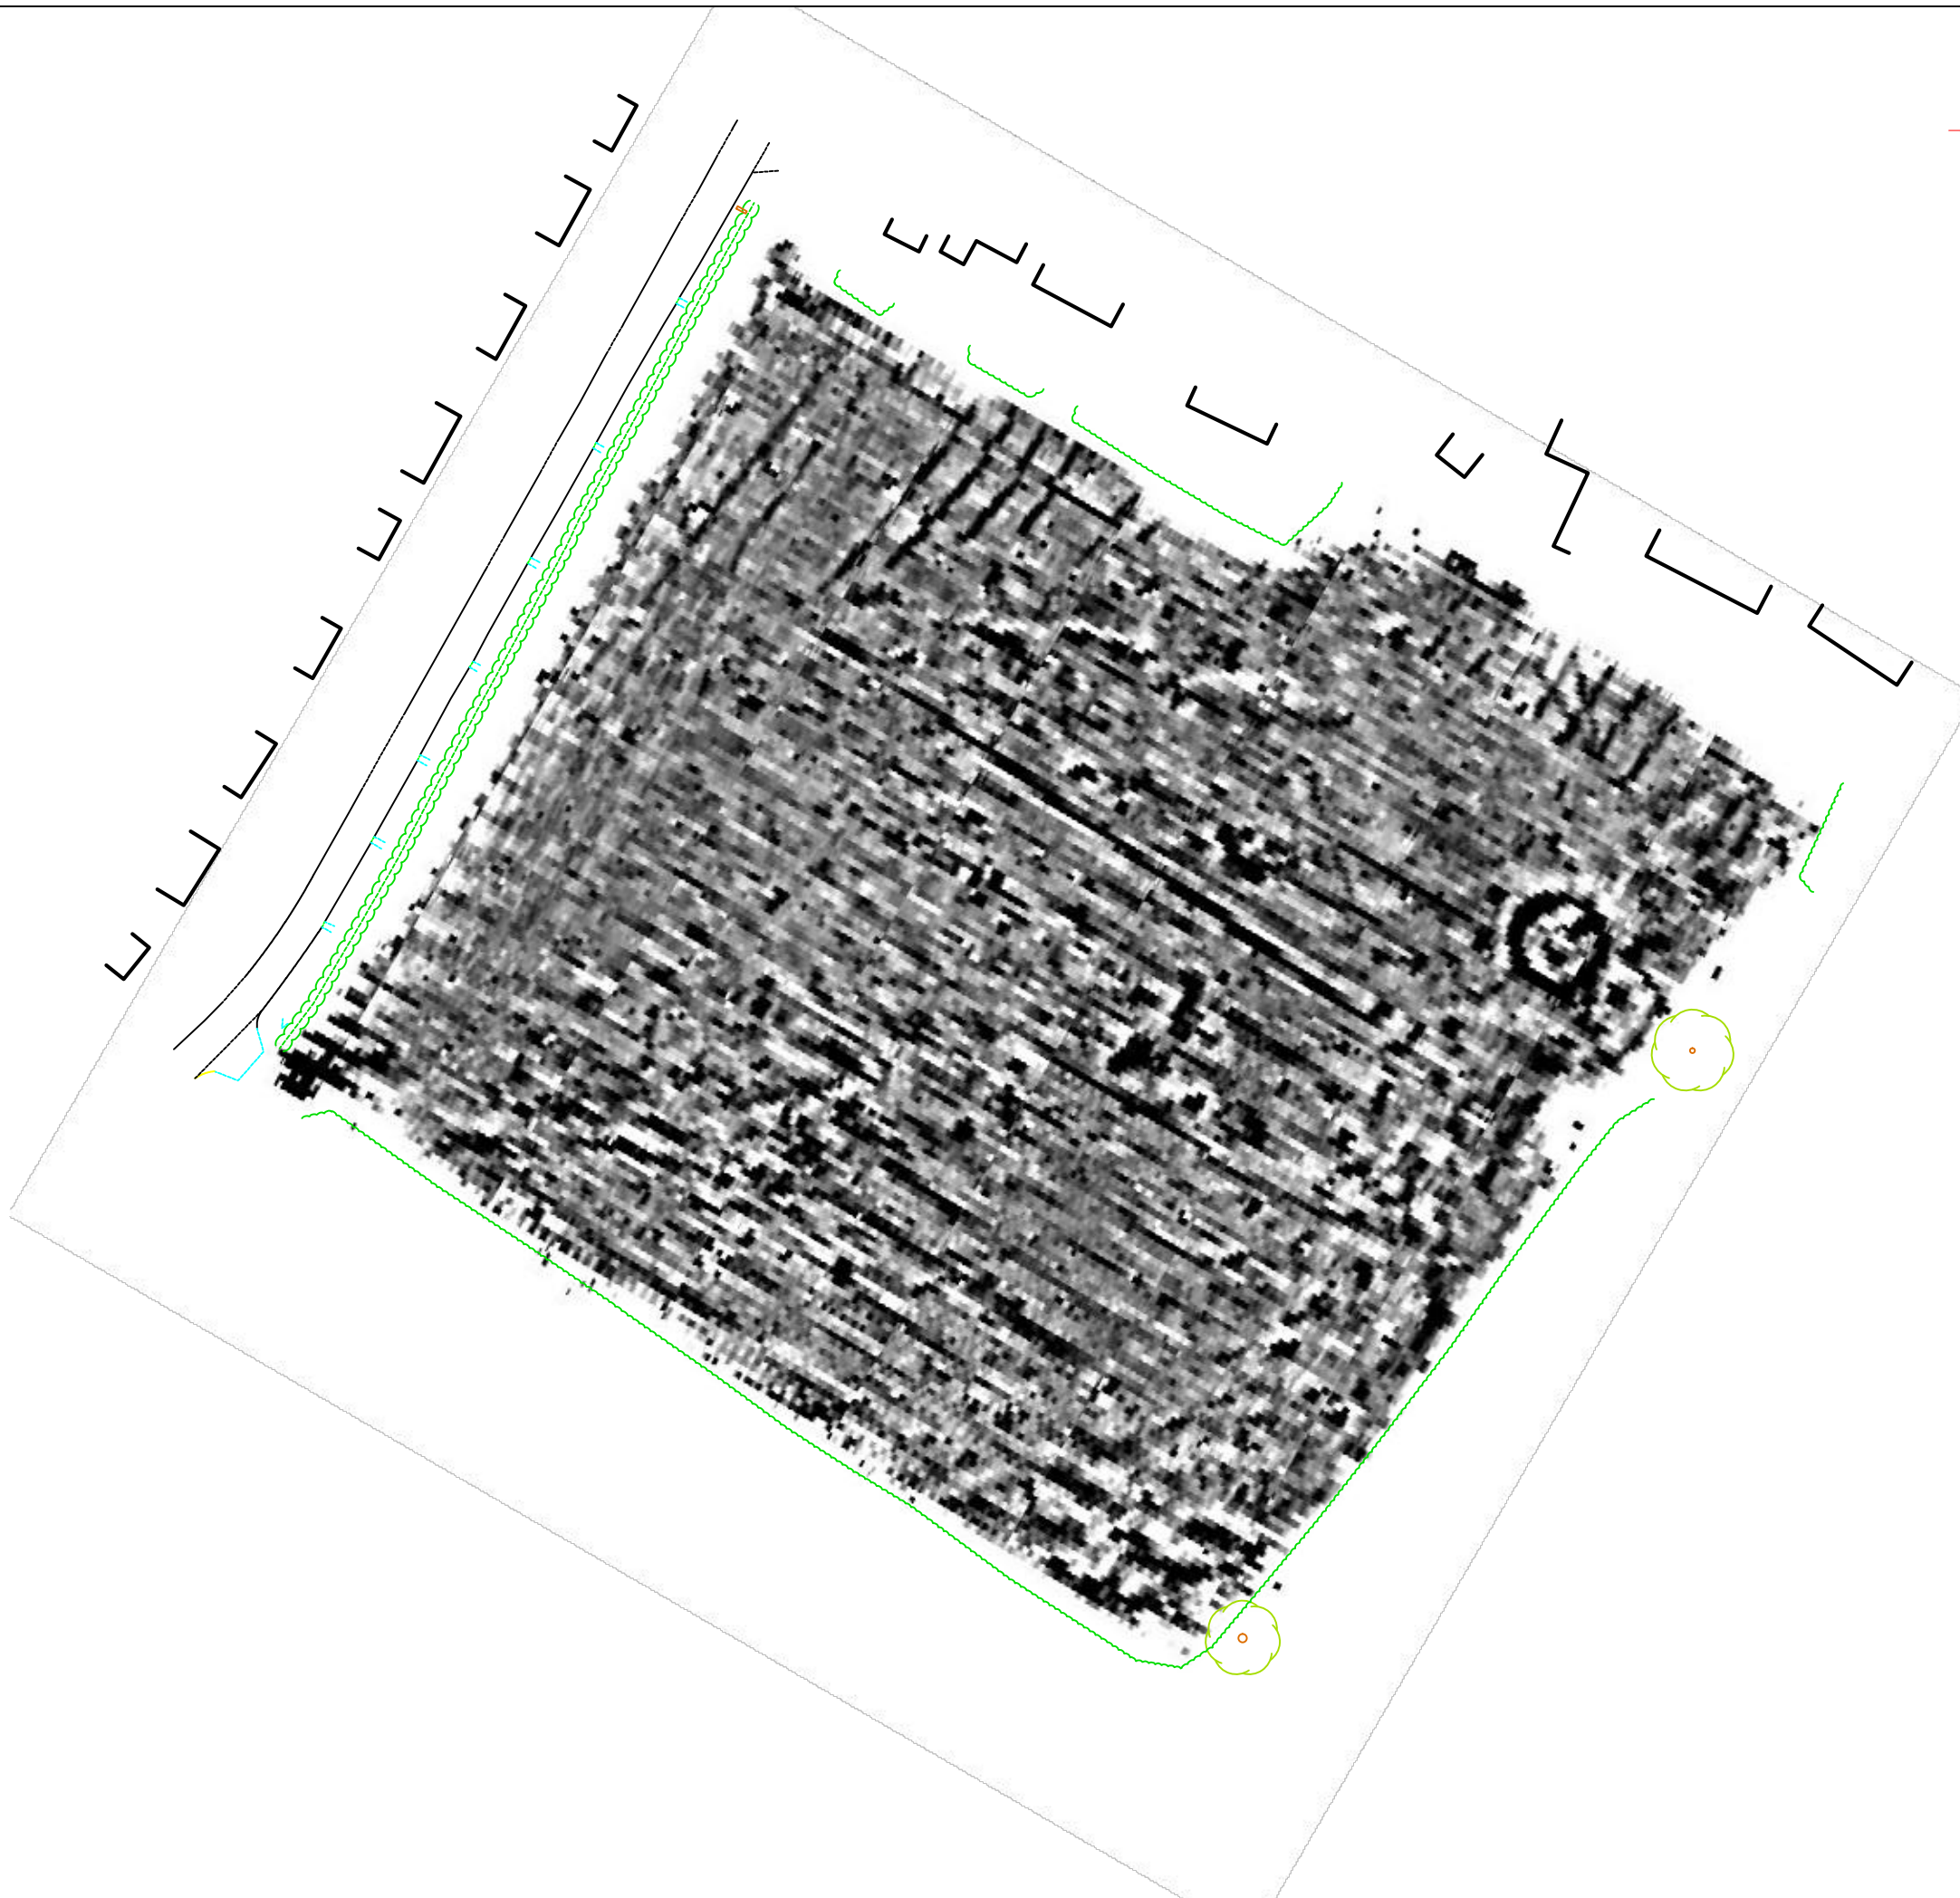
Subject
COLOUR PLOT OF GRADIOMETER DATA SHOWING EXTREME VALUES

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Scale 1: 1000

Plot A3	Checked by PPB	Issue No. 01
Survey date OCT 2013	Drawn by JHS	Figure No. 03



Amendments		
Issue No.	Date	Description
-	-	-
-	-	-
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Client	
CgMs CONSULTING LTD	
Project Title	Job No. 5987
GEOPHYSICAL SURVEY: FARNDON ROAD, HINTON, NORTHANTS	
Subject	
PLOT OF MINIMALLY PROCESSED GRADIOMETER DATA	

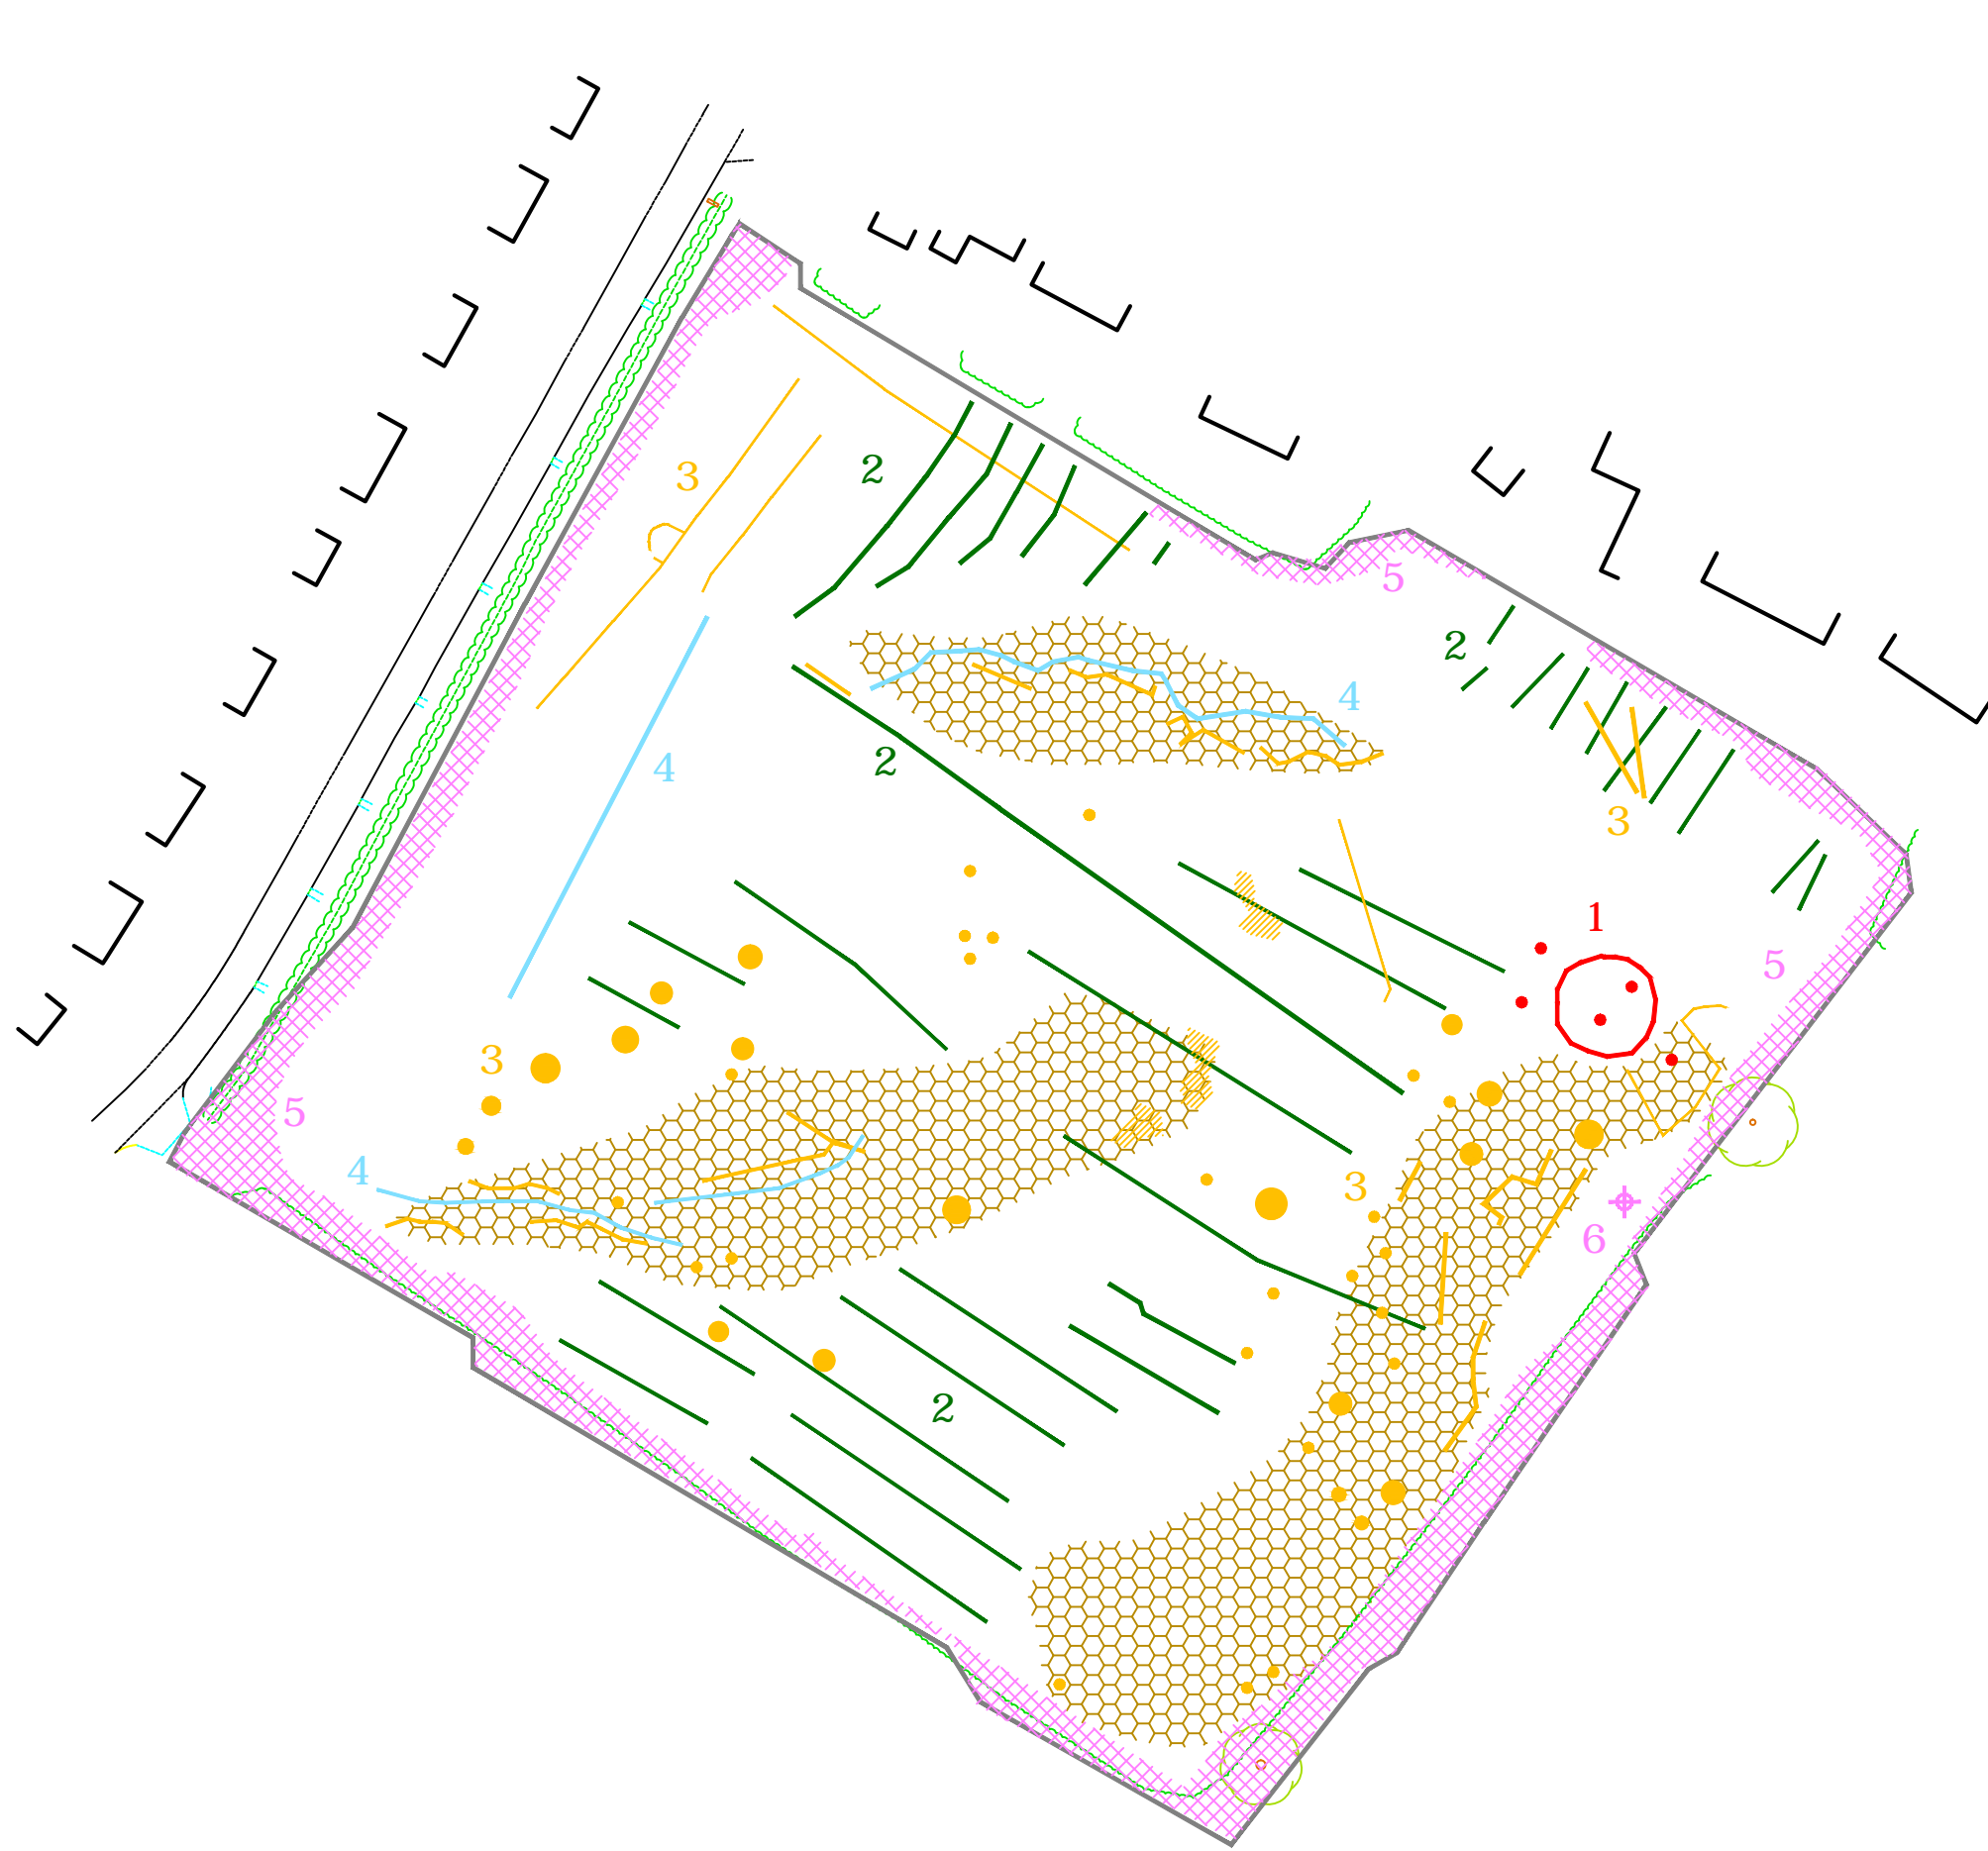
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Scale 1: 1000 0m 10 20 30 40 50

Plot	Checked by	Issue No.
A3	PPB	01
Survey date	Drawn by	Figure No.
OCT 2013	TH/BPM	04



Amendments		
Issue No.	Date	Description
-	-	-
-	-	-
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KEY		
PROBABLE ARCHAEOLOGY		
	Positive anomaly / weak positive anomaly - probable cut feature of archaeological origin	
	Negative anomaly / weak negative anomaly - probable bank or earthwork of archaeological origin	
	Moderate strength discrete anomaly - probable thermoremanent feature	
	Widely spaced curving parallel linear anomalies - probably related to ridge-and-furrow	
POSSIBLE ARCHAEOLOGY		
	Positive anomaly / weak positive anomaly - possible cut feature of archaeological origin	
	Negative anomaly / weak negative anomaly - possible bank or earthwork of archaeological origin	
	Moderate strength discrete anomaly - possible thermoremanent feature	
	Magnetic spike - probable ferrous object	
OTHER ANOMALIES		
	Closely spaced parallel linear anomalies - probably related to agricultural activity such as ploughing	
	Linear anomaly - probably related to pipe, cable or other modern service	
	Linear anomaly - possibly related to land drain	
	Magnetic disturbance associated with nearby metal object such as service or field boundary	
	Strong magnetic debris - possible disturbed or made ground	
	Scattered magnetic debris	
	Area of amorphous magnetic variation - probable natural (e.g. geological or pedological) origin	
Client		
CgMs CONSULTING LTD		
Project Title		Job No. 5987
GEOPHYSICAL SURVEY: FARNDON ROAD, HINTON, NORTHANTS		
Subject		
ABSTRACTION AND INTERPRETATION OF GRADIOMETER ANOMALIES		
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Scale		
1: 1000		
Plot	Checked by	Issue No.
A3	PPB	01
Survey date	Drawn by	Figure No.
OCT 2013	JHS	05