


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 Upper Hook Road
 Upton Upon Severn
 WR8 0SA
 OS 100km square = TF




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

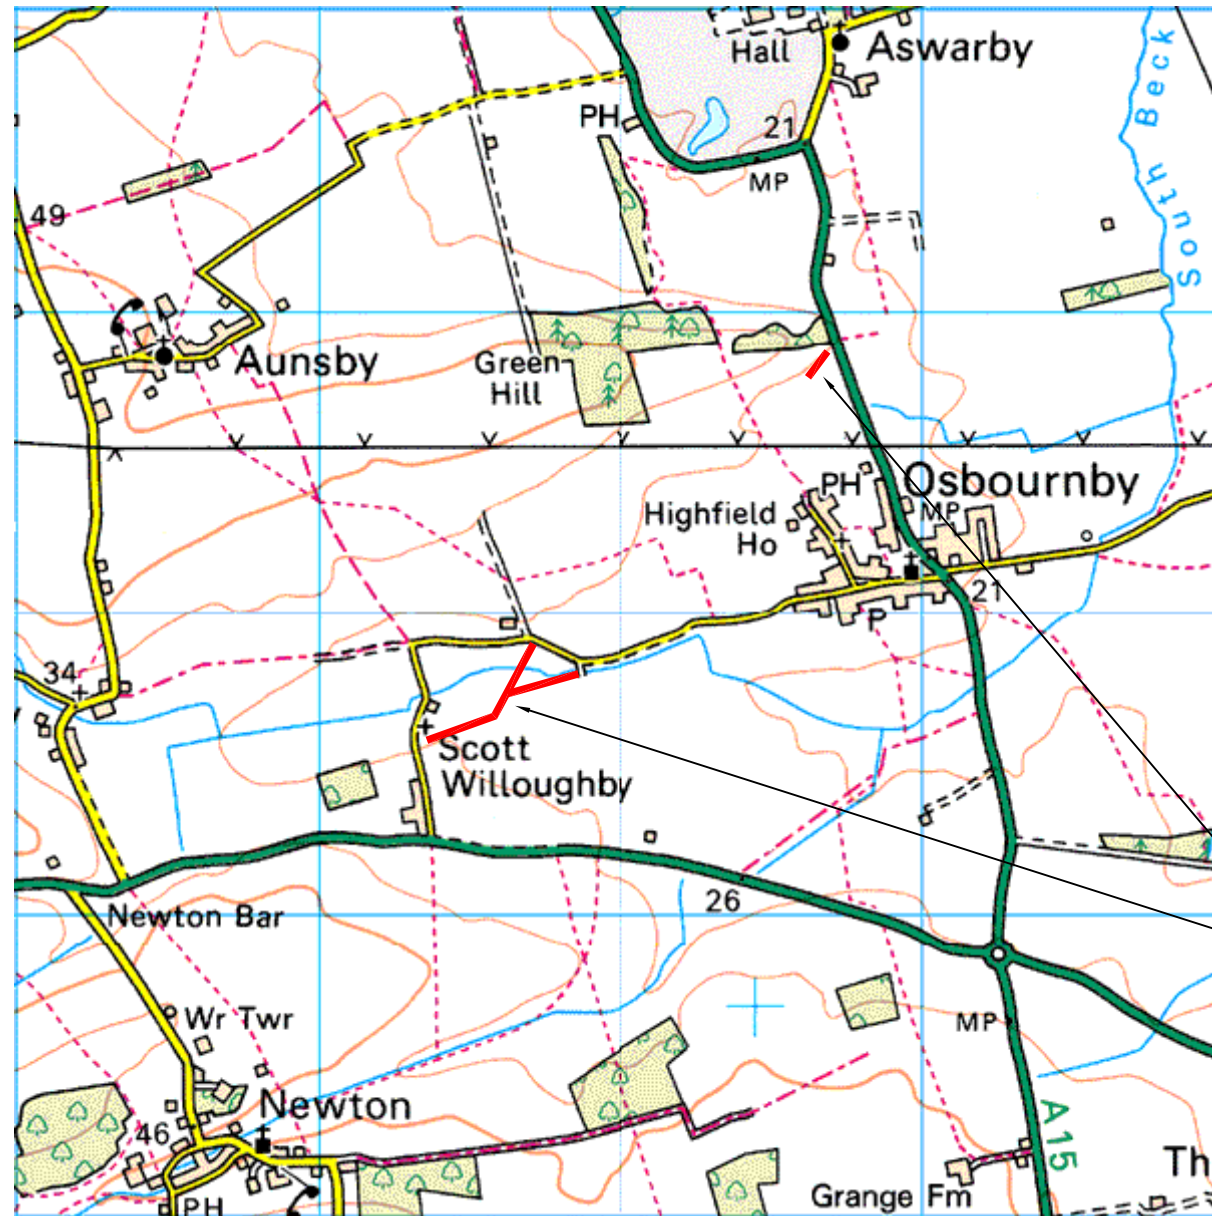


Survey Areas

04 05 06 07 08

Amendments		
Issue No.	Date	Description
-	-	-
Site centred on NGR		TF 061 382
Client		APS
Project Title	Job No.	1998
GEOPHYSICAL SURVEY - HARROWBY-ASWARBY PIPELINE		
Subject		
LOCATION PLAN OF SURVEY AREA		
GEOPHYSICS FOR ARCHAEOLOGY AND ENGINEERING VINEYARD HOUSE UPPER HOOK ROAD UPTON UPON SEVERN UK WR8 0SA T: +44 (0)1684 592266 F: +44 (0)1684 594142 E: info@stratascan.co.uk www.stratascan.co.uk		
Scale 1:25 000		
Plot	Checked by	Issue No.
A3	SAS	01
Survey date	Drawn by	Figure No.
APRIL 05	RAJS	01

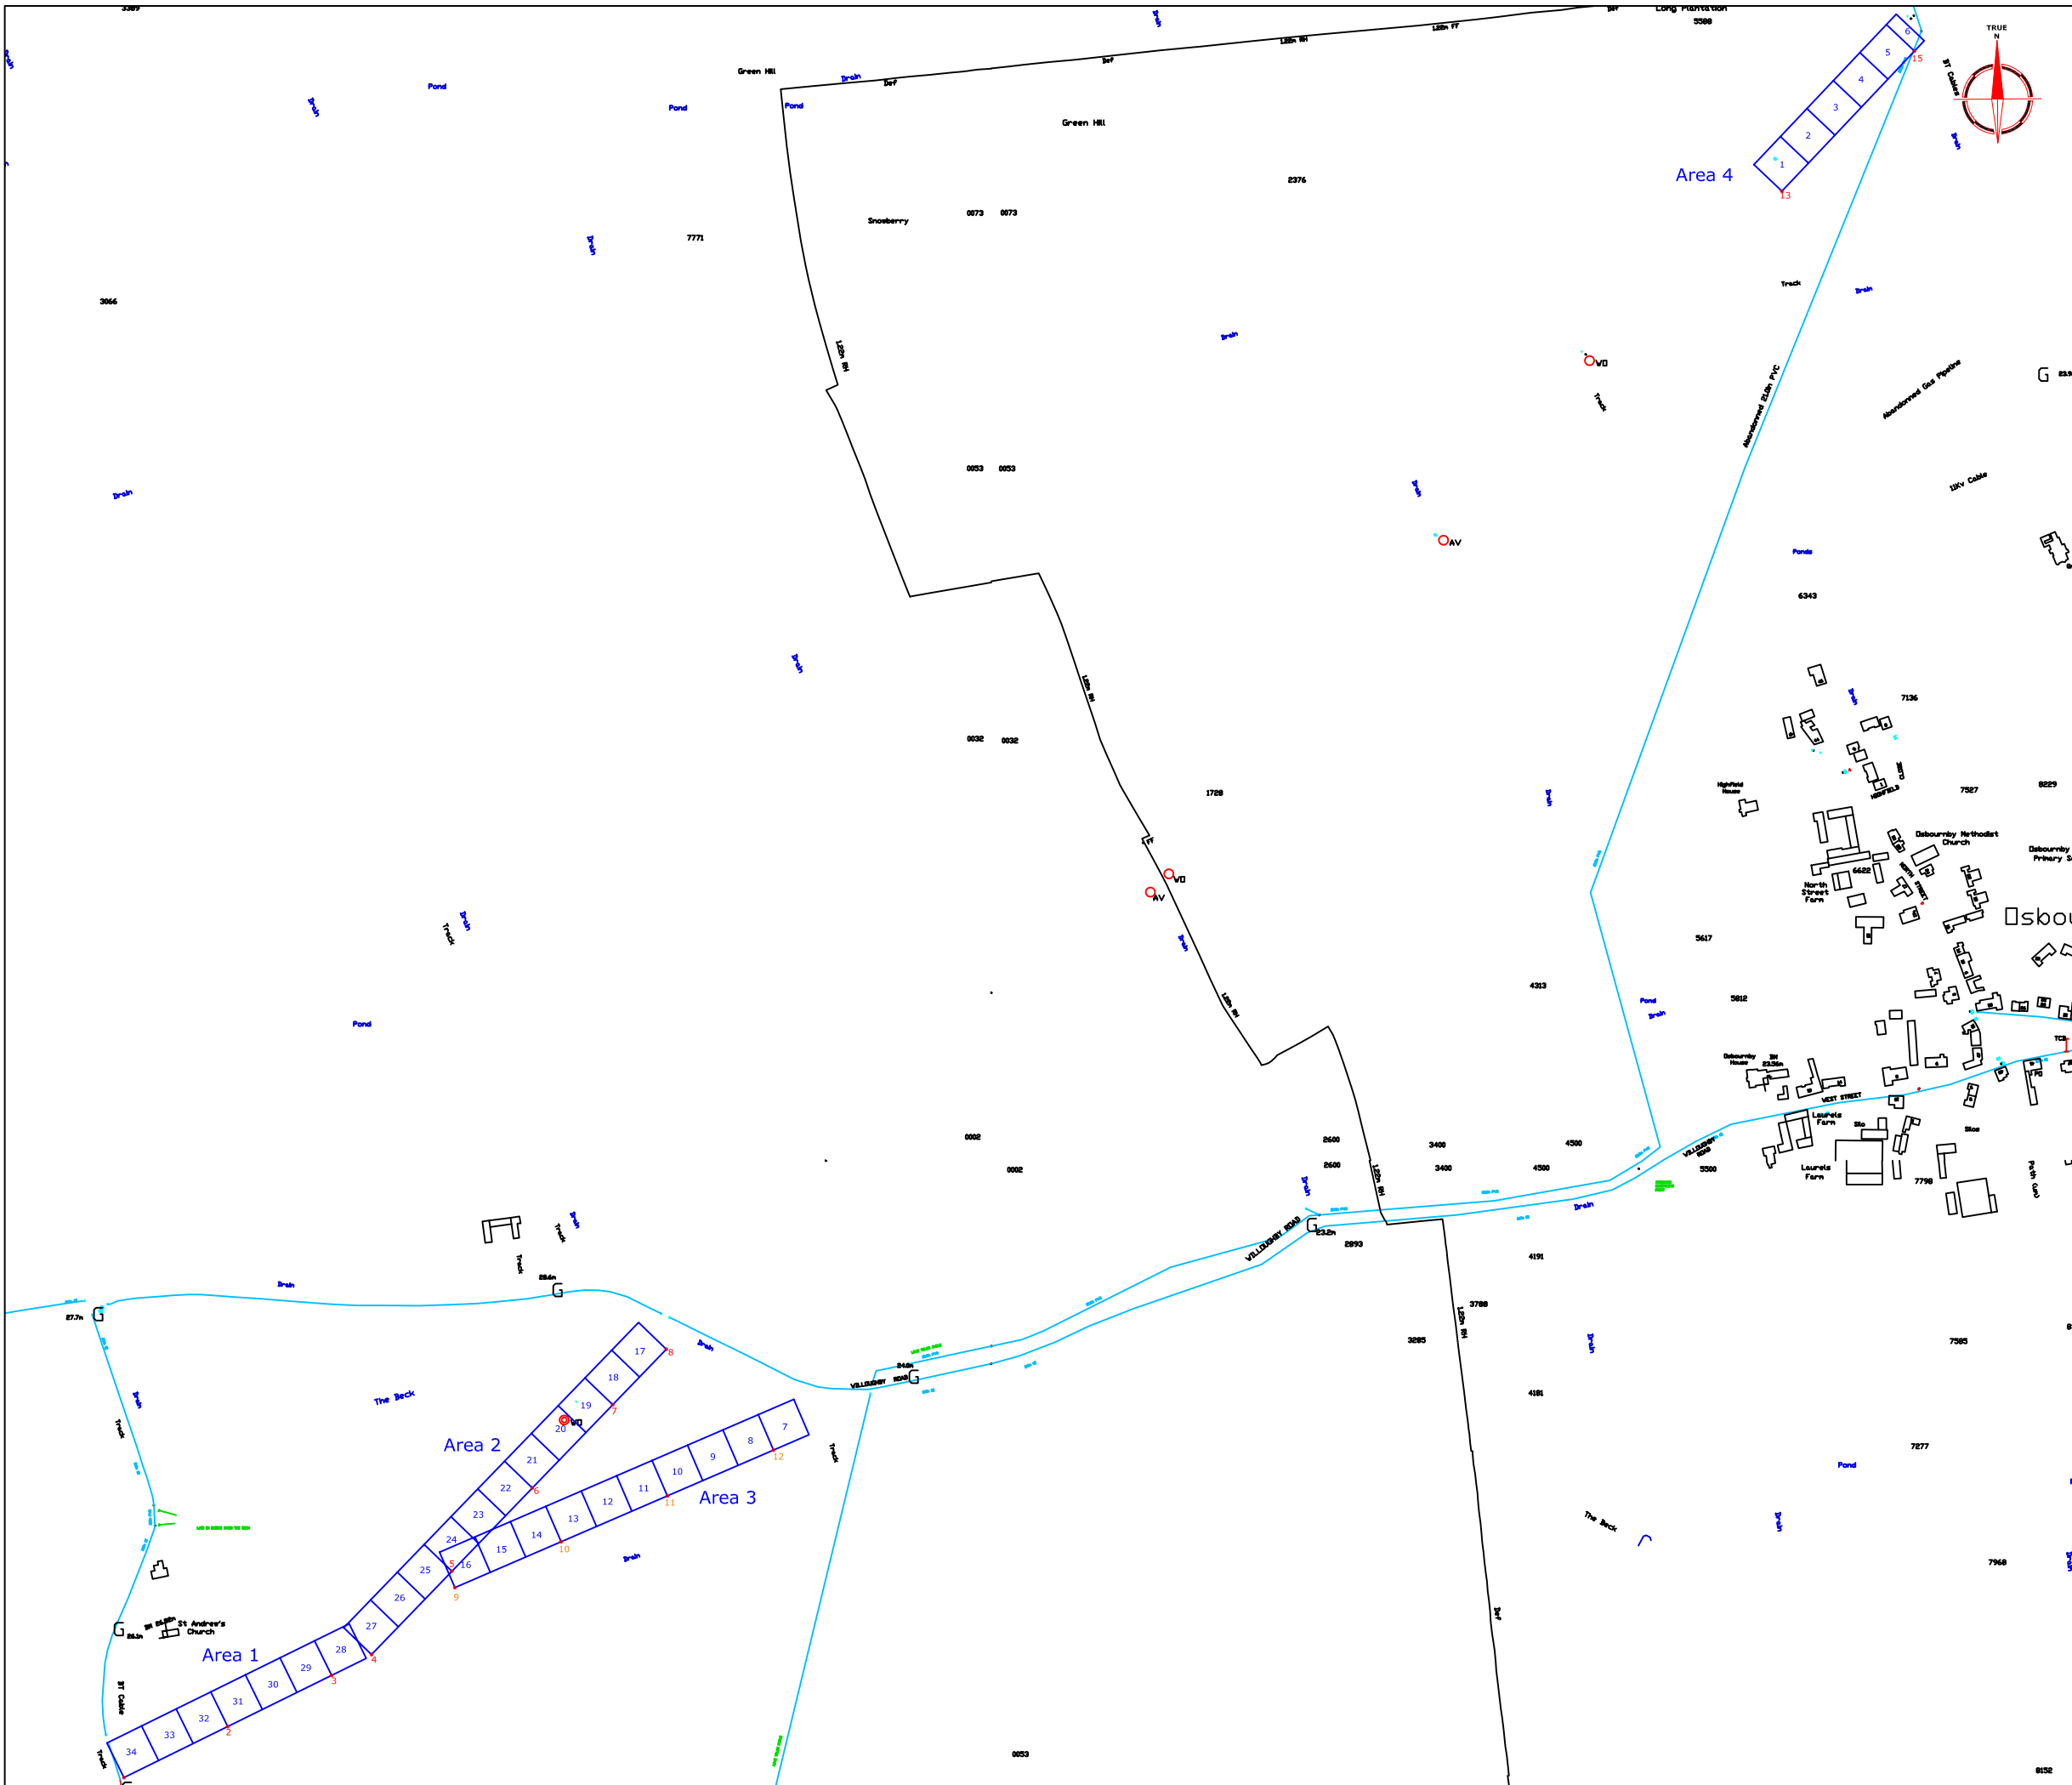

Amendments		
Issue No.	Date	Description
-	-	-
POINT I.D		OS GRID REFERENCE
1	505325.2	337520.2
3	505486.7	337599.7
4	505517.8	337616
8	505747	337853.3
9	505582.6	337668
12	505830.5	337774.9
13	506614.9	338753.7
15	506718	338862.6
10	OS point number	
2	Survey grid number	
Client		APS
Project Title		Job No. 1998
GEOPHYSICAL SURVEY - HARROWBY-ASWARBY PIPELINE		
Subject		SITE PLAN SHOWING LOCATION OF SURVEY GRIDS AND REFERENCING
 GEOPHYSICS FOR ARCHAEOLOGY AND ENGINEERING VINEYARD HOUSE UPPER HOOK ROAD UPTON UPON SEVERN UK WR8 0SA T: +44 (0)1684 592266 F: +44 (0)1684 594142 E: info@stratascan.co.uk www.stratascan.co.uk		
Scale	0m 50 100 150 200 250m	
1:5000		
Plot	Checked by	Issue No.
A3	PPB	01
Survey date	Drawn by	Figure No.
APRIL 05	RAJS	02

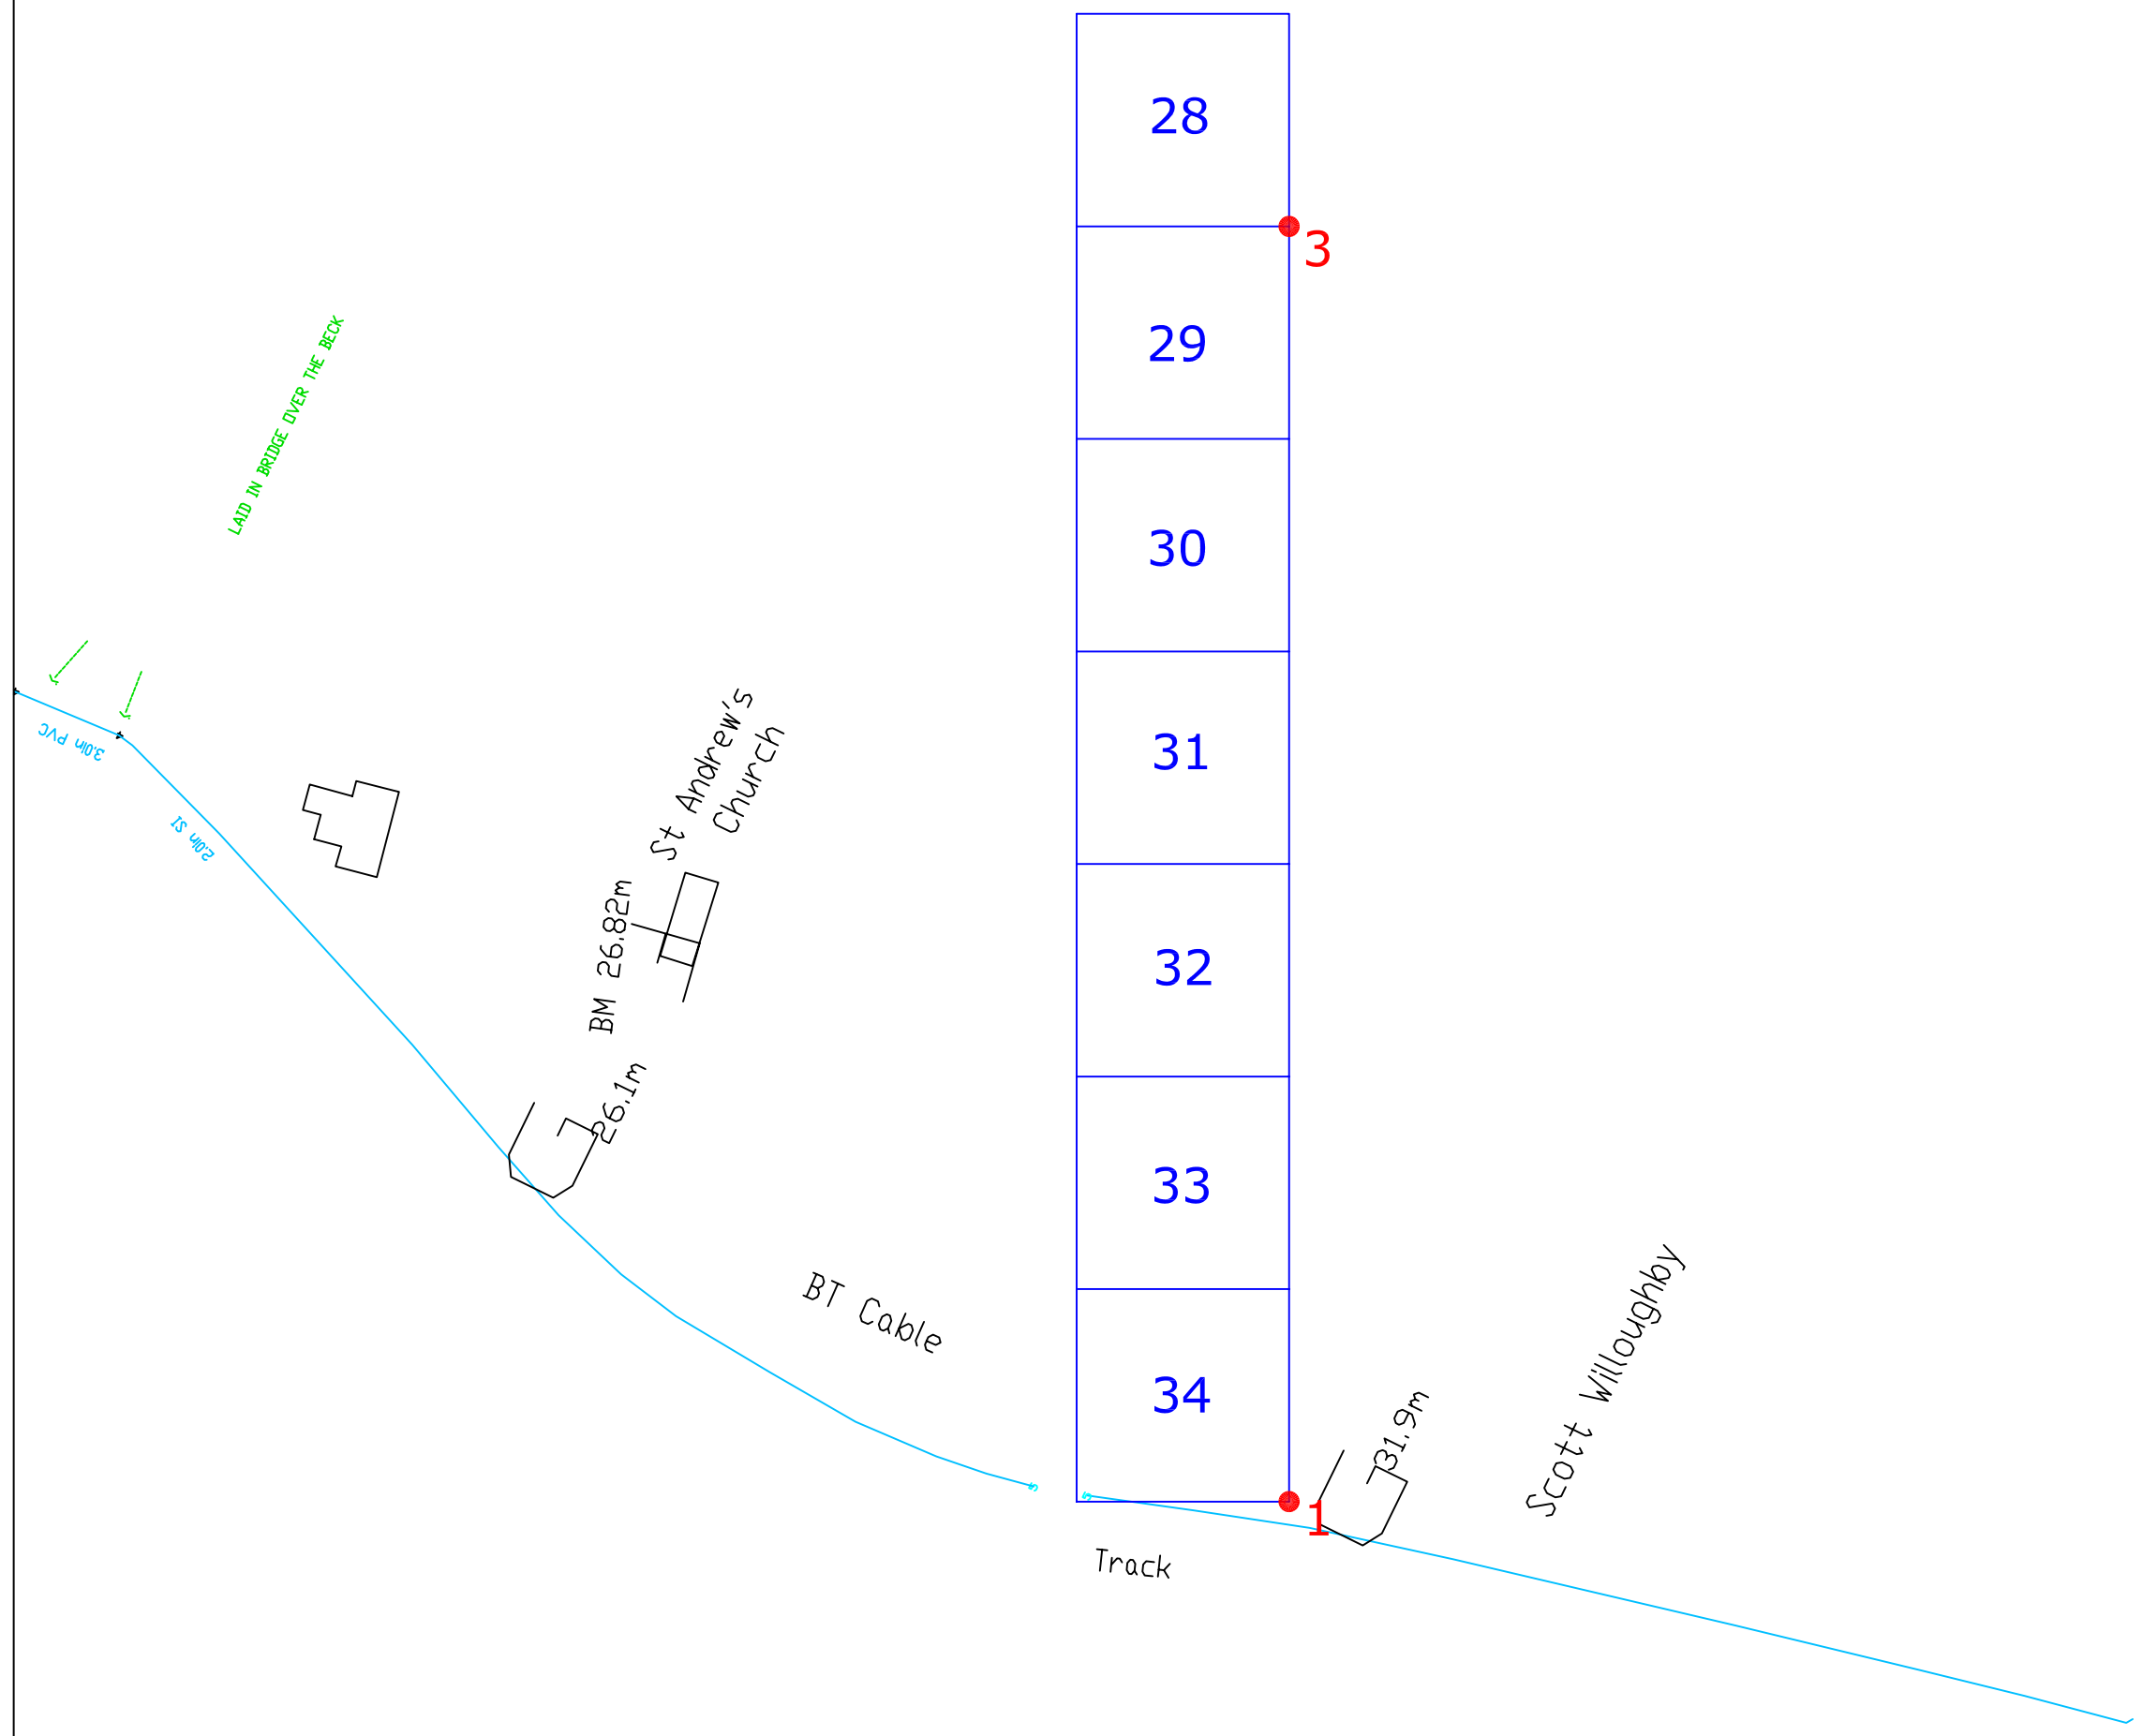

Amendments		
Issue No.	Date	Description
-	-	-
-	-	-

POINT I.D	OS GRID REFERENCE
1	505325.2 , 337520.2
3	505486.7 , 337599.7
28	Survey grid number

Client	APS	
Project Title	GEOPHYSICAL SURVEY - HARROWBY-ASWARBY PIPELINE	
Job No.	1998	
Subject	Referencing - Area 1	


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GEOPHYSICS FOR ARCHAEOLOGY AND ENGINEERING


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Scale	1:1000	
Plot	A3	Checked by PPB
Issue No.	01	
Survey date	APRIL 05	Drawn by RAJS
Figure No.	03	



Amendments		
Issue No.	Date	Description
-	-	-
-	-	-

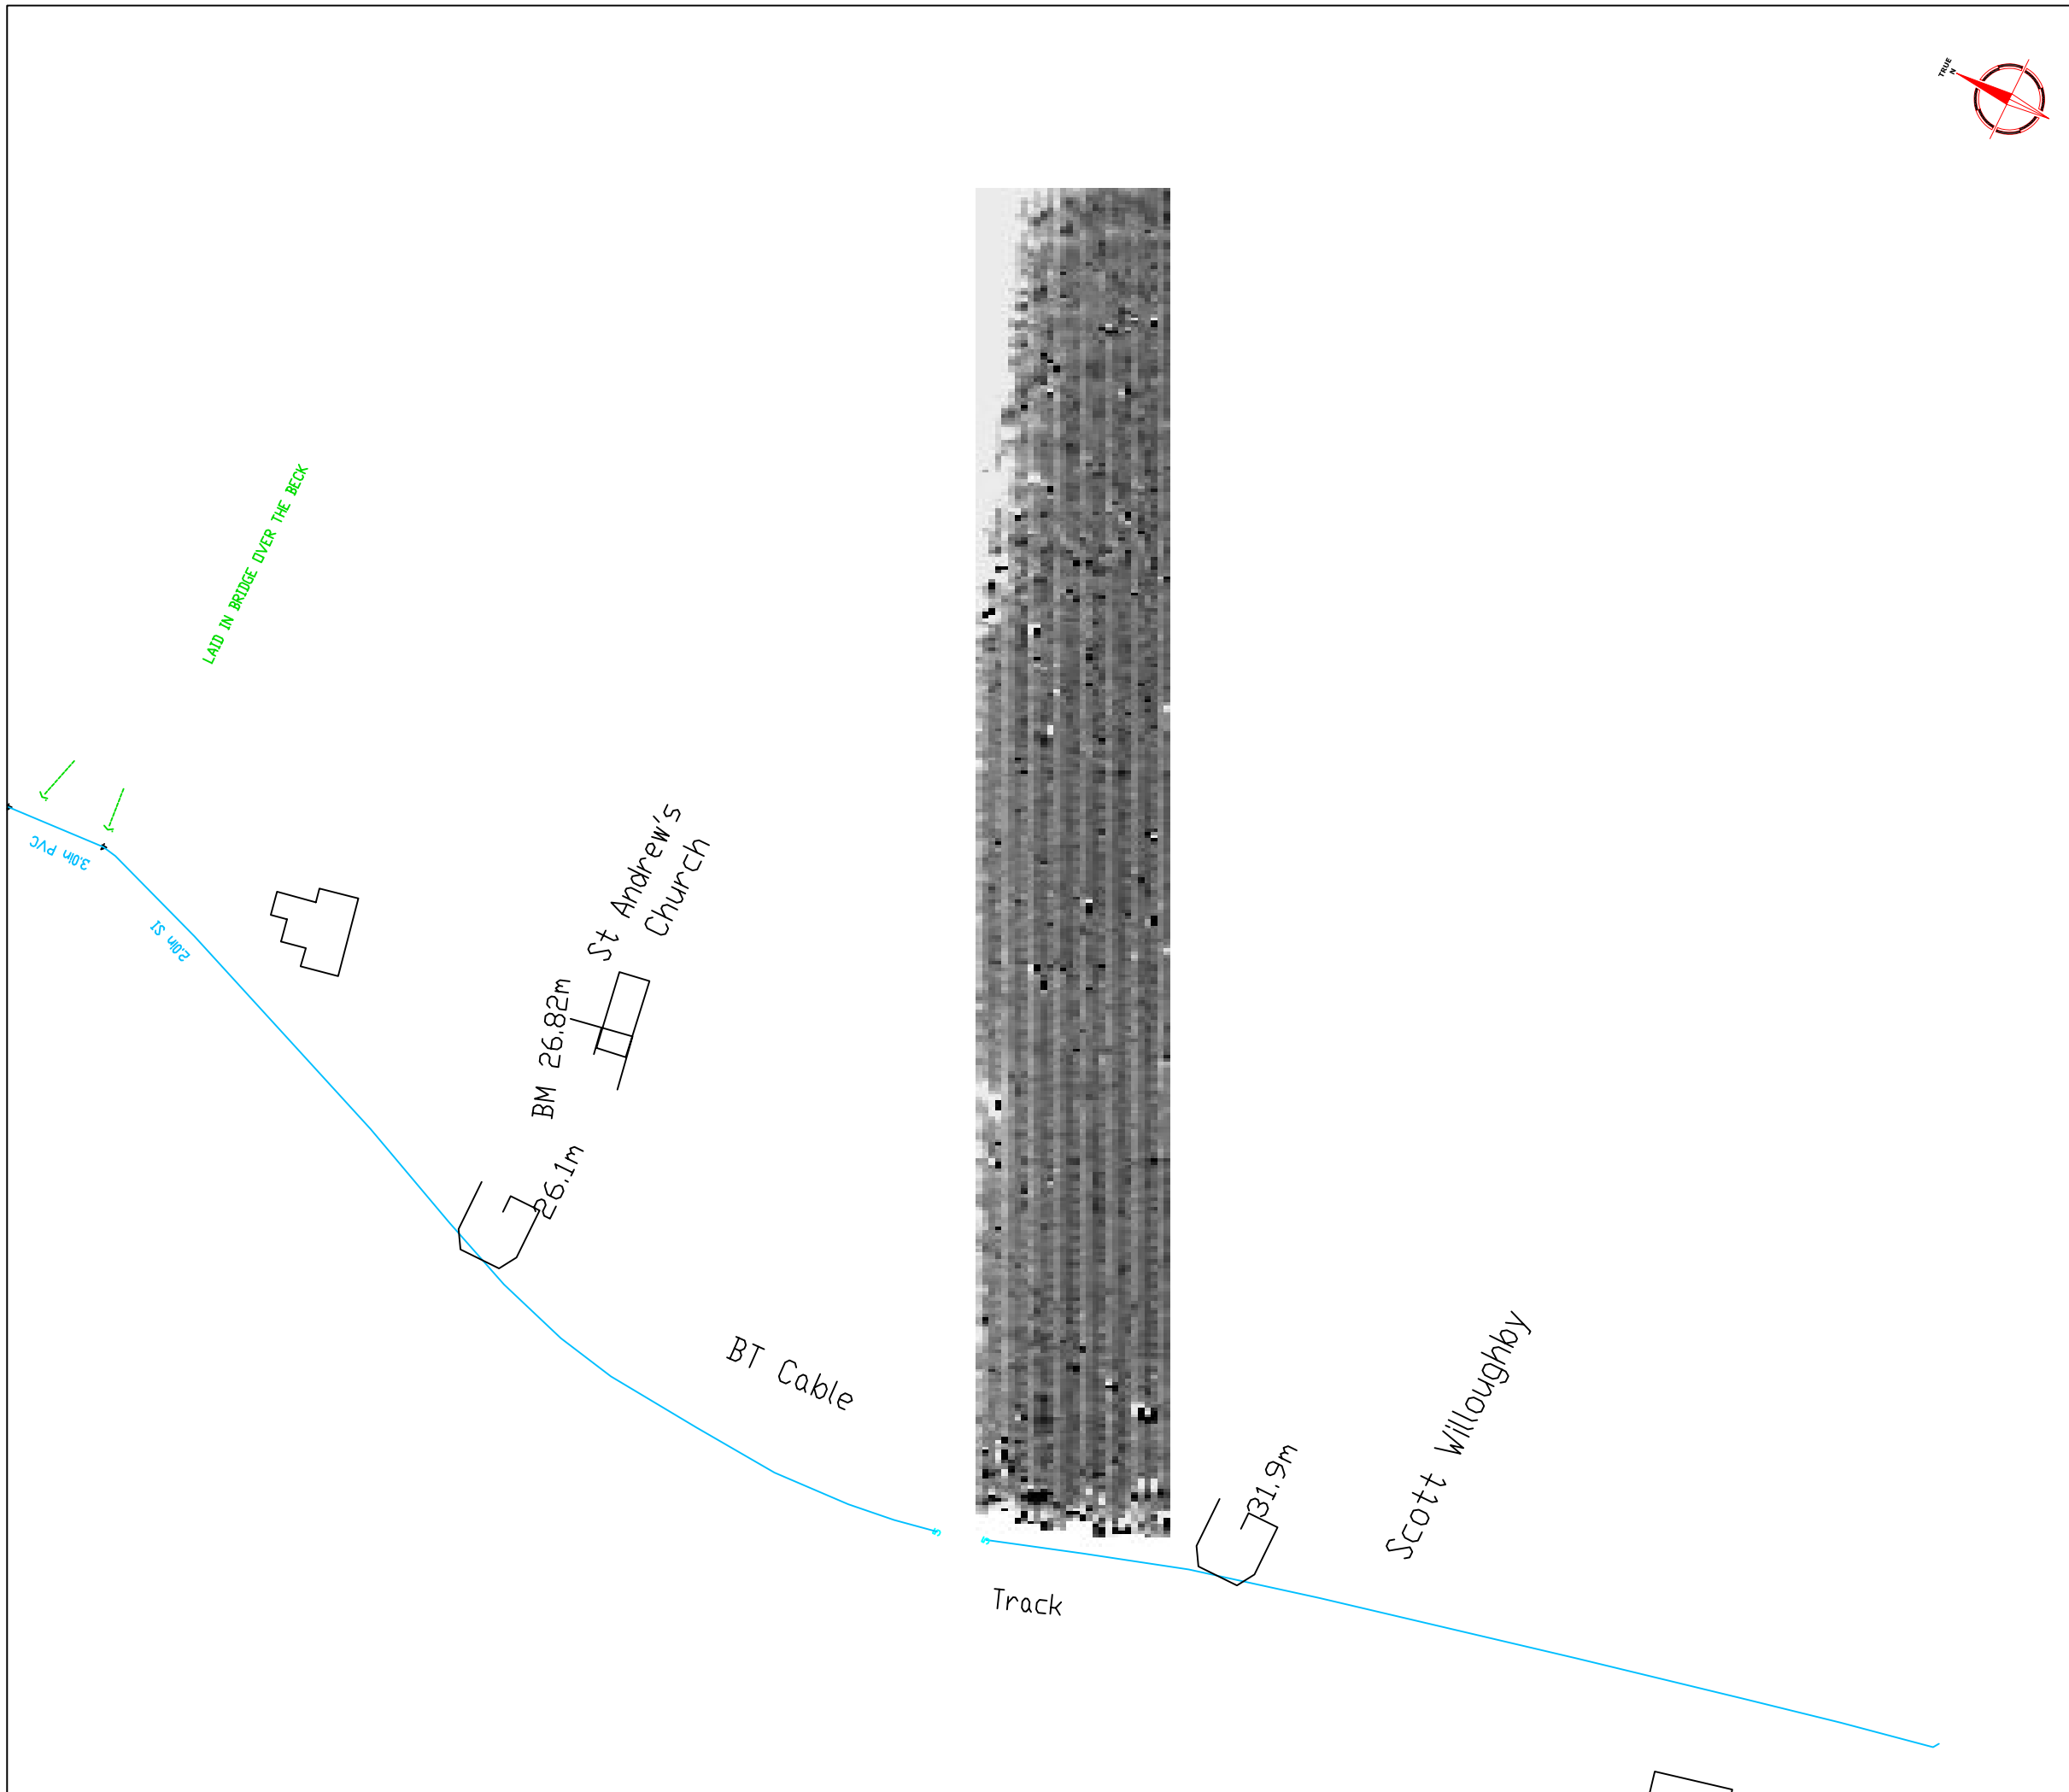

Client
APS

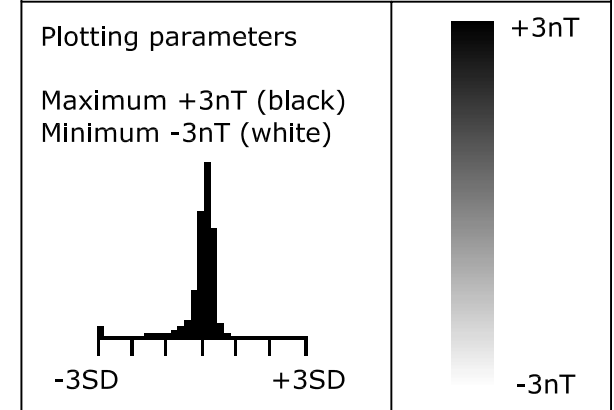
Project Title Job No. 1998
**GEOPHYSICAL SURVEY -
HARROWBY-ASWARBY PIPELINE**

Subject
**PLOT OF RAW
MAGNETOMETER DATA -
AREA 1**

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Scale **1:1000** 0m 10 20 30 40m

Plot A3	Checked by PPB	Issue No. 01
Survey date APRIL 05	Drawn by RAJS	Figure No. 04

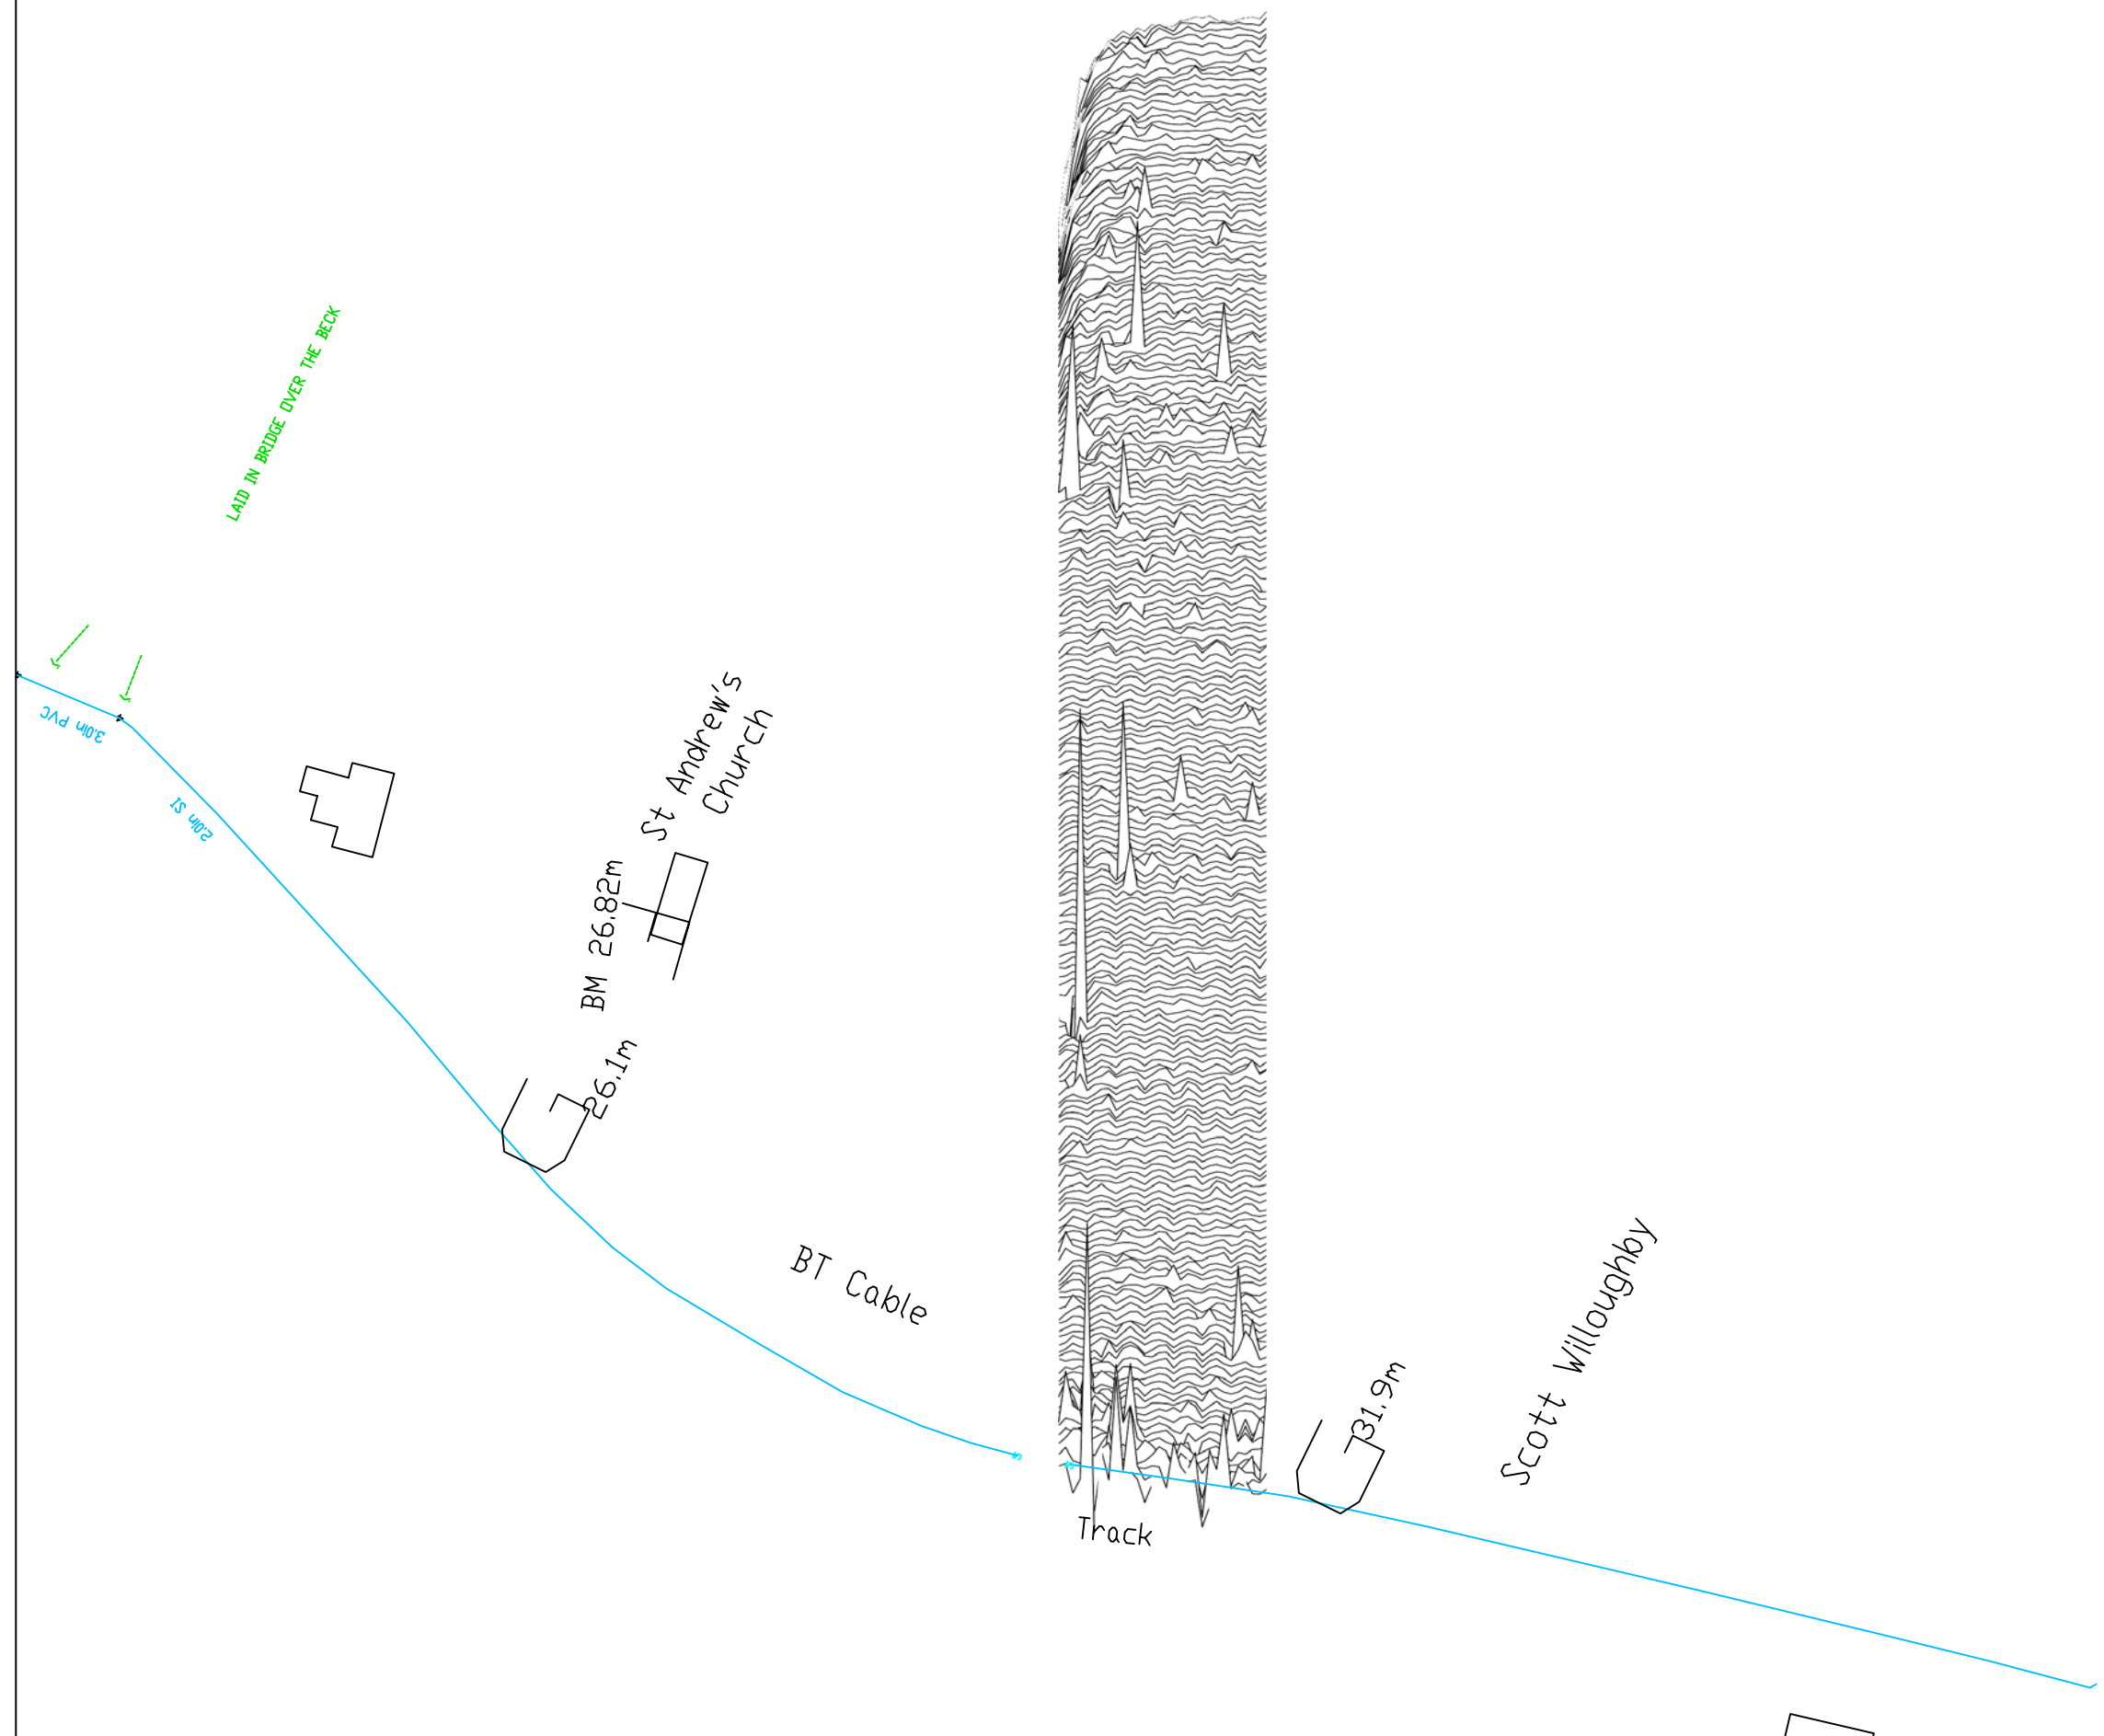

Amendments		
Issue No.	Date	Description
-	-	-
-	-	-

Plotting parameters	65.15nT
Standard deviation at .1	52.12nT
(Positive values displace above the trace line. Hidden values have not been plotted)	39.09nT
	26.06nT
	13.03nT
	0nT

Client	APS
--------	-----



Project Title	Job No.	1998
GEOPHYSICAL SURVEY - HARROWBY-ASWARBY PIPELINE		

Subject	TRACE PLOT OF RAW MAGNETOMETER DATA SHOWING POSITIVE VALUES - AREA 1
---------	--

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Scale	1:1000	0m 10 20 30 40m
-------	--------	-----------------

Plot	Checked by	Issue No.
A3	PPB	01
Survey date	Drawn by	Figure No.
APRIL 05	RAJS	05

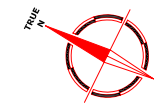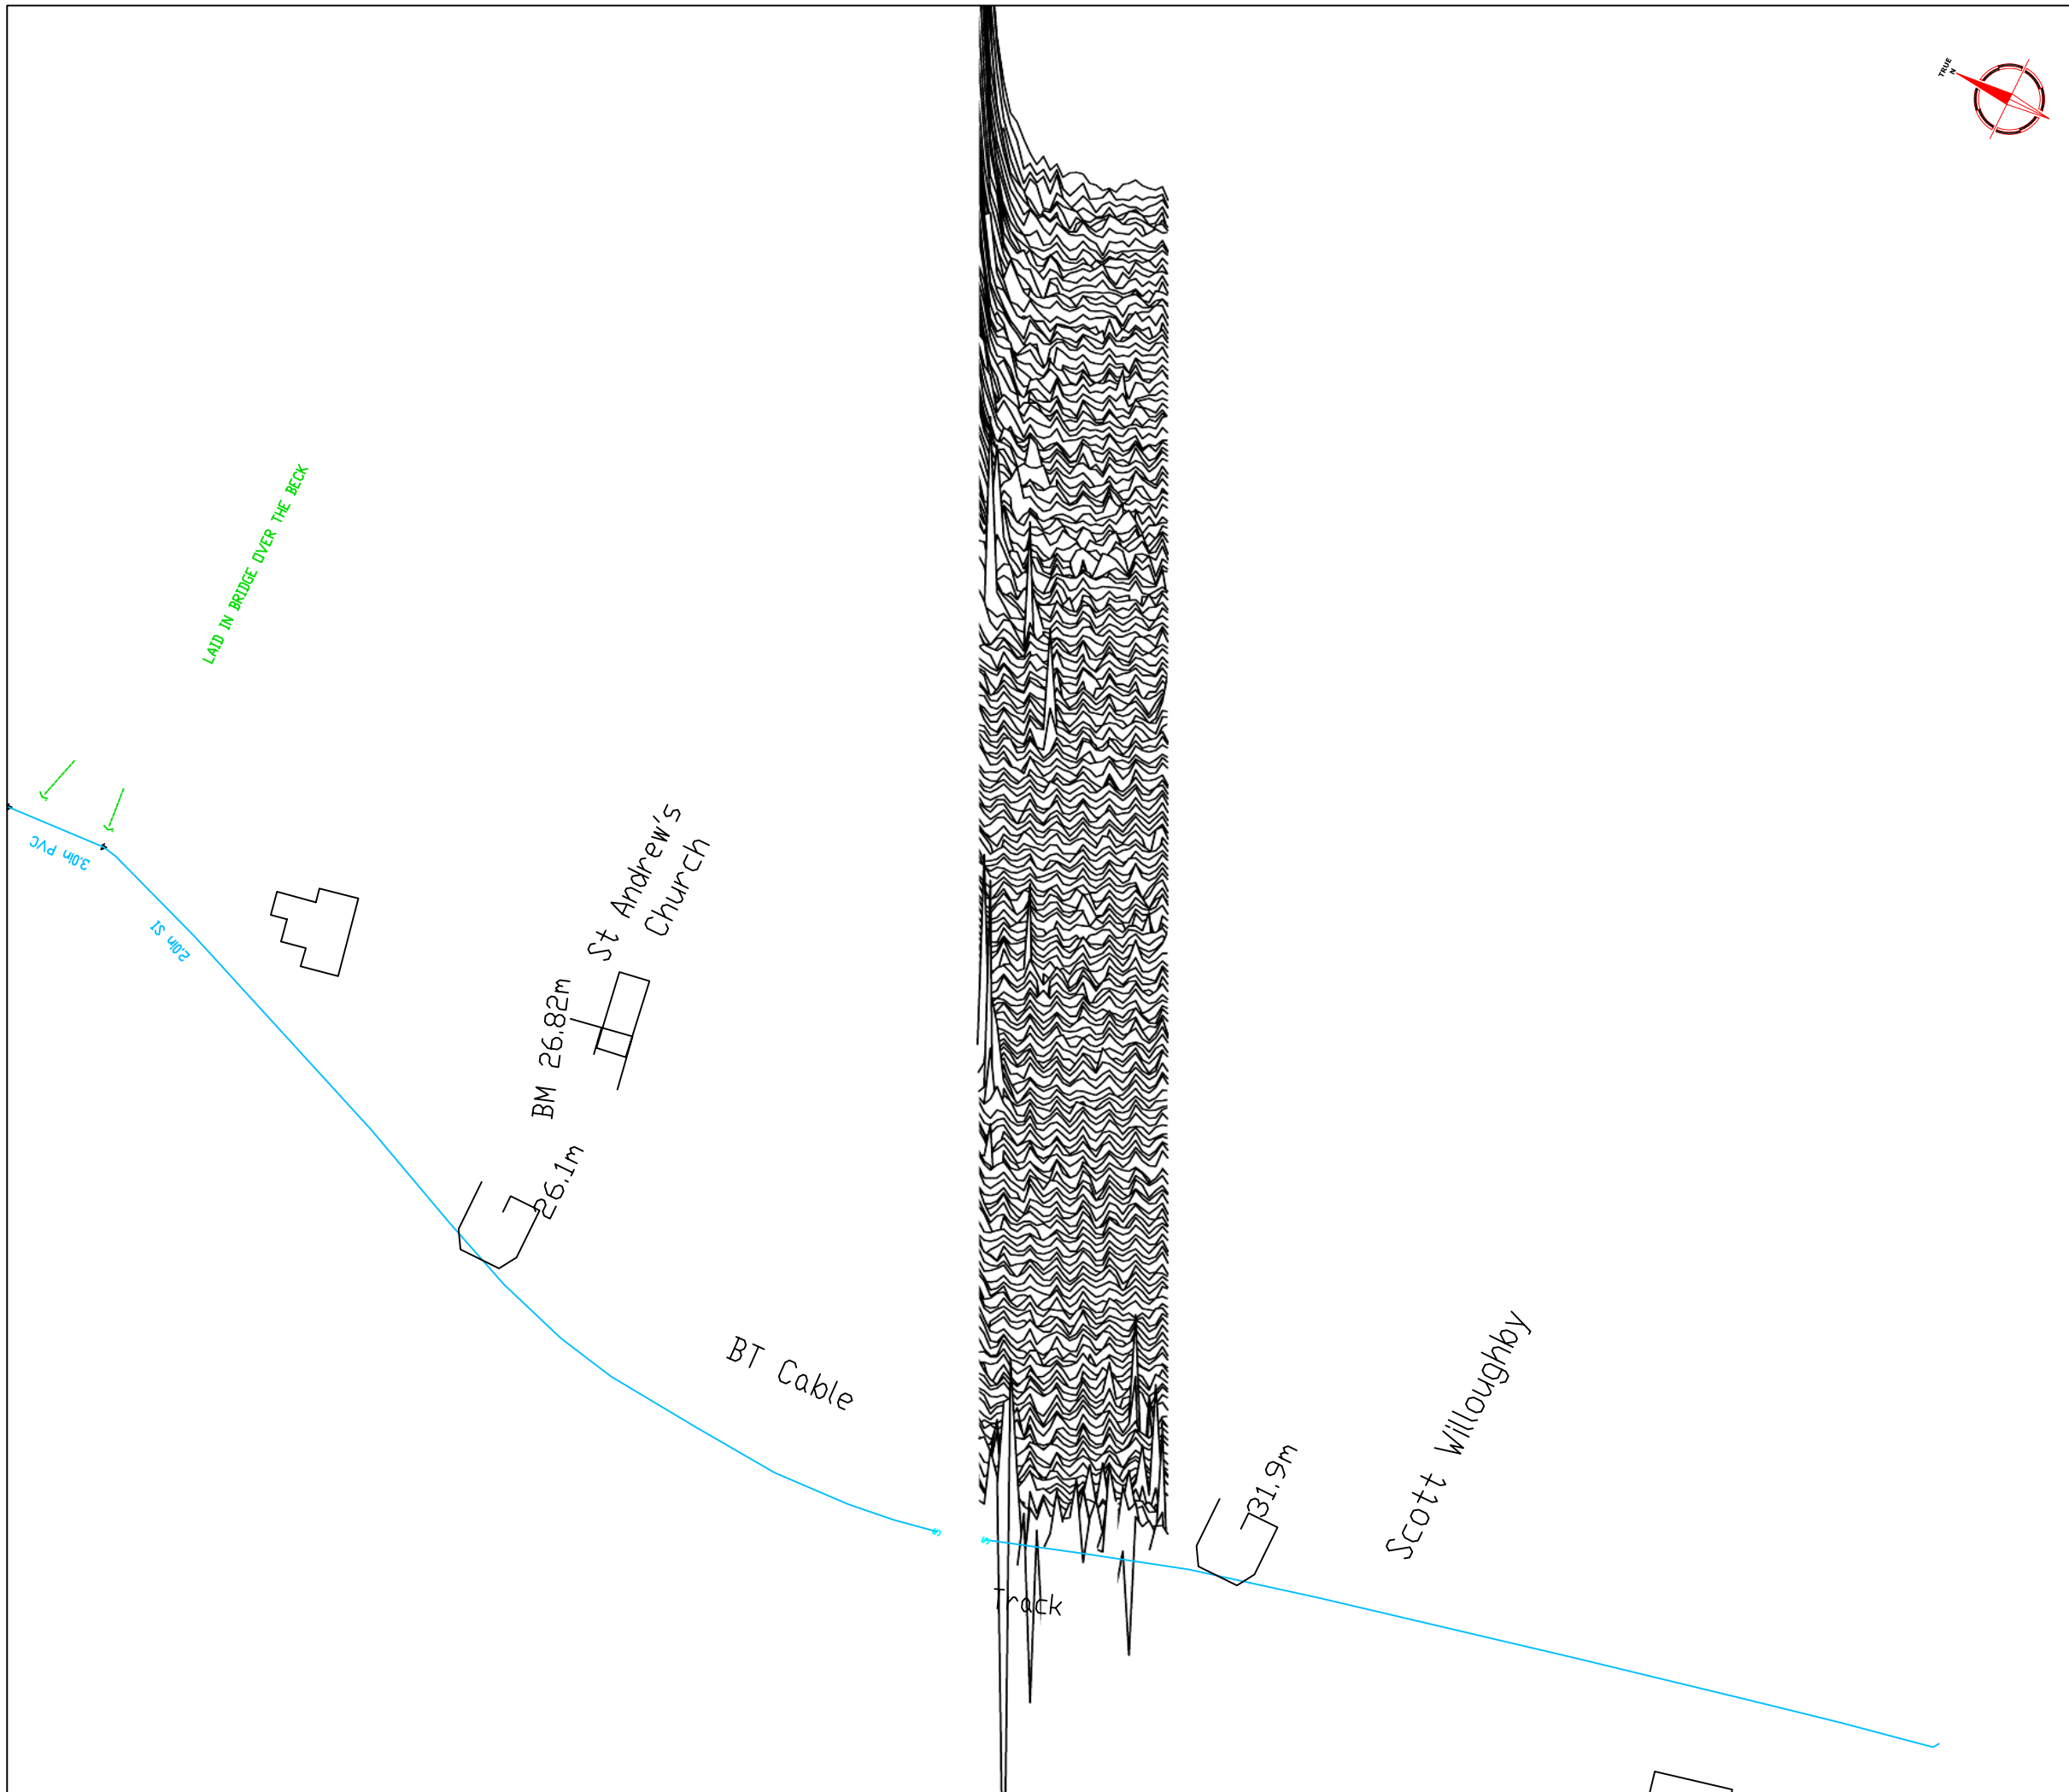

Amendments		
Issue No.	Date	Description
-	-	-
-	-	-
-	-	-

Plotting parameters	-65.15nT
-40nT	-52.12nT
(Negative values displace above the trace line. Hidden values have not been plotted)	-39.09nT
	-26.06nT
	-13.03nT
	0nT

Client	APS
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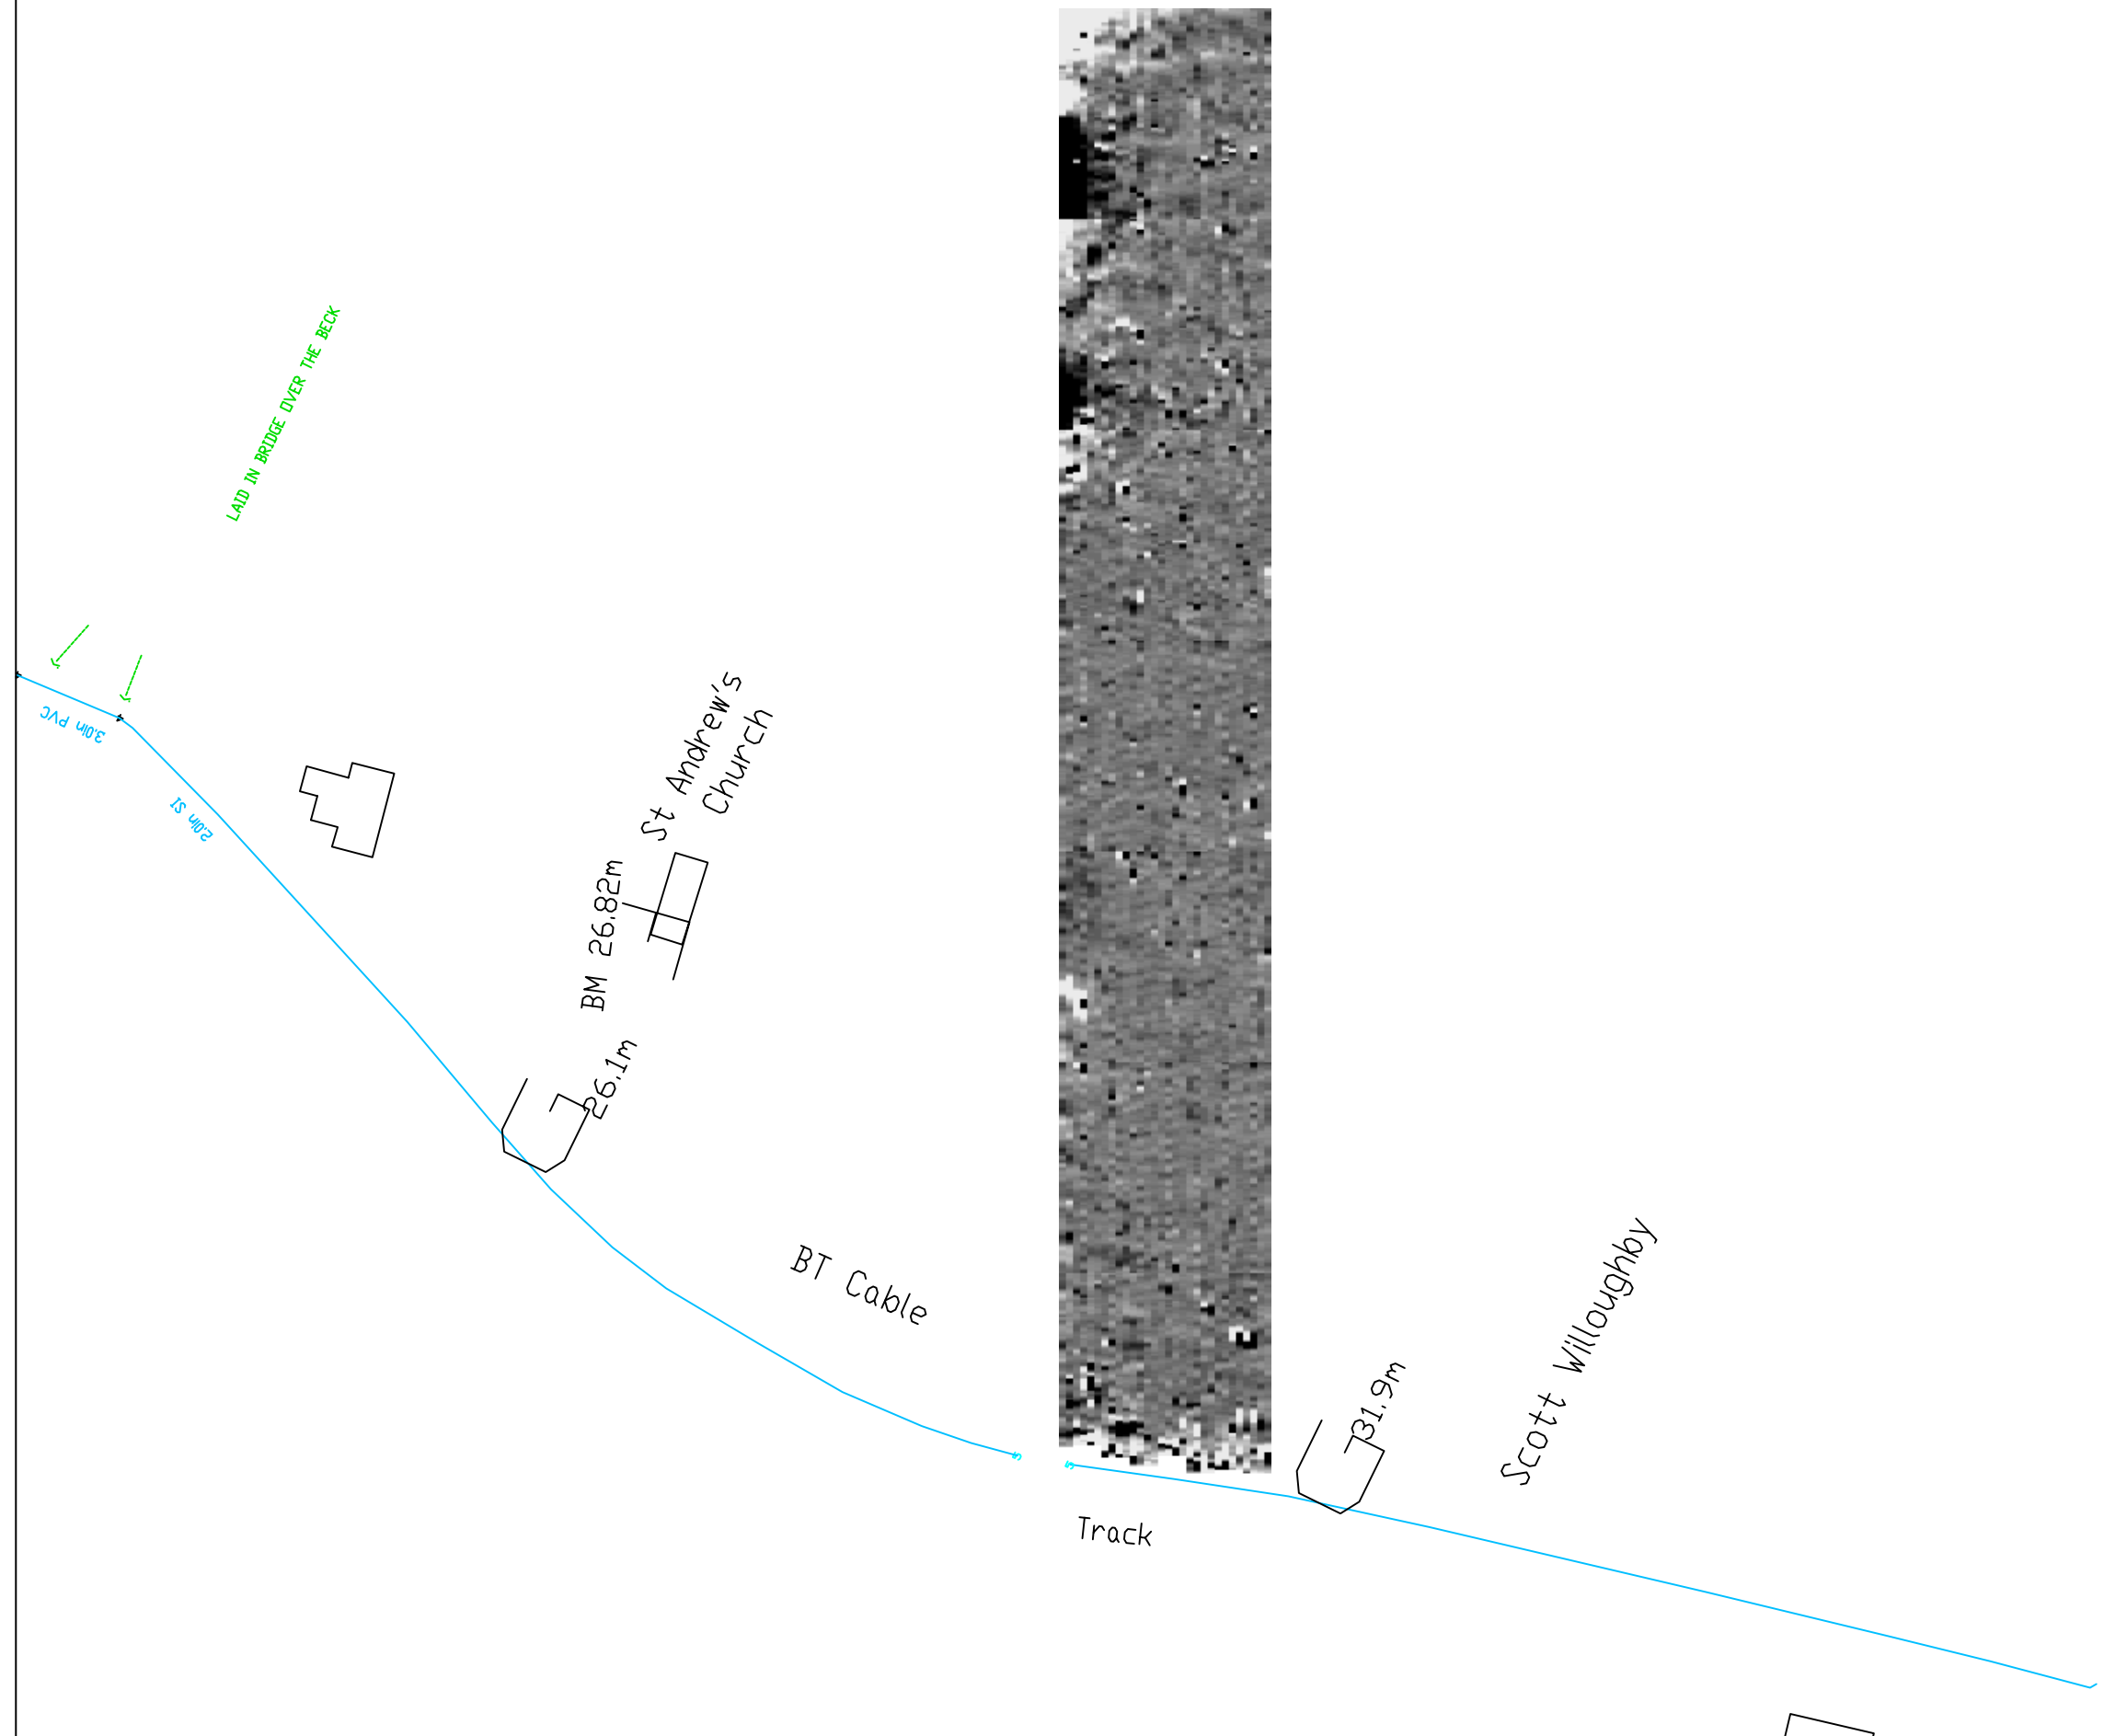
Project Title	Job No.	1998
GEOPHYSICAL SURVEY - HARROWBY-ASWARBY PIPELINE		

Subject	TRACE PLOT OF RAW MAGNETOMETER DATA SHOWING NEGATIVE VALUES - AREA 1
---------	--

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Scale	1:1000	0m 10 20 30 40m
-------	--------	-----------------

Plot	Checked by	Issue No.
A3	PPB	01
Survey date	Drawn by	Figure No.
APRIL 05	RAJS	06



Amendments		
Issue No.	Date	Description
-	-	-
-	-	-

Plotting parameters	
Maximum +2nT (black) Minimum -2nT (white)	

Client	APS
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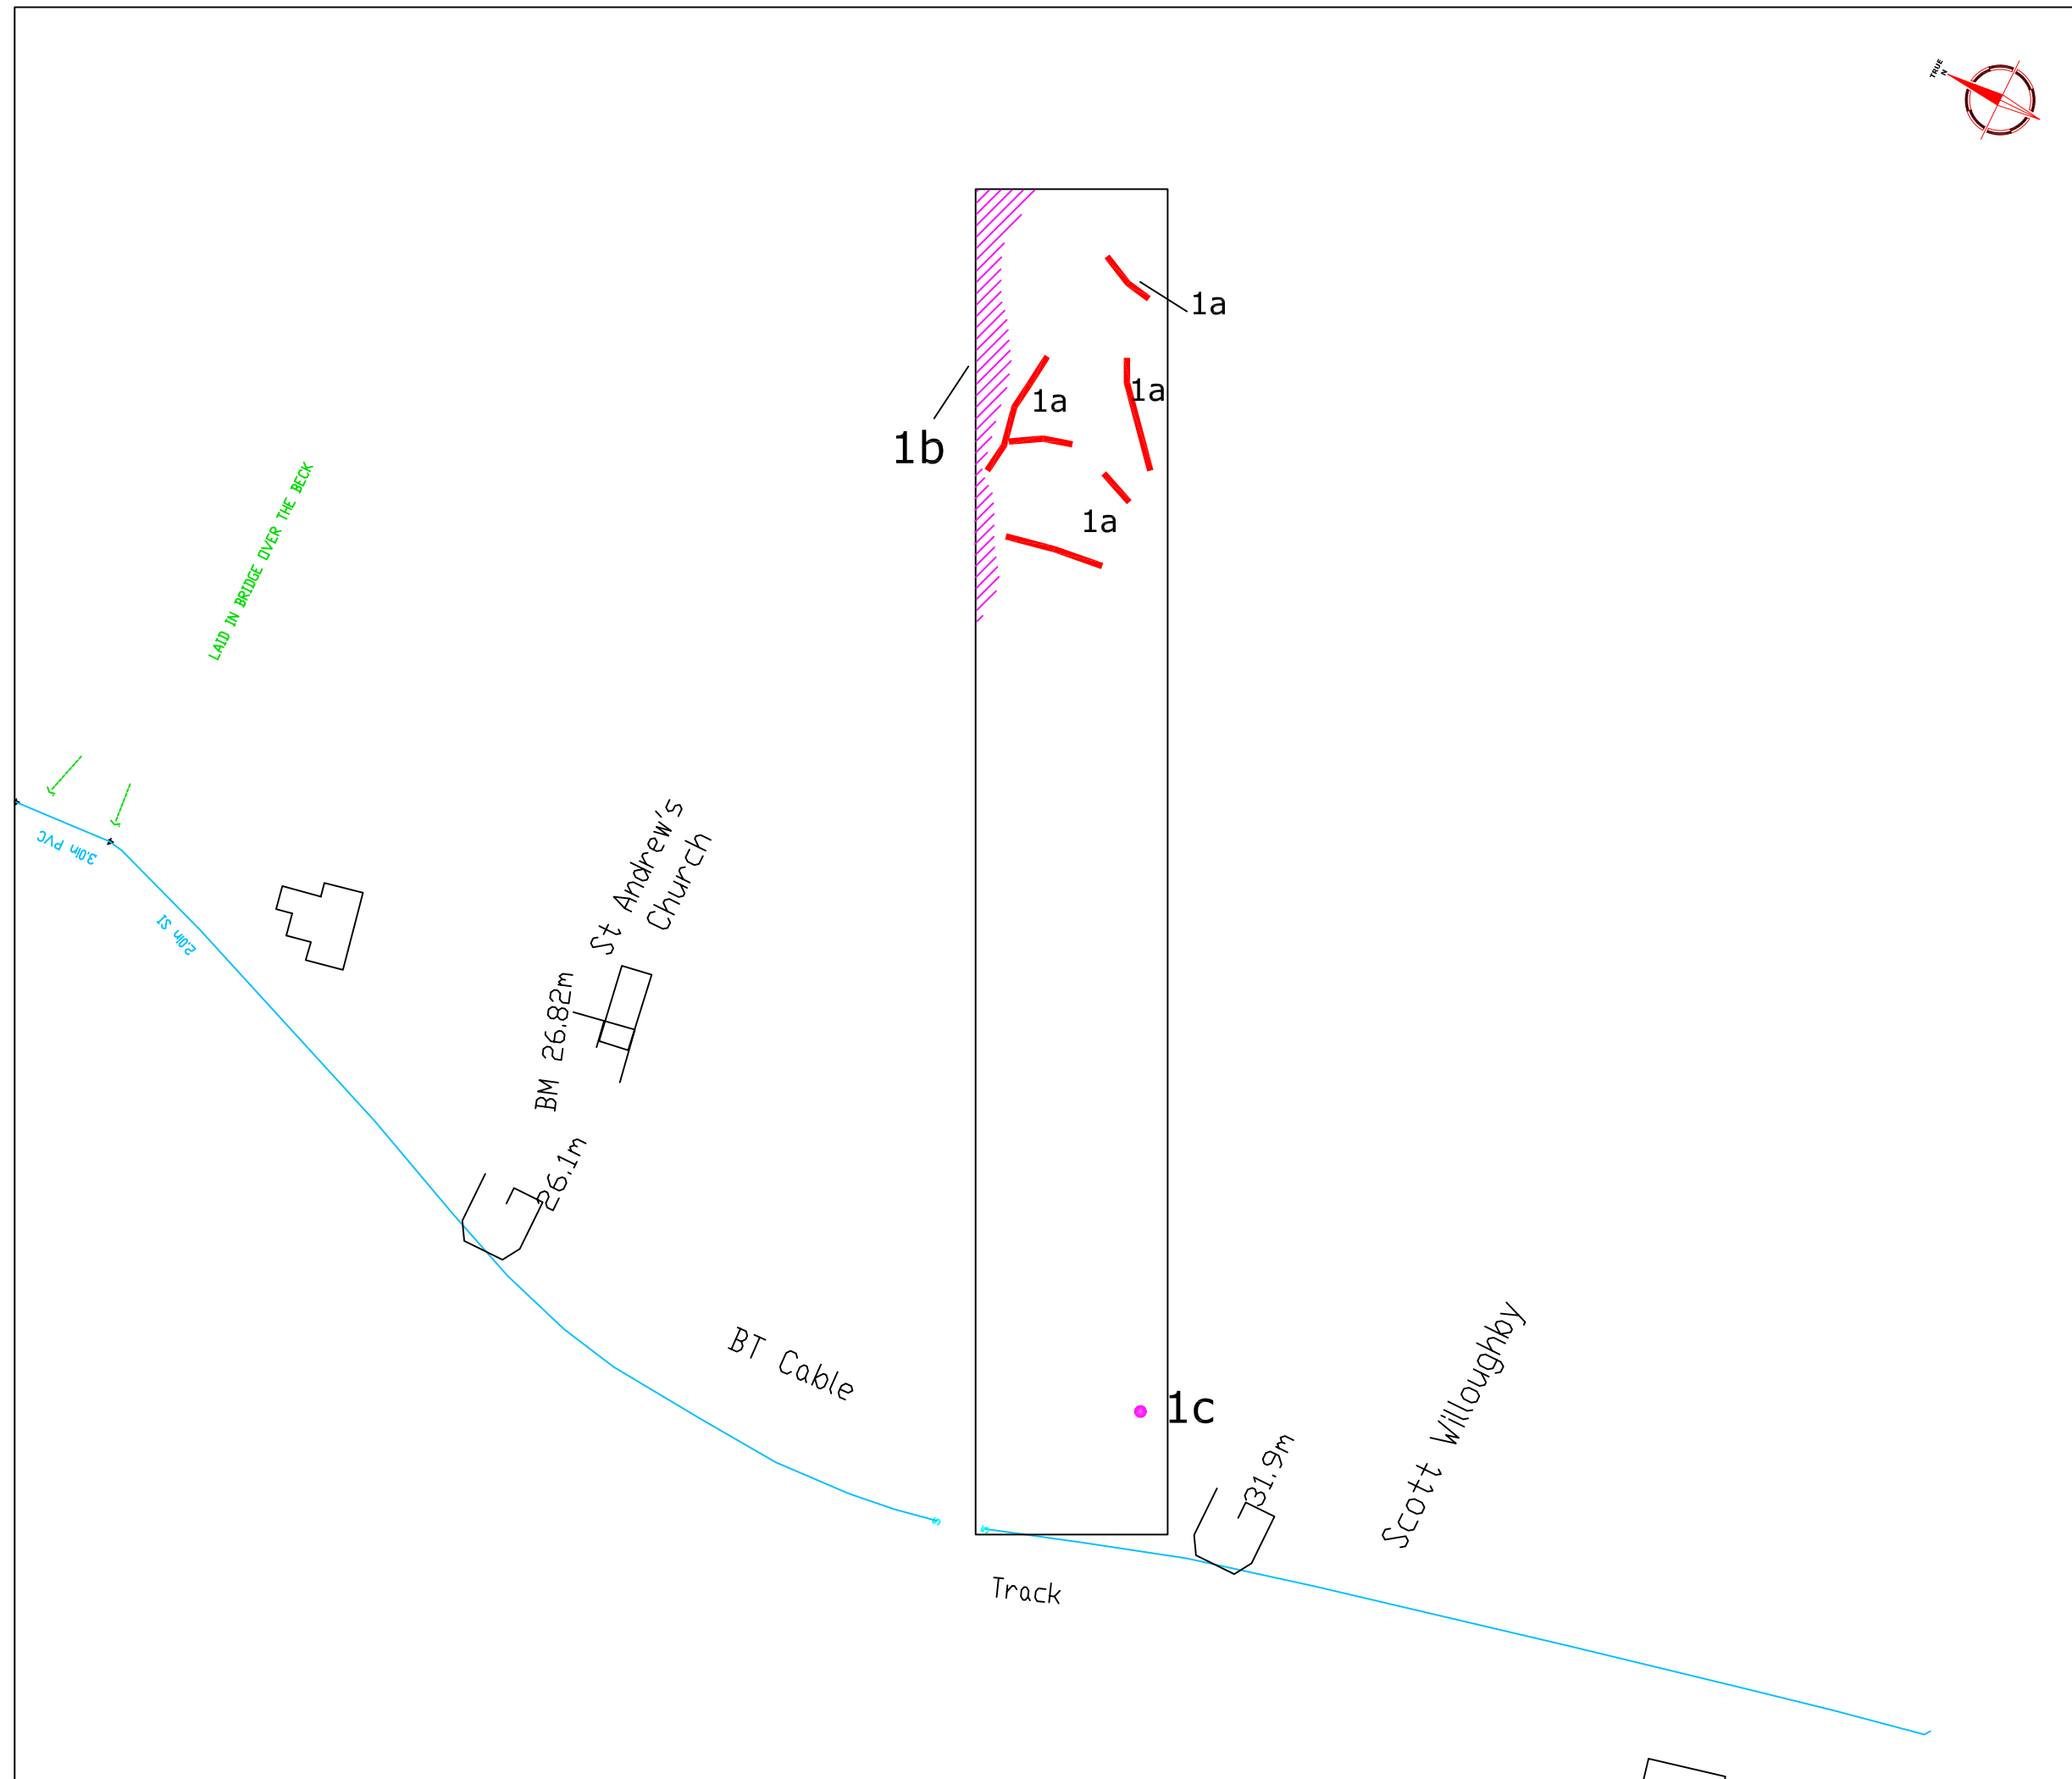
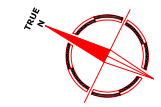
Project Title	Job No.
GEOPHYSICAL SURVEY - HARROWBY-ASWARBY PIPELINE	1998

Subject	PLOT OF PROCESSED MAGNETOMETER DATA - AREA 1
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Scale	1:1000	

Plot	Checked by	Issue No.
A3	PPB	01
Survey date	Drawn by	Figure No.
APRIL 05	RAJS	07



Amendments		
Issue No.	Date	Description
-	-	-
-	-	-


KEY	
1a	Feature I.D number
	Area of magnetic debris/disturbance
	Positive linear anomaly - possible archaeological origin
	Discrete positive anomaly with negative response- possible ferrous object

Client	APS	
Project Title	GEOPHYSICAL SURVEY - HARROWBY-ASWARBY PIPELINE	
Job No.	1998	
Subject	ABSTRACTION AND INTERPRETATION OF MAGNETOMETER ANOMALIES-AREA 1	


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REGISTRATION NO. IFA


Scale	1:1000	
Plot	A3	Checked by PPB
Issue No.	01	
Survey date	APRIL 05	Drawn by RAJS
Figure No.	08	

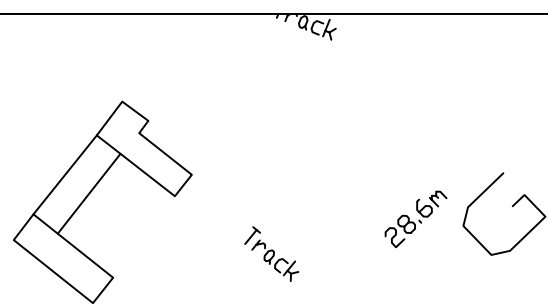





The Beck

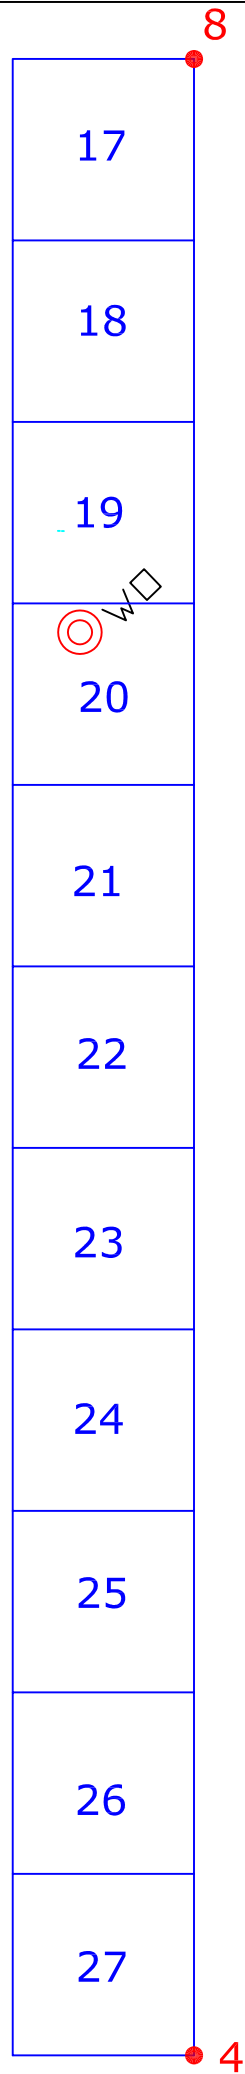

Drain

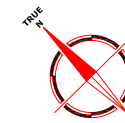


Amendments		
Issue No.	Date	Description
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-	-	-
POINT I.D	OS GRID REFERENCE	
4	505517.8 , 337616	
8	505747 , 337853.3	
17	Survey grid number	
Client		
APS		
Project Title		Job No. 1998
GEOPHYSICAL SURVEY - HARROWBY-ASWARBY PIPELINE		
Subject		
Referencing - Area 2		
<p>STRATASCAN™</p> <p>GEOPHYSICS FOR ARCHAEOLOGY AND ENGINEERING</p> <p>VINEYARD HOUSE UPPER HOOK ROAD UPTON UPON SEVERN UK WR8 0SA</p> <p>T: +44 (0)1684 592266 F: +44 (0)1684 594142 E: info@stratascan.co.uk www.stratascan.co.uk</p>		
Scale	0m 10 20 30 40 50m	
1:1250		
Plot	Checked by	Issue No.
A3	PPB	01
Survey date	Drawn by	Figure No.
APRIL 05	RAJS	09

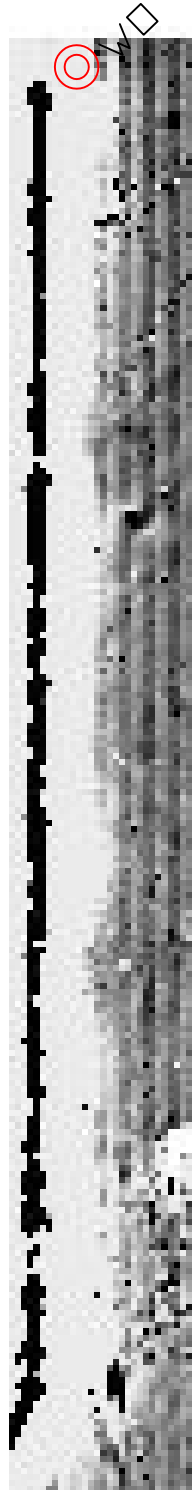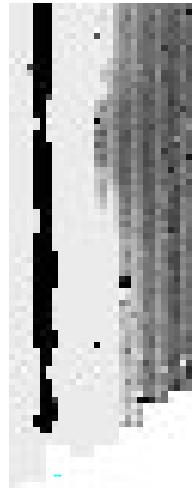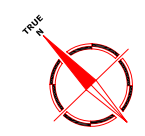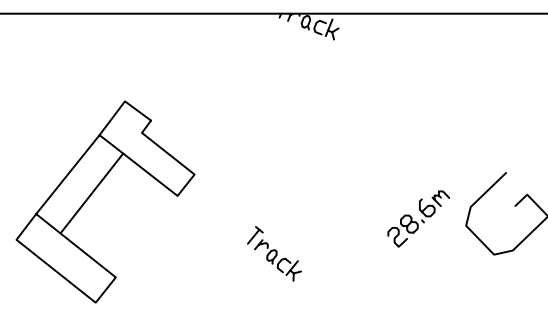

The Beck

Drain

Amendments		
Issue No.	Date	Description
-	-	-
-	-	-

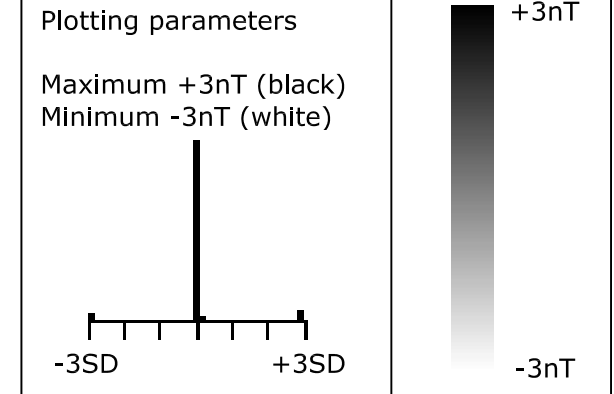


Client
APS


Project Title **GEOPHYSICAL SURVEY - HARROWBY-ASWARBY PIPELINE** Job No. 1998

Subject
PLOT OF RAW MAGNETOMETER DATA - AREA 2


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Plot A3	Checked by PPB	Issue No. 01
Survey date APRIL 05	Drawn by RAJS	Figure No. 10

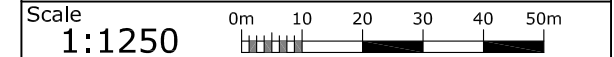


The Beck

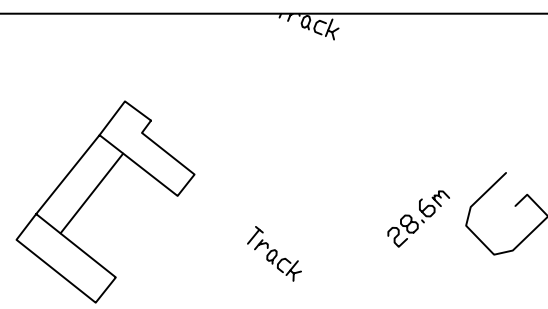


Drain

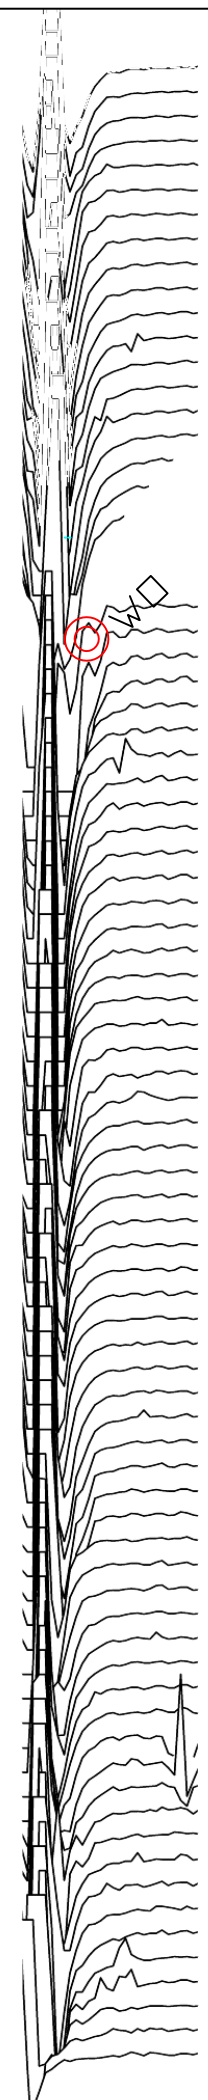Amendments		
Issue No.	Date	Description
-	-	-
-	-	-

<p>Plotting parameters</p> <p>Absolute Resolution at 2 nT</p> <p>Data clipped at +/- 80nT</p> <p><i>(Positive values displace above the trace line. Hidden values have not been plotted)</i></p>		
<p>Client</p> <p style="text-align: center;">APS</p>		
<p>Project Title Job No. 1998</p> <p style="text-align: center;">GEOPHYSICAL SURVEY - HARROWBY-ASWARBY PIPELINE</p>		
<p>Subject</p> <p style="text-align: center;">TRACE PLOT OF RAW MAGNETOMETER DATA SHOWING POSITIVE VALUES - AREA 2</p>		
<p>STRATASCAN™</p> <p>GEOPHYSICS FOR ARCHAEOLOGY AND ENGINEERING</p> <p>VINEYARD HOUSE UPPER HOOK ROAD UPTON UPON SEVERN UK WR8 0SA</p> <p>T: +44 (0)1684 592266 F: +44 (0)1684 594142 E: info@stratascan.co.uk www.stratascan.co.uk</p>		
<p>Scale 0m 10 20 30 40 50m</p> <p style="text-align: center;">1:1250</p>		
Plot	Checked by	Issue No.
A3	PPB	01
Survey date	Drawn by	Figure No.
APRIL 05	RAJS	11

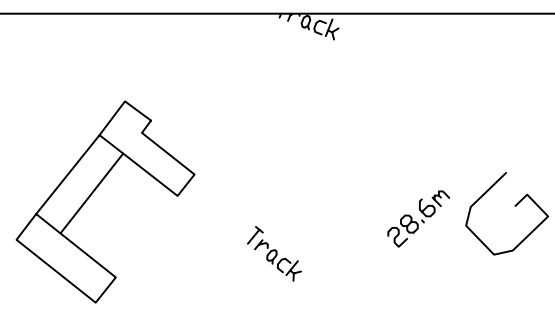

The Beck

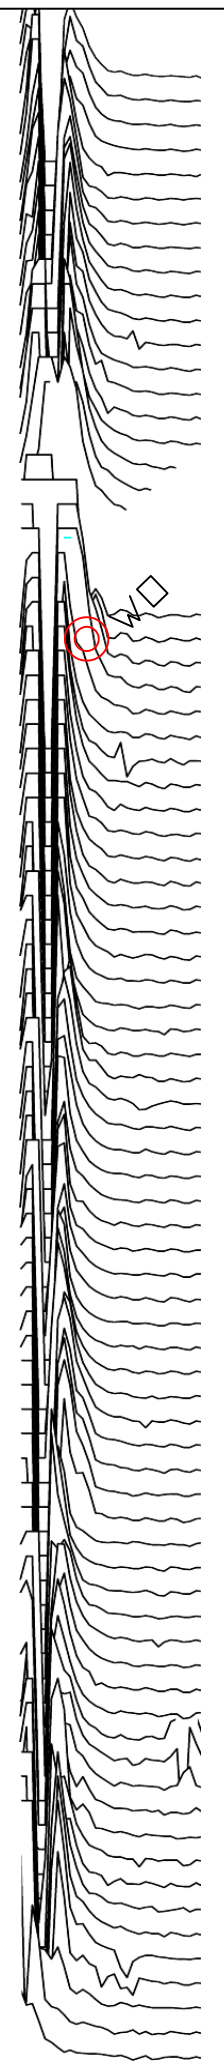

Drain

Amendments		
Issue No.	Date	Description
-	-	-
-	-	-

Plotting parameters	-400nT
Absolute Resolution 2 nT	-320nT
Data clipped at +/-80nT	-240nT
(Negative values displace above the trace line. Hidden values have not been plotted)	-160nT
	-80nT
	0nT

Client	APS
--------	-----




Project Title	Job No.	1998
GEOPHYSICAL SURVEY - HARROWBY-ASWARBY PIPELINE		

Subject	TRACE PLOT OF RAW MAGNETOMETER DATA SHOWING NEGATIVE VALUES - AREA 2
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Scale	0m 10 20 30 40 50m
1:1250	

Plot	Checked by	Issue No.
A3	PPB	01
Survey date	Drawn by	Figure No.
APRIL 05	RAJS	12



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Drain

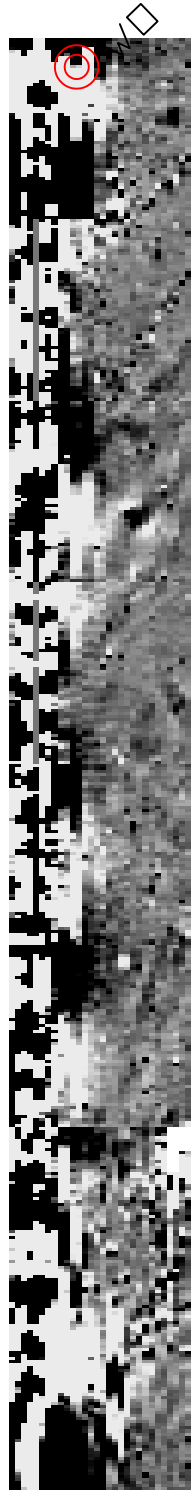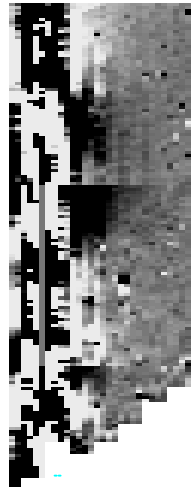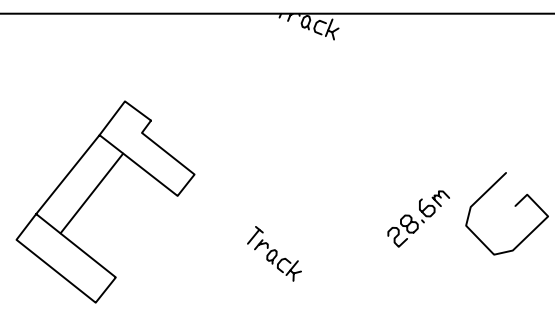Amendments		
Issue No.	Date	Description
-	-	-
-	-	-

Plotting parameters	
Maximum +2nT (black) Minimum -2nT (white)	

Client	APS
--------	-----



Project Title	Job No.
GEOPHYSICAL SURVEY - HARROWBY-ASWARBY PIPELINE	1998

Subject
PLOT OF PROCESSED MAGNETOMETER DATA - AREA 2


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Scale	0m 10 20 30 40 50m	
1:1250		

Plot	Checked by	Issue No.
A3	PPB	01
Survey date	Drawn by	Figure No.
APRIL 05	RAJS	13

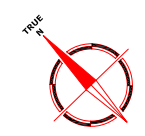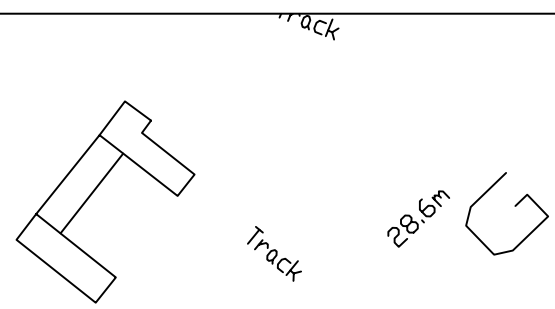

The Beck

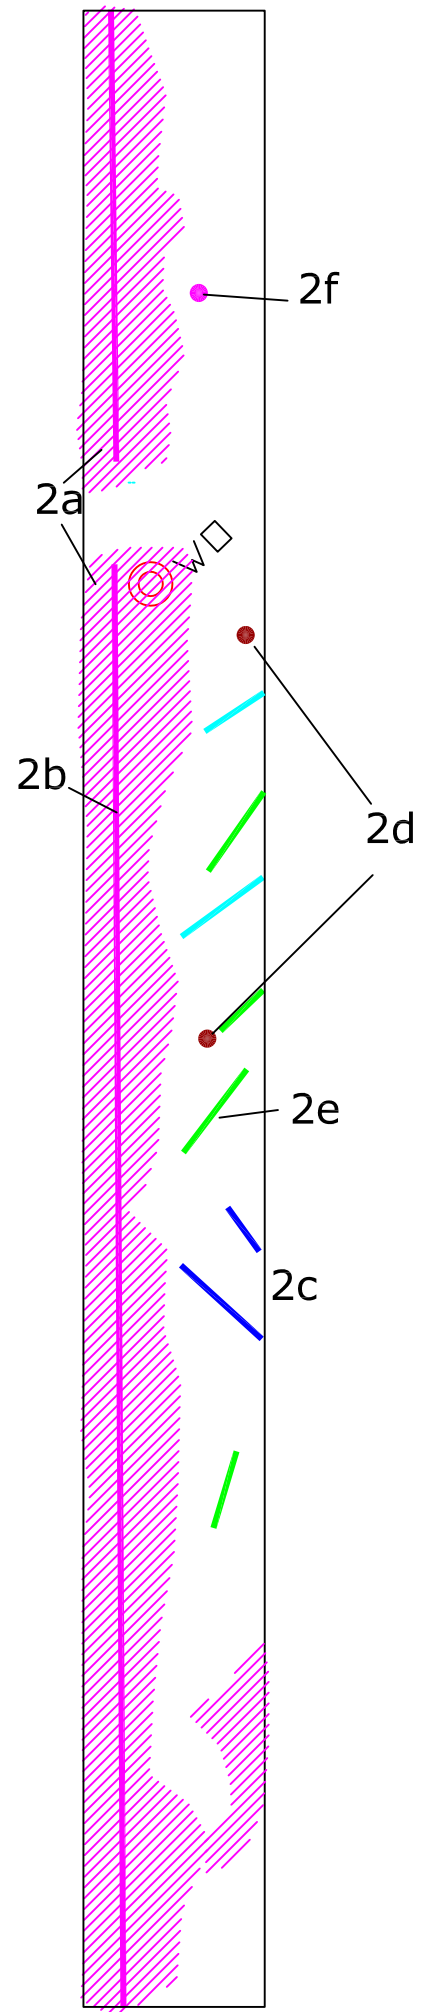

Drain


Amendments		
Issue No.	Date	Description
-	-	-
-	-	-

KEY	
2a	Feature I.D number
	Pipeline
	Area of magnetic debris/disturbance
	Positive linear anomaly - agricultural mark
	Negative linear anomaly - embankment/earthwork remains
	Land Drain
	Discrete positive anomaly with negative response - ferrous object
	Discrete positive anomaly - possible pit



Client	APS	
Project Title	Job No. 1998	
	GEOPHYSICAL SURVEY - HARROWBY-ASWARBY PIPELINE	
Subject	ABSTRACTION AND INTERPRETATION OF MAGNETOMETER ANOMALIES - AREA 2	

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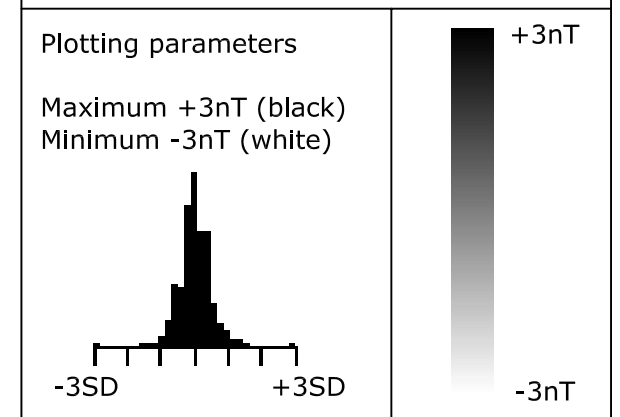
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Plot	Checked by	Issue No.
A3	PPB	01
Survey date	Drawn by	Figure No.
APRIL 05	RAJS	14

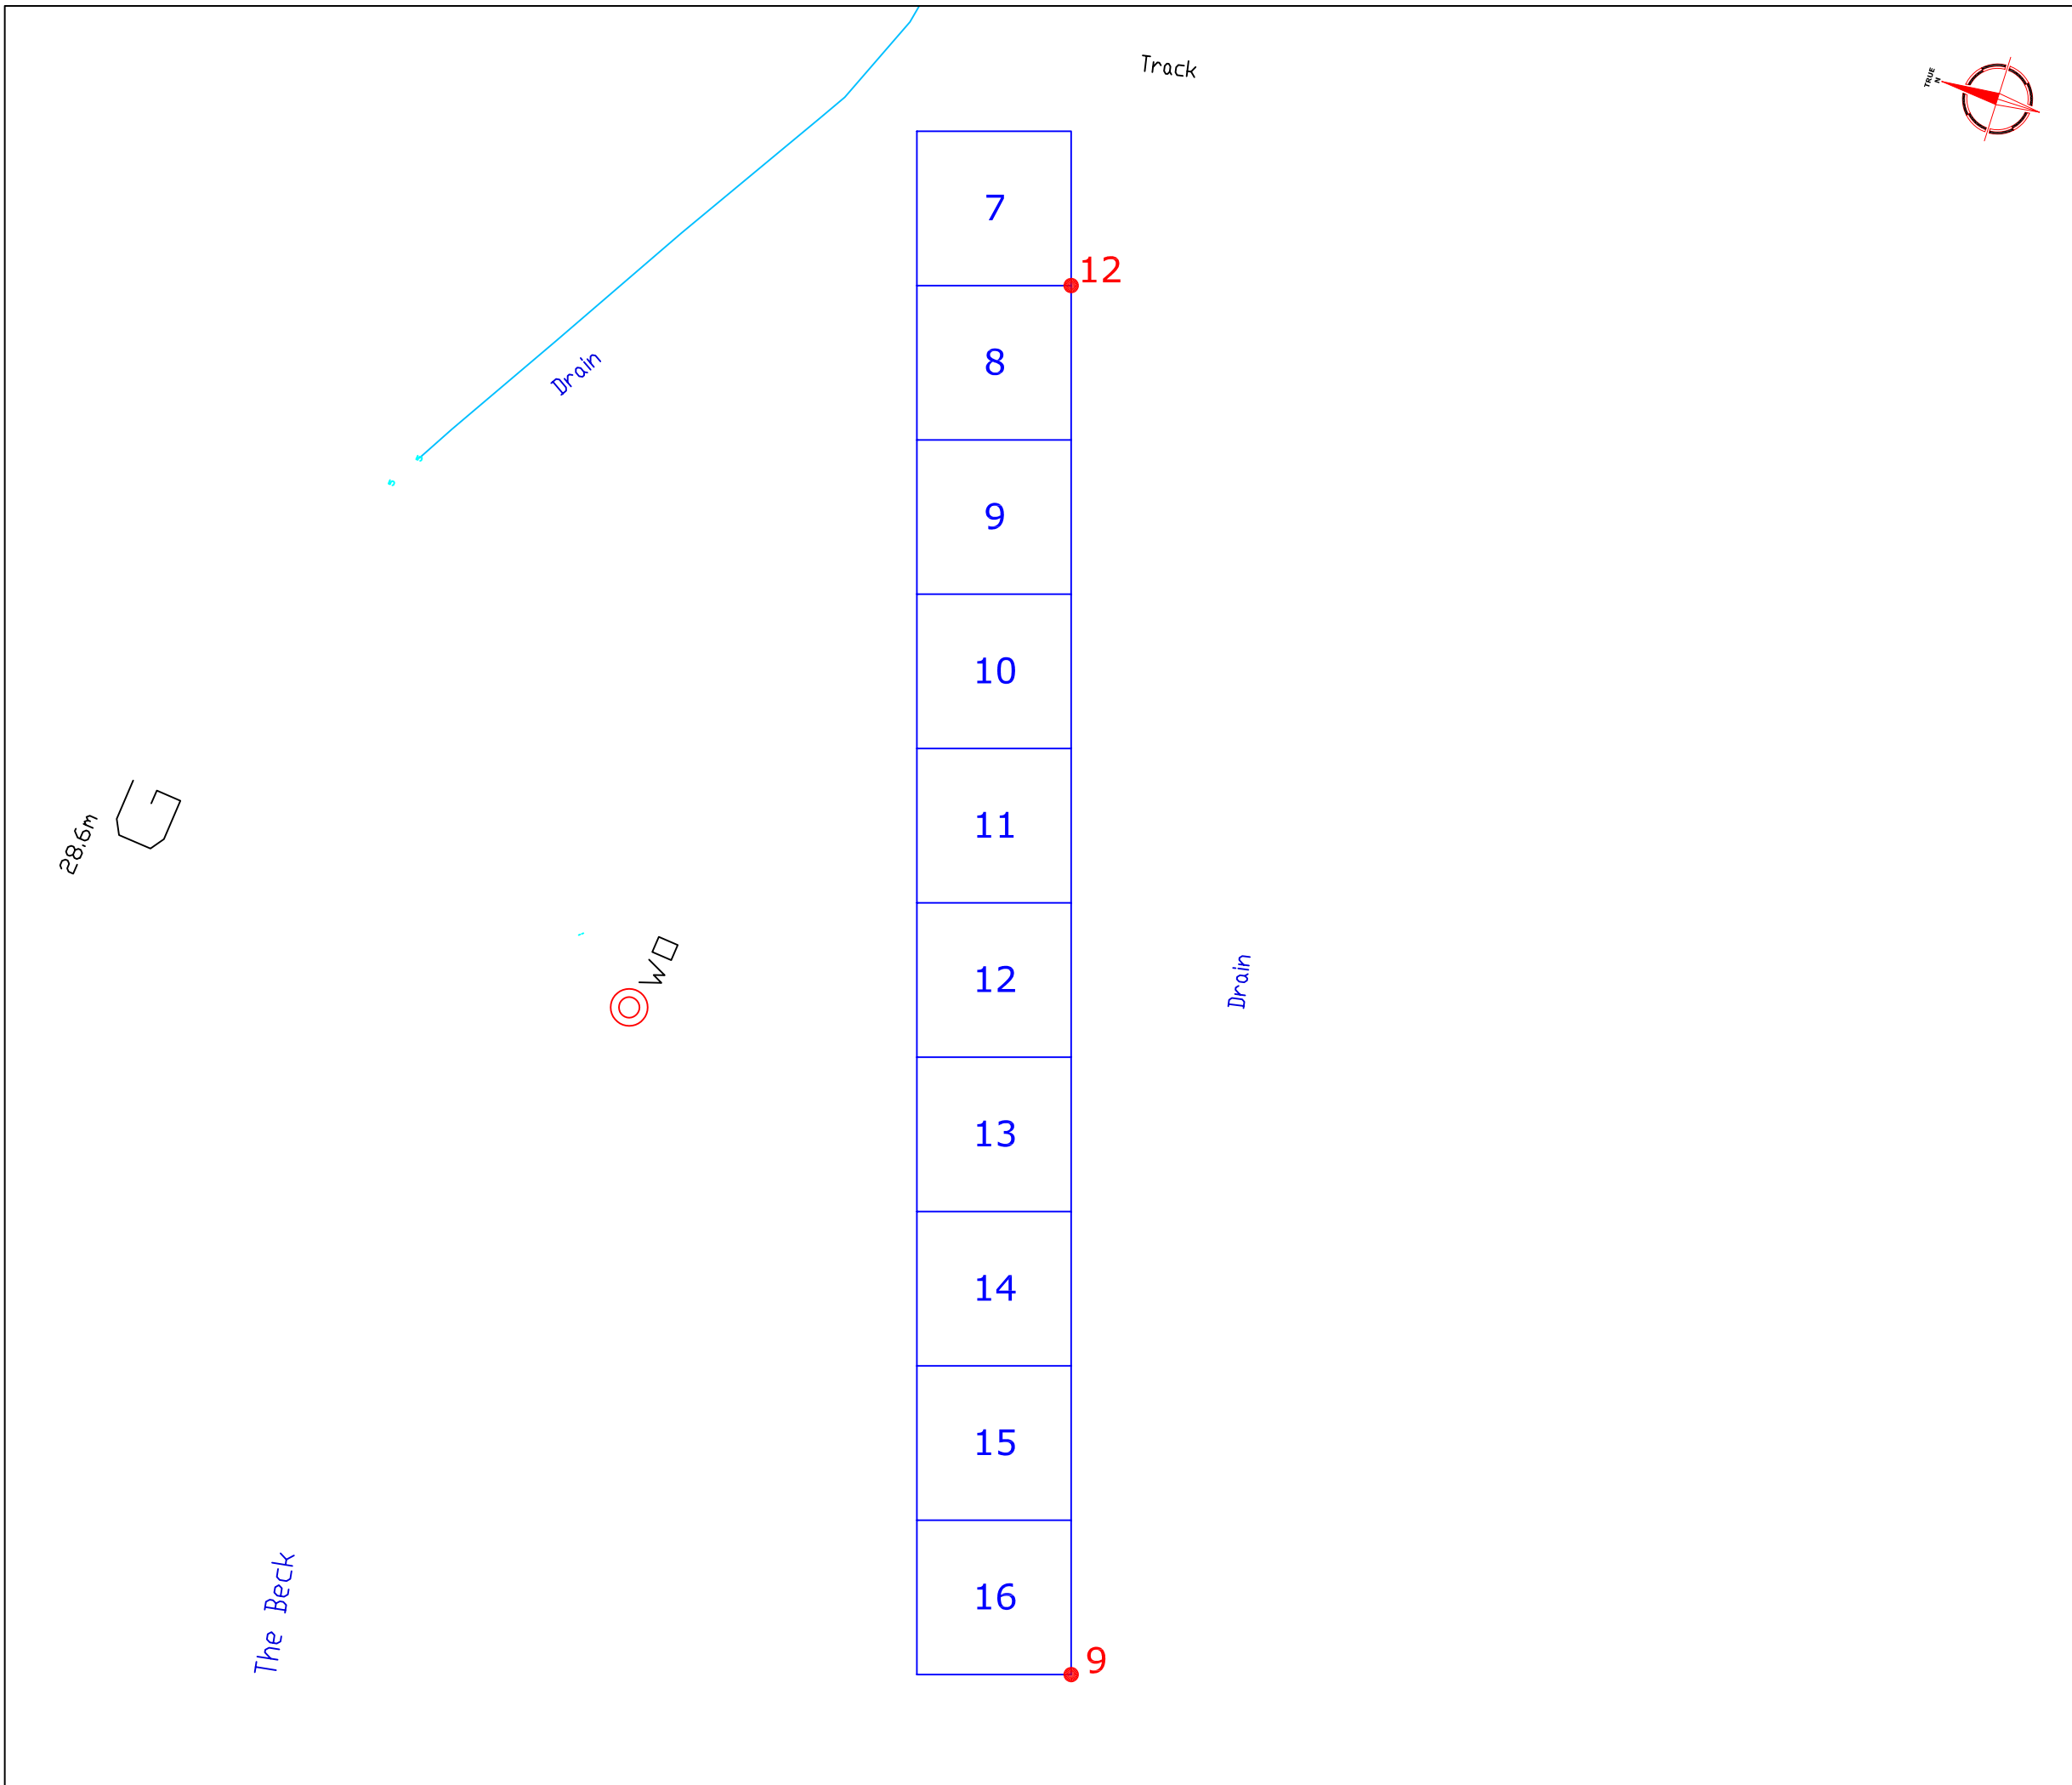

Amendments		
Issue No.	Date	Description
-	-	-
-	-	-
POINT I.D	OS GRID REFERENCE	
9	505582.6 , 337668	
12	505830.5 , 337774.9	
7	Survey grid number	
Client		
APS		
Project Title		Job No. 1998
GEOPHYSICAL SURVEY - HARROWBY-ASWARBY PIPELINE		
Subject		
Referencing -Area 3		
<p>STRATASCAN™</p> <p>GEOPHYSICS FOR ARCHAEOLOGY AND ENGINEERING</p> <p>VINEYARD HOUSE UPPER HOOK ROAD UPTON UPON SEVERN UK WR8 0SA</p> <p>T: +44 (0)1684 592266 F: +44 (0)1684 594142 E: info@stratascan.co.uk www.stratascan.co.uk</p>		
Scale	0m 10 20 30 40 50m	
1:1250		
Plot	Checked by	Issue No.
A3	PPB	01
Survey date	Drawn by	Figure No.
APRIL 05	RAJS	15

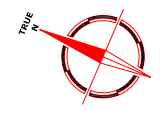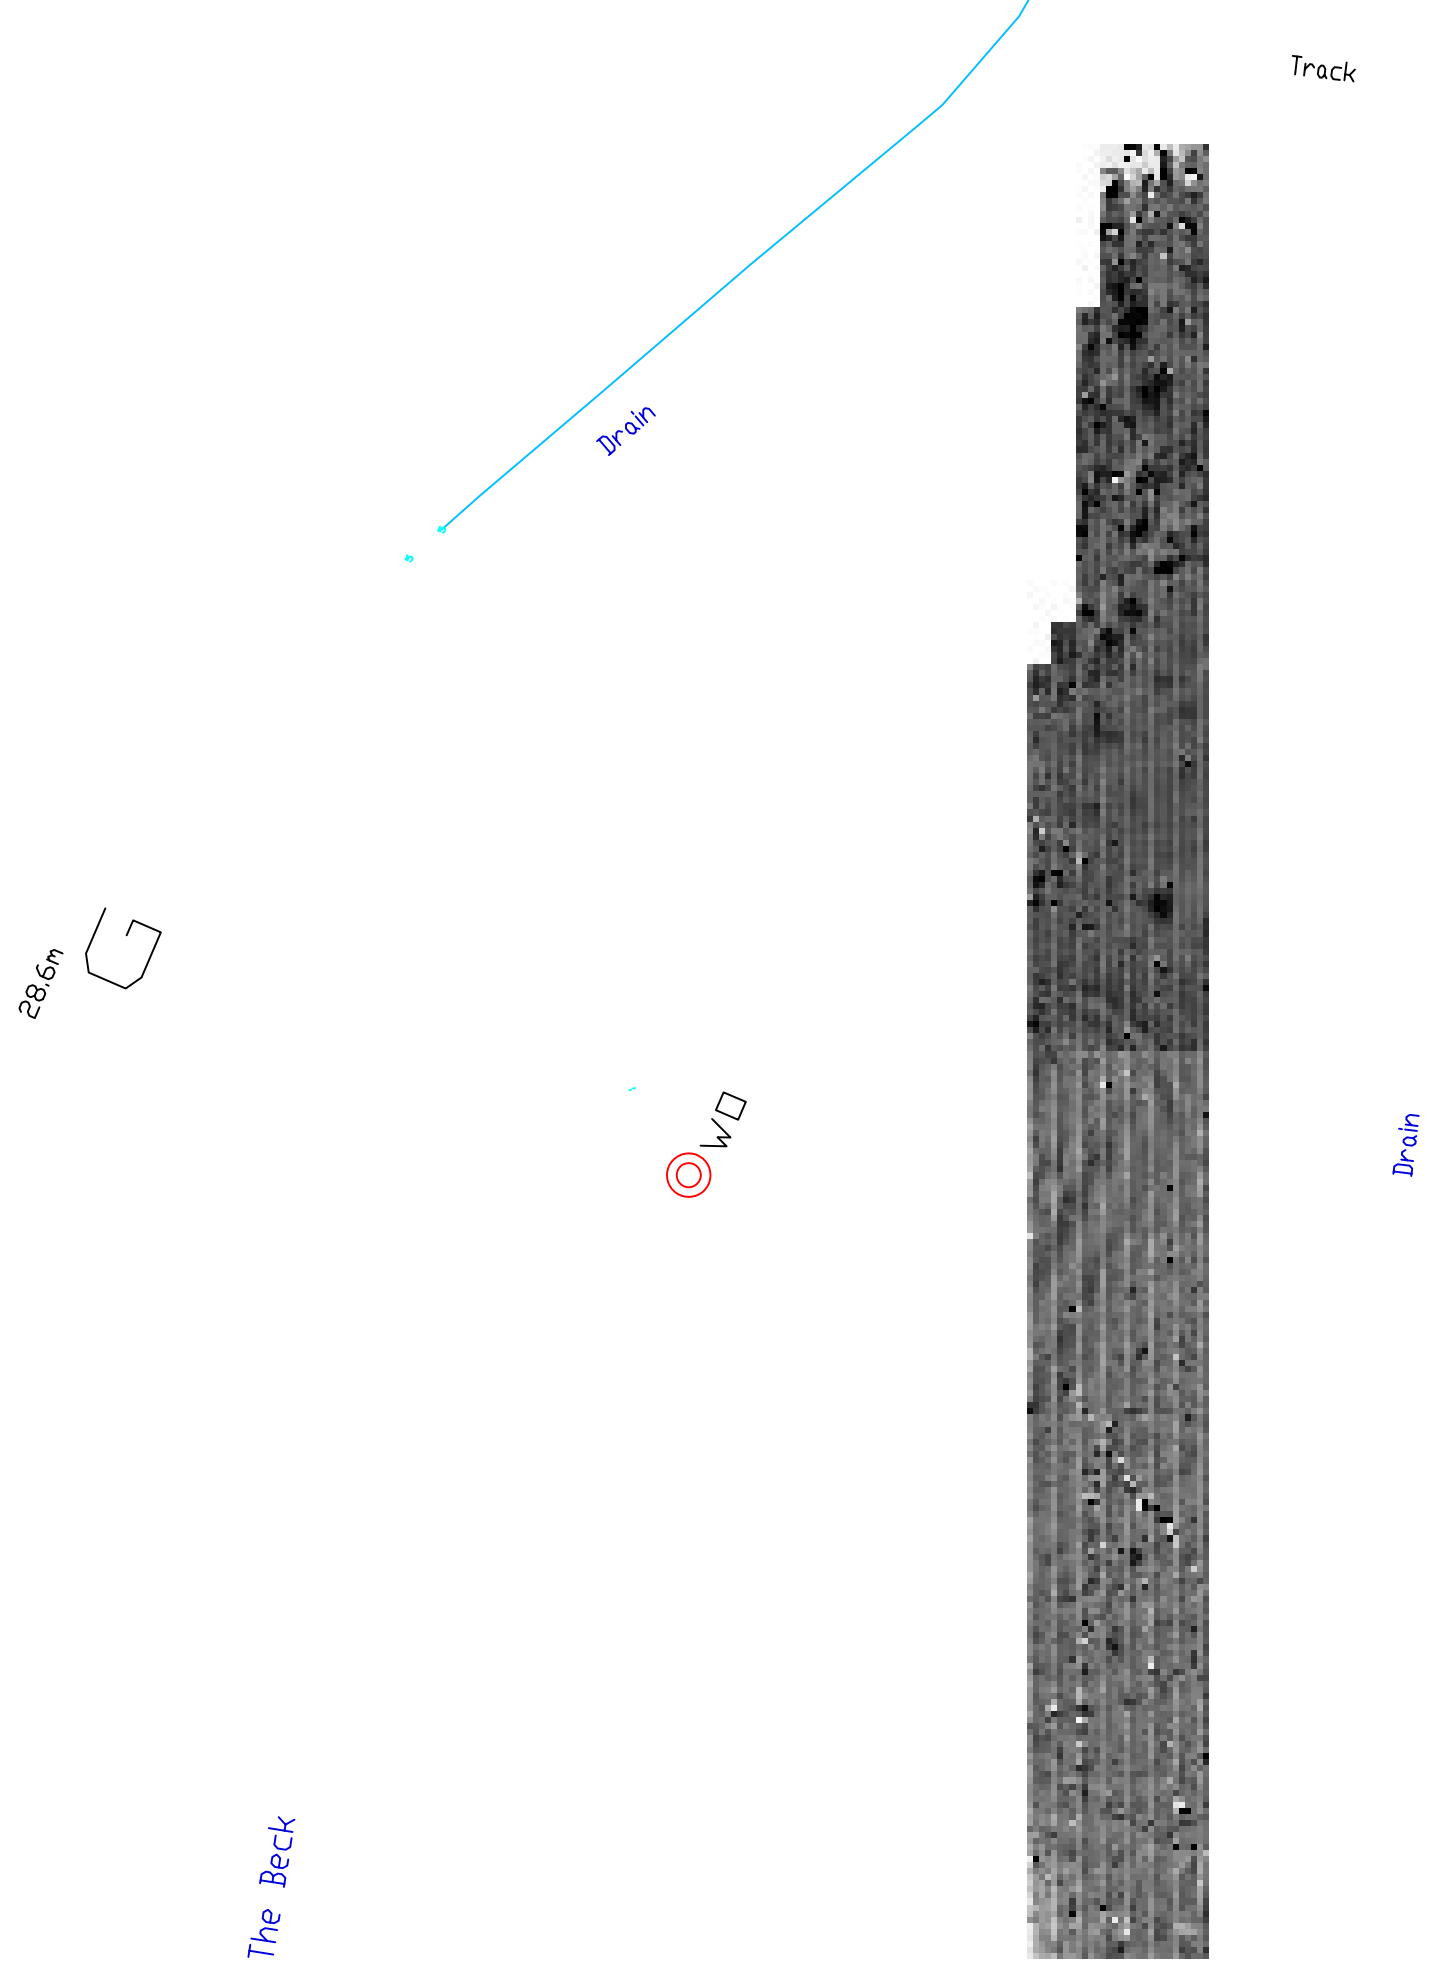

Amendments		
Issue No.	Date	Description
-	-	-
-	-	-




Client
APS



Project Title **GEOPHYSICAL SURVEY - HARROWBY-ASWARBY PIPELINE** Job No. 1998

Subject
PLOT OF RAW MAGNETOMETER DATA - AREA 3

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Plot A3	Checked by PPB	Issue No. 01
Survey date APRIL 05	Drawn by RAJS	Figure No. 16

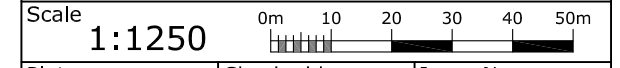

Amendments		
Issue No.	Date	Description
-	-	-
-	-	-
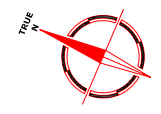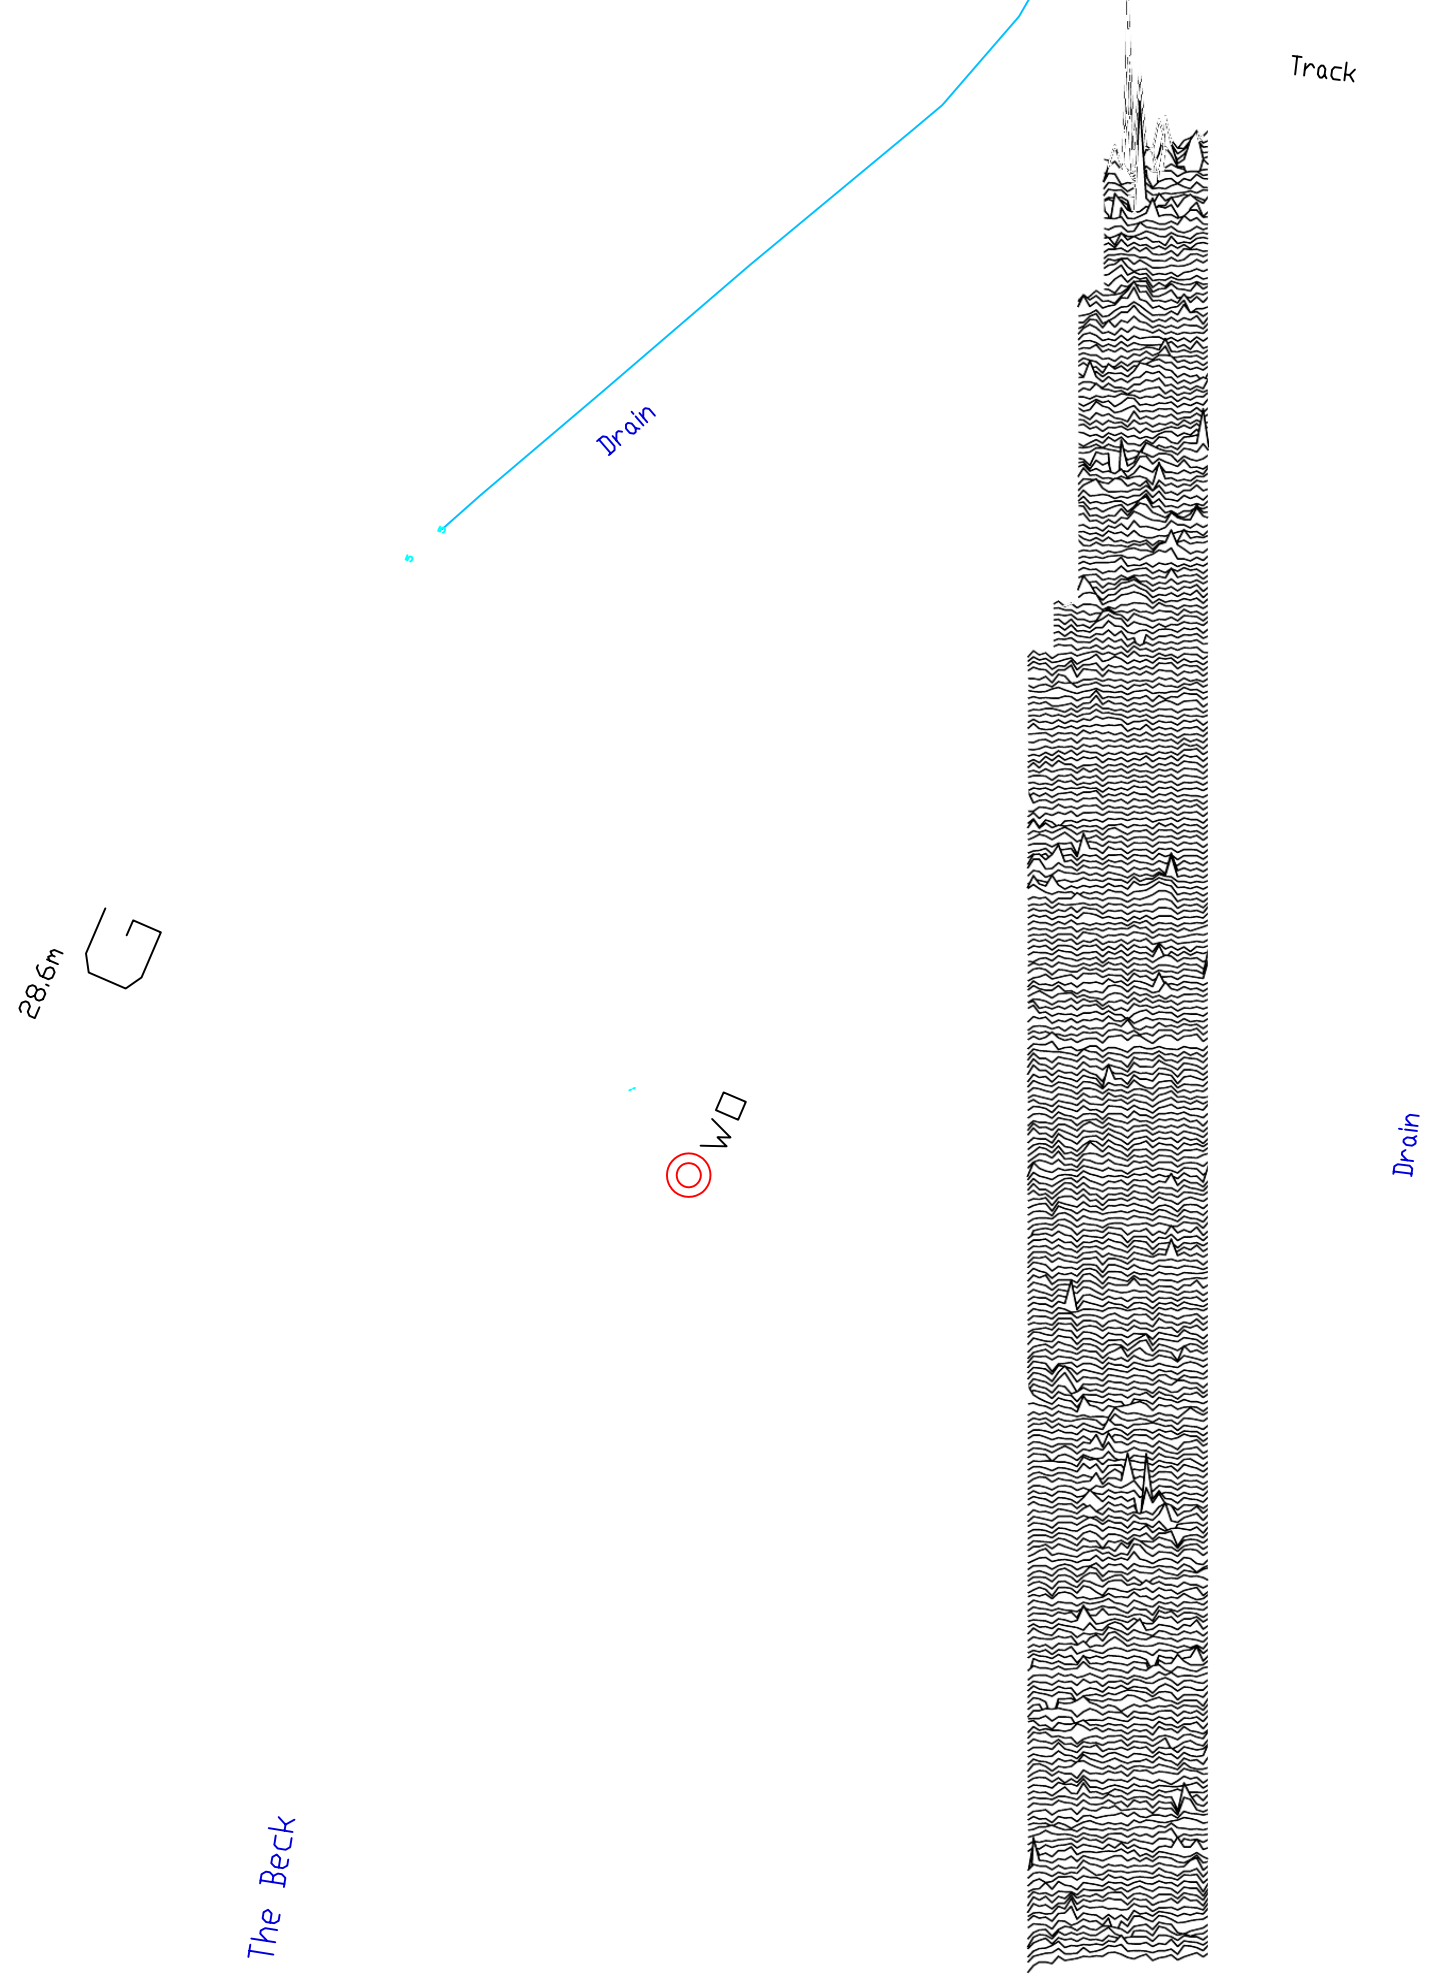
<p>Plotting parameters</p> <p>Standard Deviation at 0.5nT</p> <p><i>(Positive values displace above the trace line. Hidden values have not been plotted)</i></p>	
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Client	APS
--------	-----

Project Title	Job No.
GEOPHYSICAL SURVEY - HARROWBY-ASWARBY PIPELINE	1998

Subject	TRACE PLOT OF RAW MAGNETOMETER DATA SHOWING POSITIVE VALUES - AREA 3
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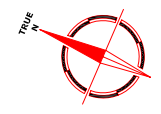
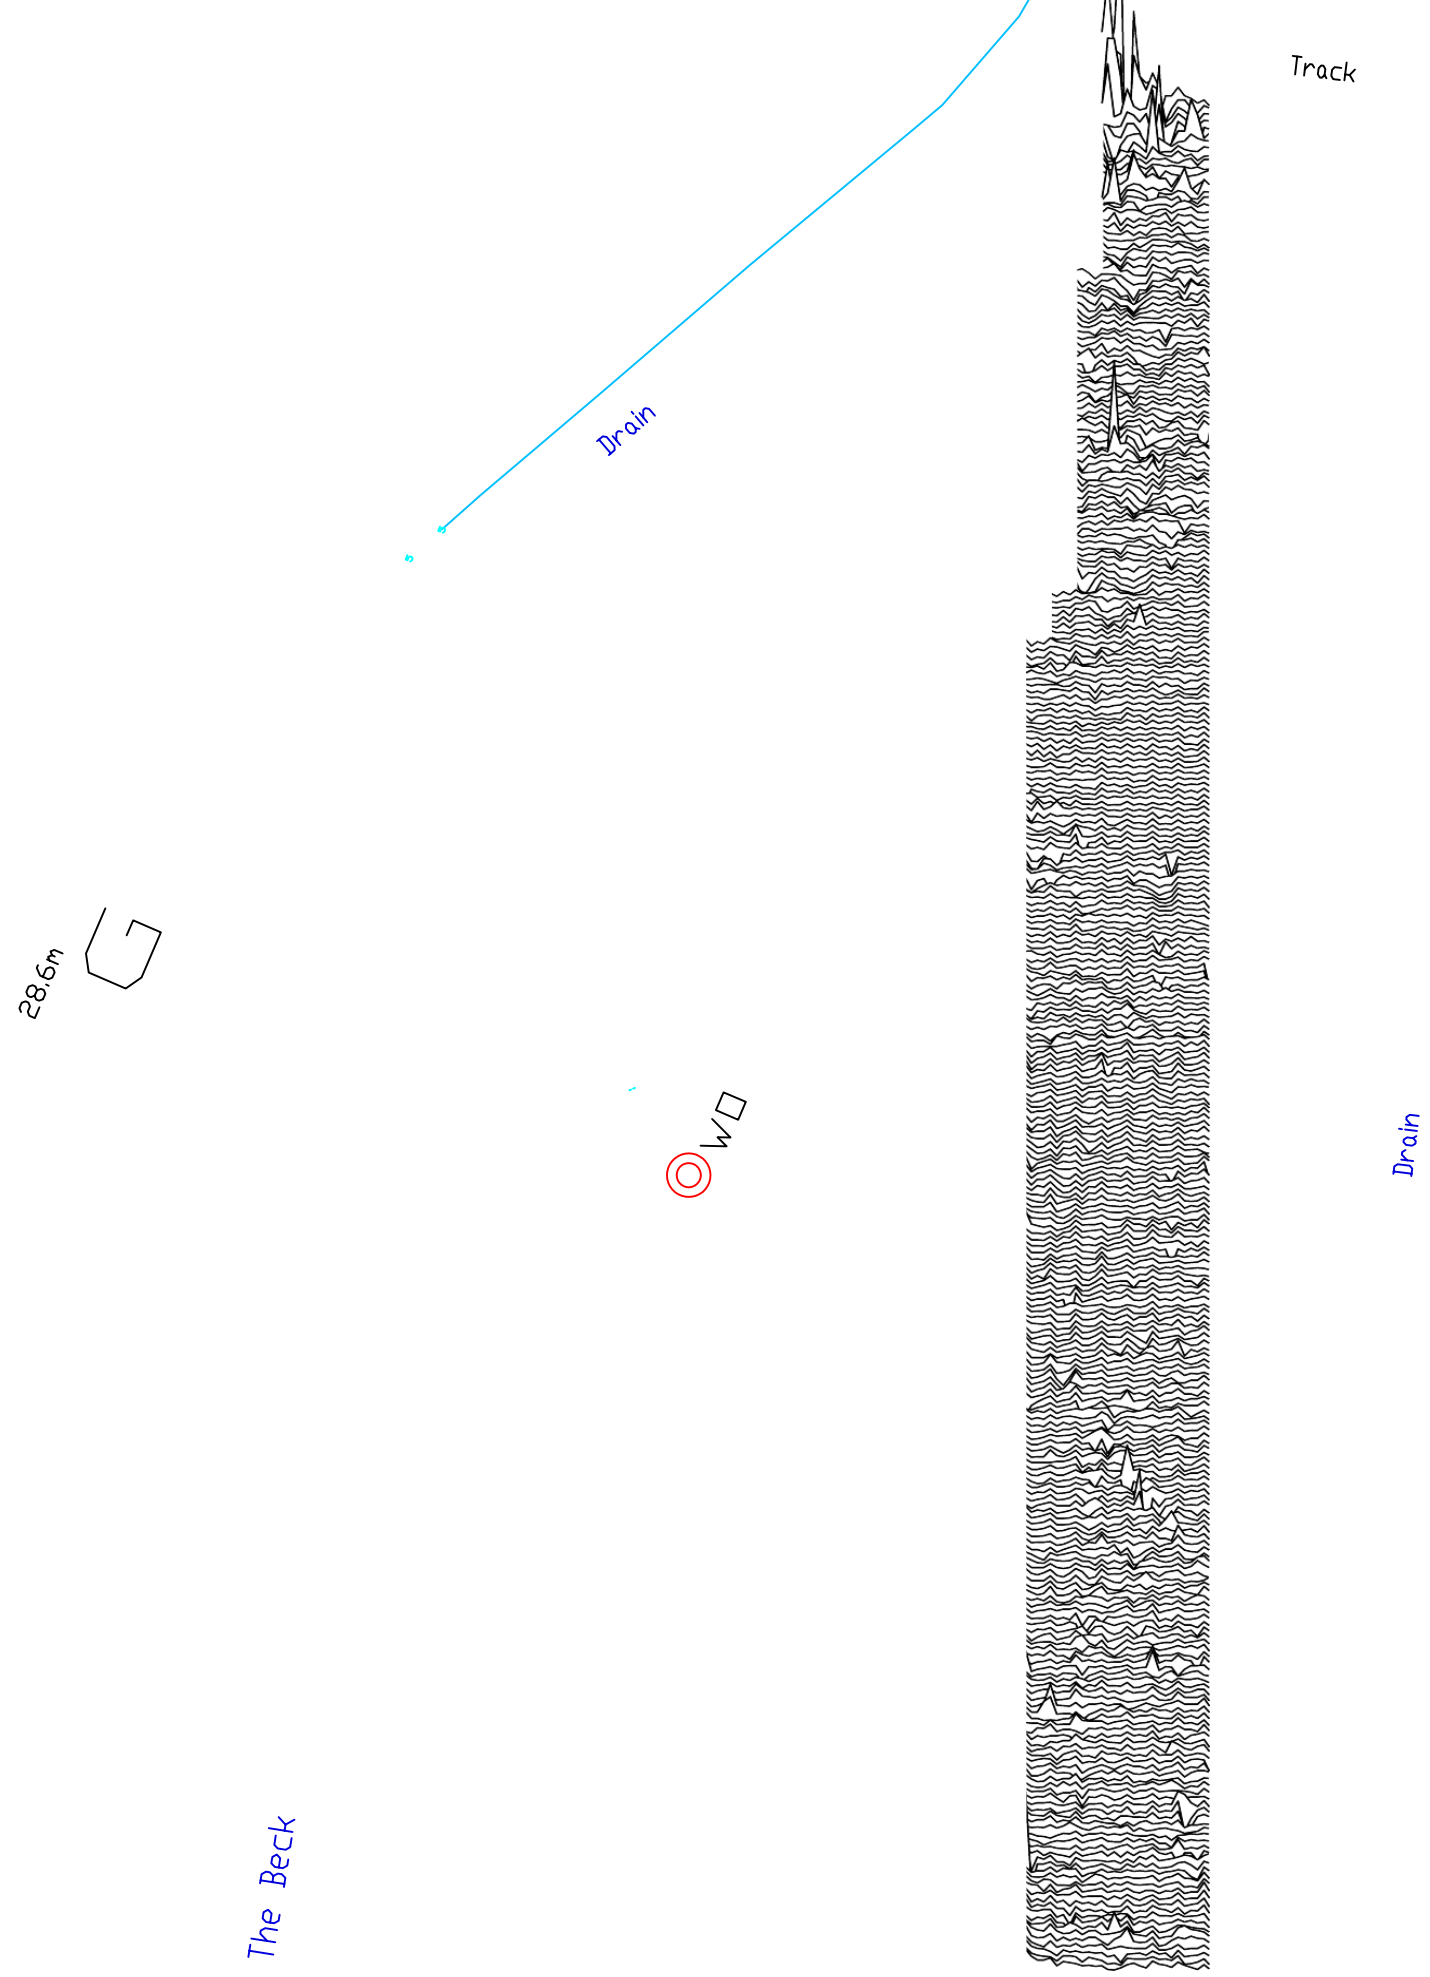
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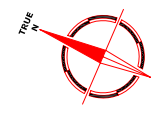
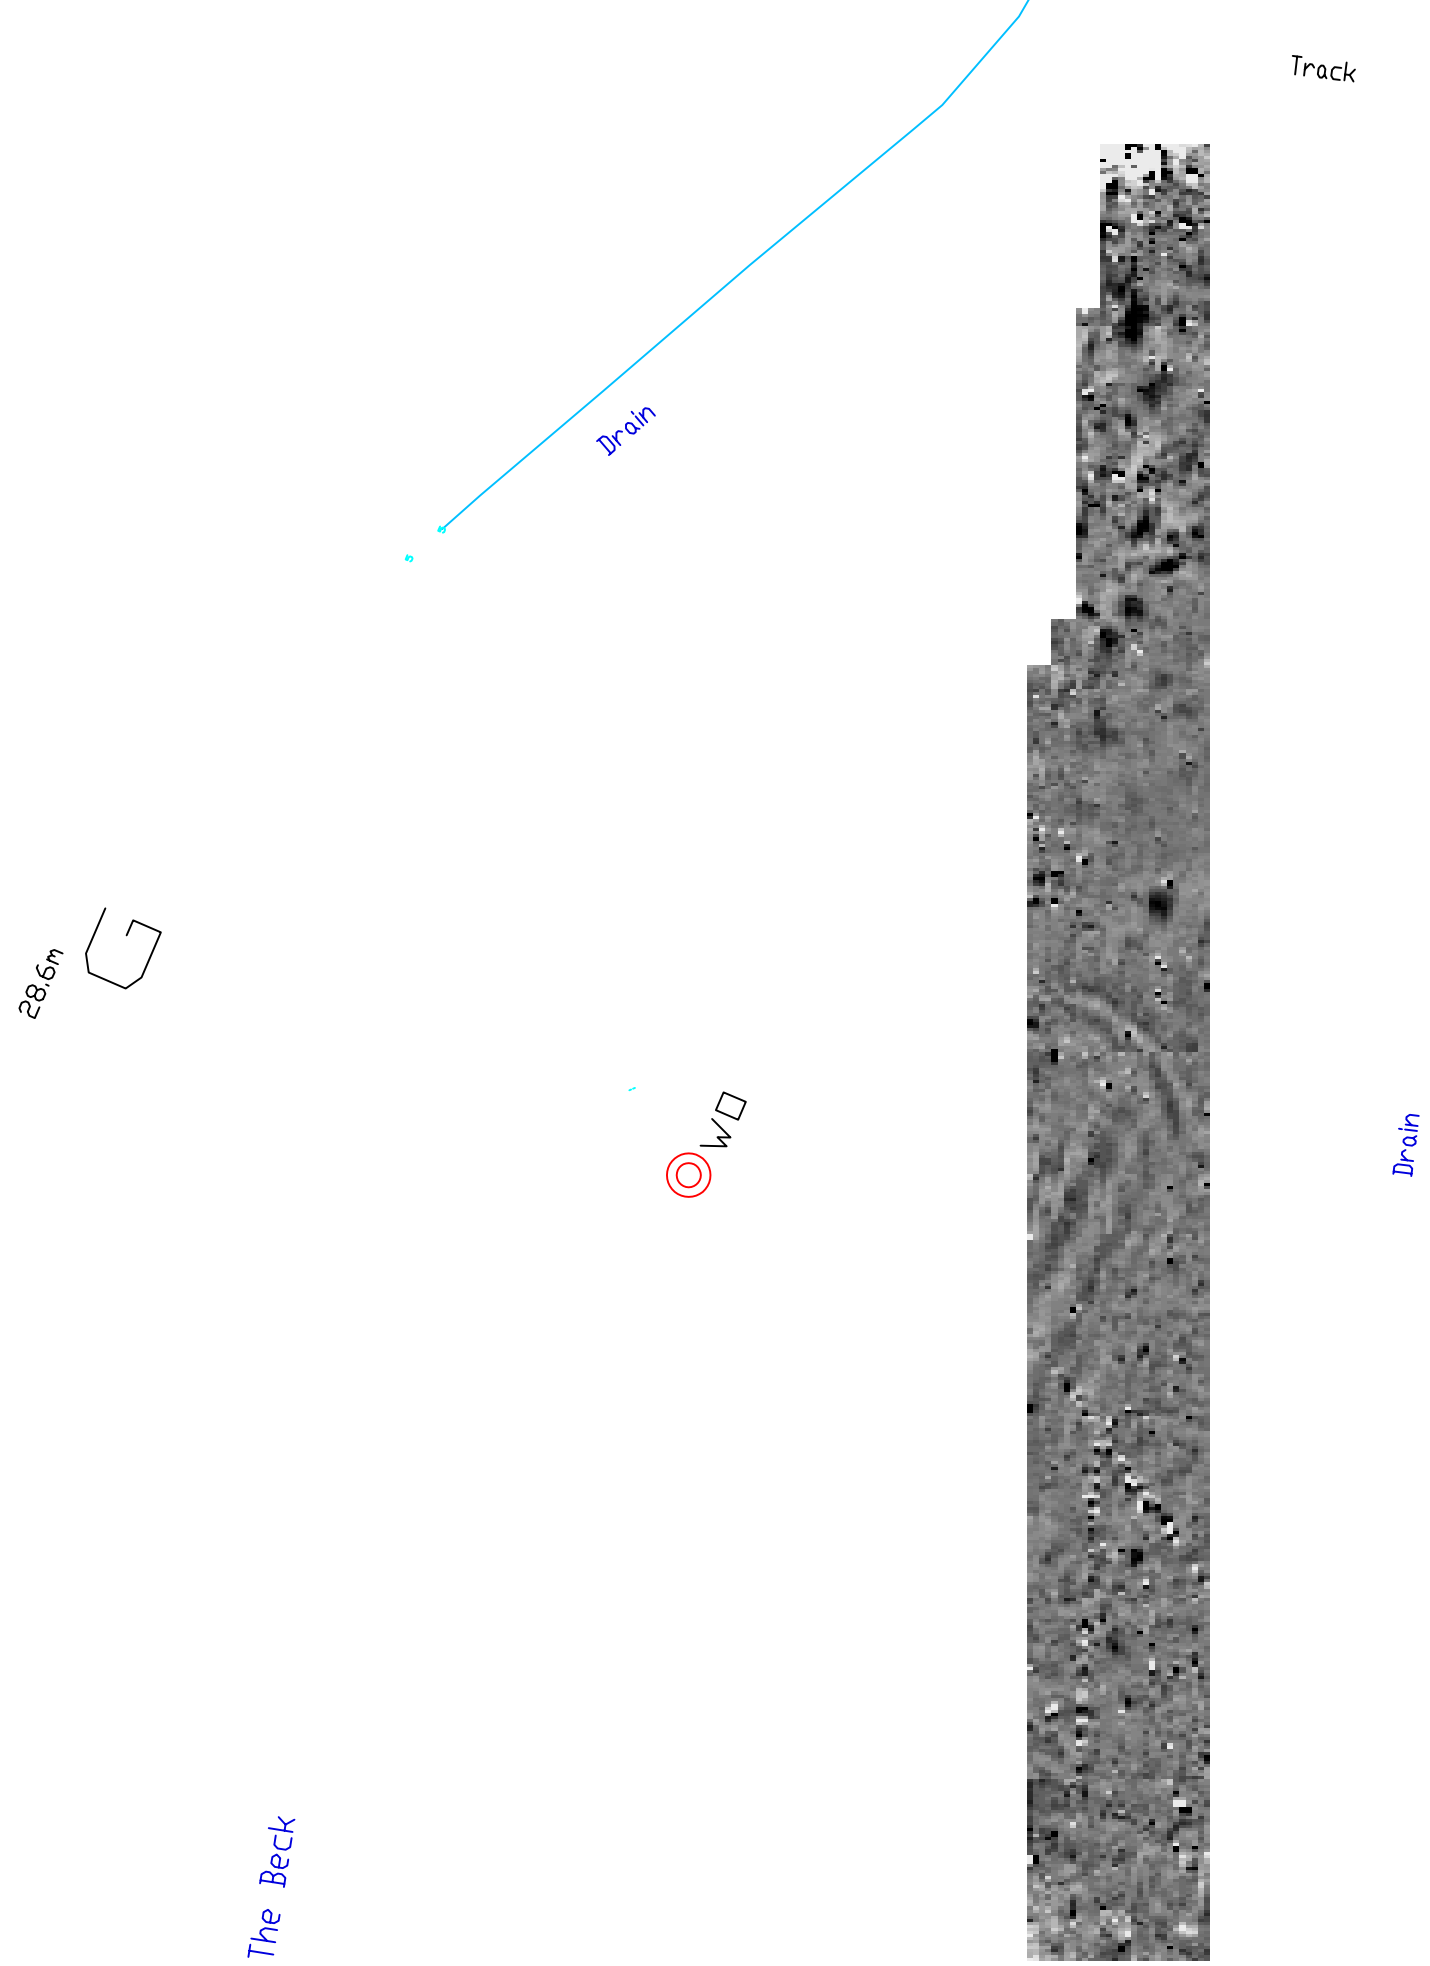
Scale	0m 10 20 30 40 50m	
	1:1250	

Plot	Checked by	Issue No.
A3	PPB	01
Survey date	Drawn by	Figure No.
APRIL 05	RAJS	17





Amendments		
Issue No.	Date	Description
-	-	-
-	-	-

<p>Plotting parameters</p> <p>-40nT</p> <p>(Negative values displace above the trace line. Hidden values have not been plotted)</p>		
Client APS		
Project Title GEOPHYSICAL SURVEY - HARROWBY-ASWARBY PIPELINE		
Job No. 1998		
Subject TRACE PLOT OF RAW MAGNETOMETER DATA SHOWING NEGATIVE VALUES - AREA 3		
<p>STRATASCAN™ GEOPHYSICS FOR ARCHAEOLOGY AND ENGINEERING VINEYARD HOUSE UPPER HOOK ROAD UPTON UPON SEVERN UK WR8 0SA T: +44 (0)1684 592266 F: +44 (0)1684 594142 E: info@stratascan.co.uk www.stratascan.co.uk</p>		
Scale 1:1000		
Plot A3	Checked by PPB	Issue No. 01
Survey date APRIL 05	Drawn by RAJS	Figure No. 18



Amendments		
Issue No.	Date	Description
-	-	-
-	-	-

<p>Plotting parameters</p> <p>Maximum +2nT (black) Minimum -2nT (white)</p>		
Client APS		
Project Title GEOPHYSICAL SURVEY - HARROWBY-ASWARBY PIPELINE		Job No. 1998
Subject PLOT OF PROCESSED MAGNETOMETER DATA - AREA 3		
<p>STRATASCAN™ GEOPHYSICS FOR ARCHAEOLOGY AND ENGINEERING VINEYARD HOUSE UPPER HOOK ROAD UPTON UPON SEVERN UK WR8 0SA T: +44 (0)1684 592266 F: +44 (0)1684 594142 E: info@stratascan.co.uk www.stratascan.co.uk</p>		
Scale 1:1250		
Plot A3	Checked by PPB	Issue No. 01
Survey date APRIL 05	Drawn by RAJS	Figure No. 19

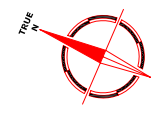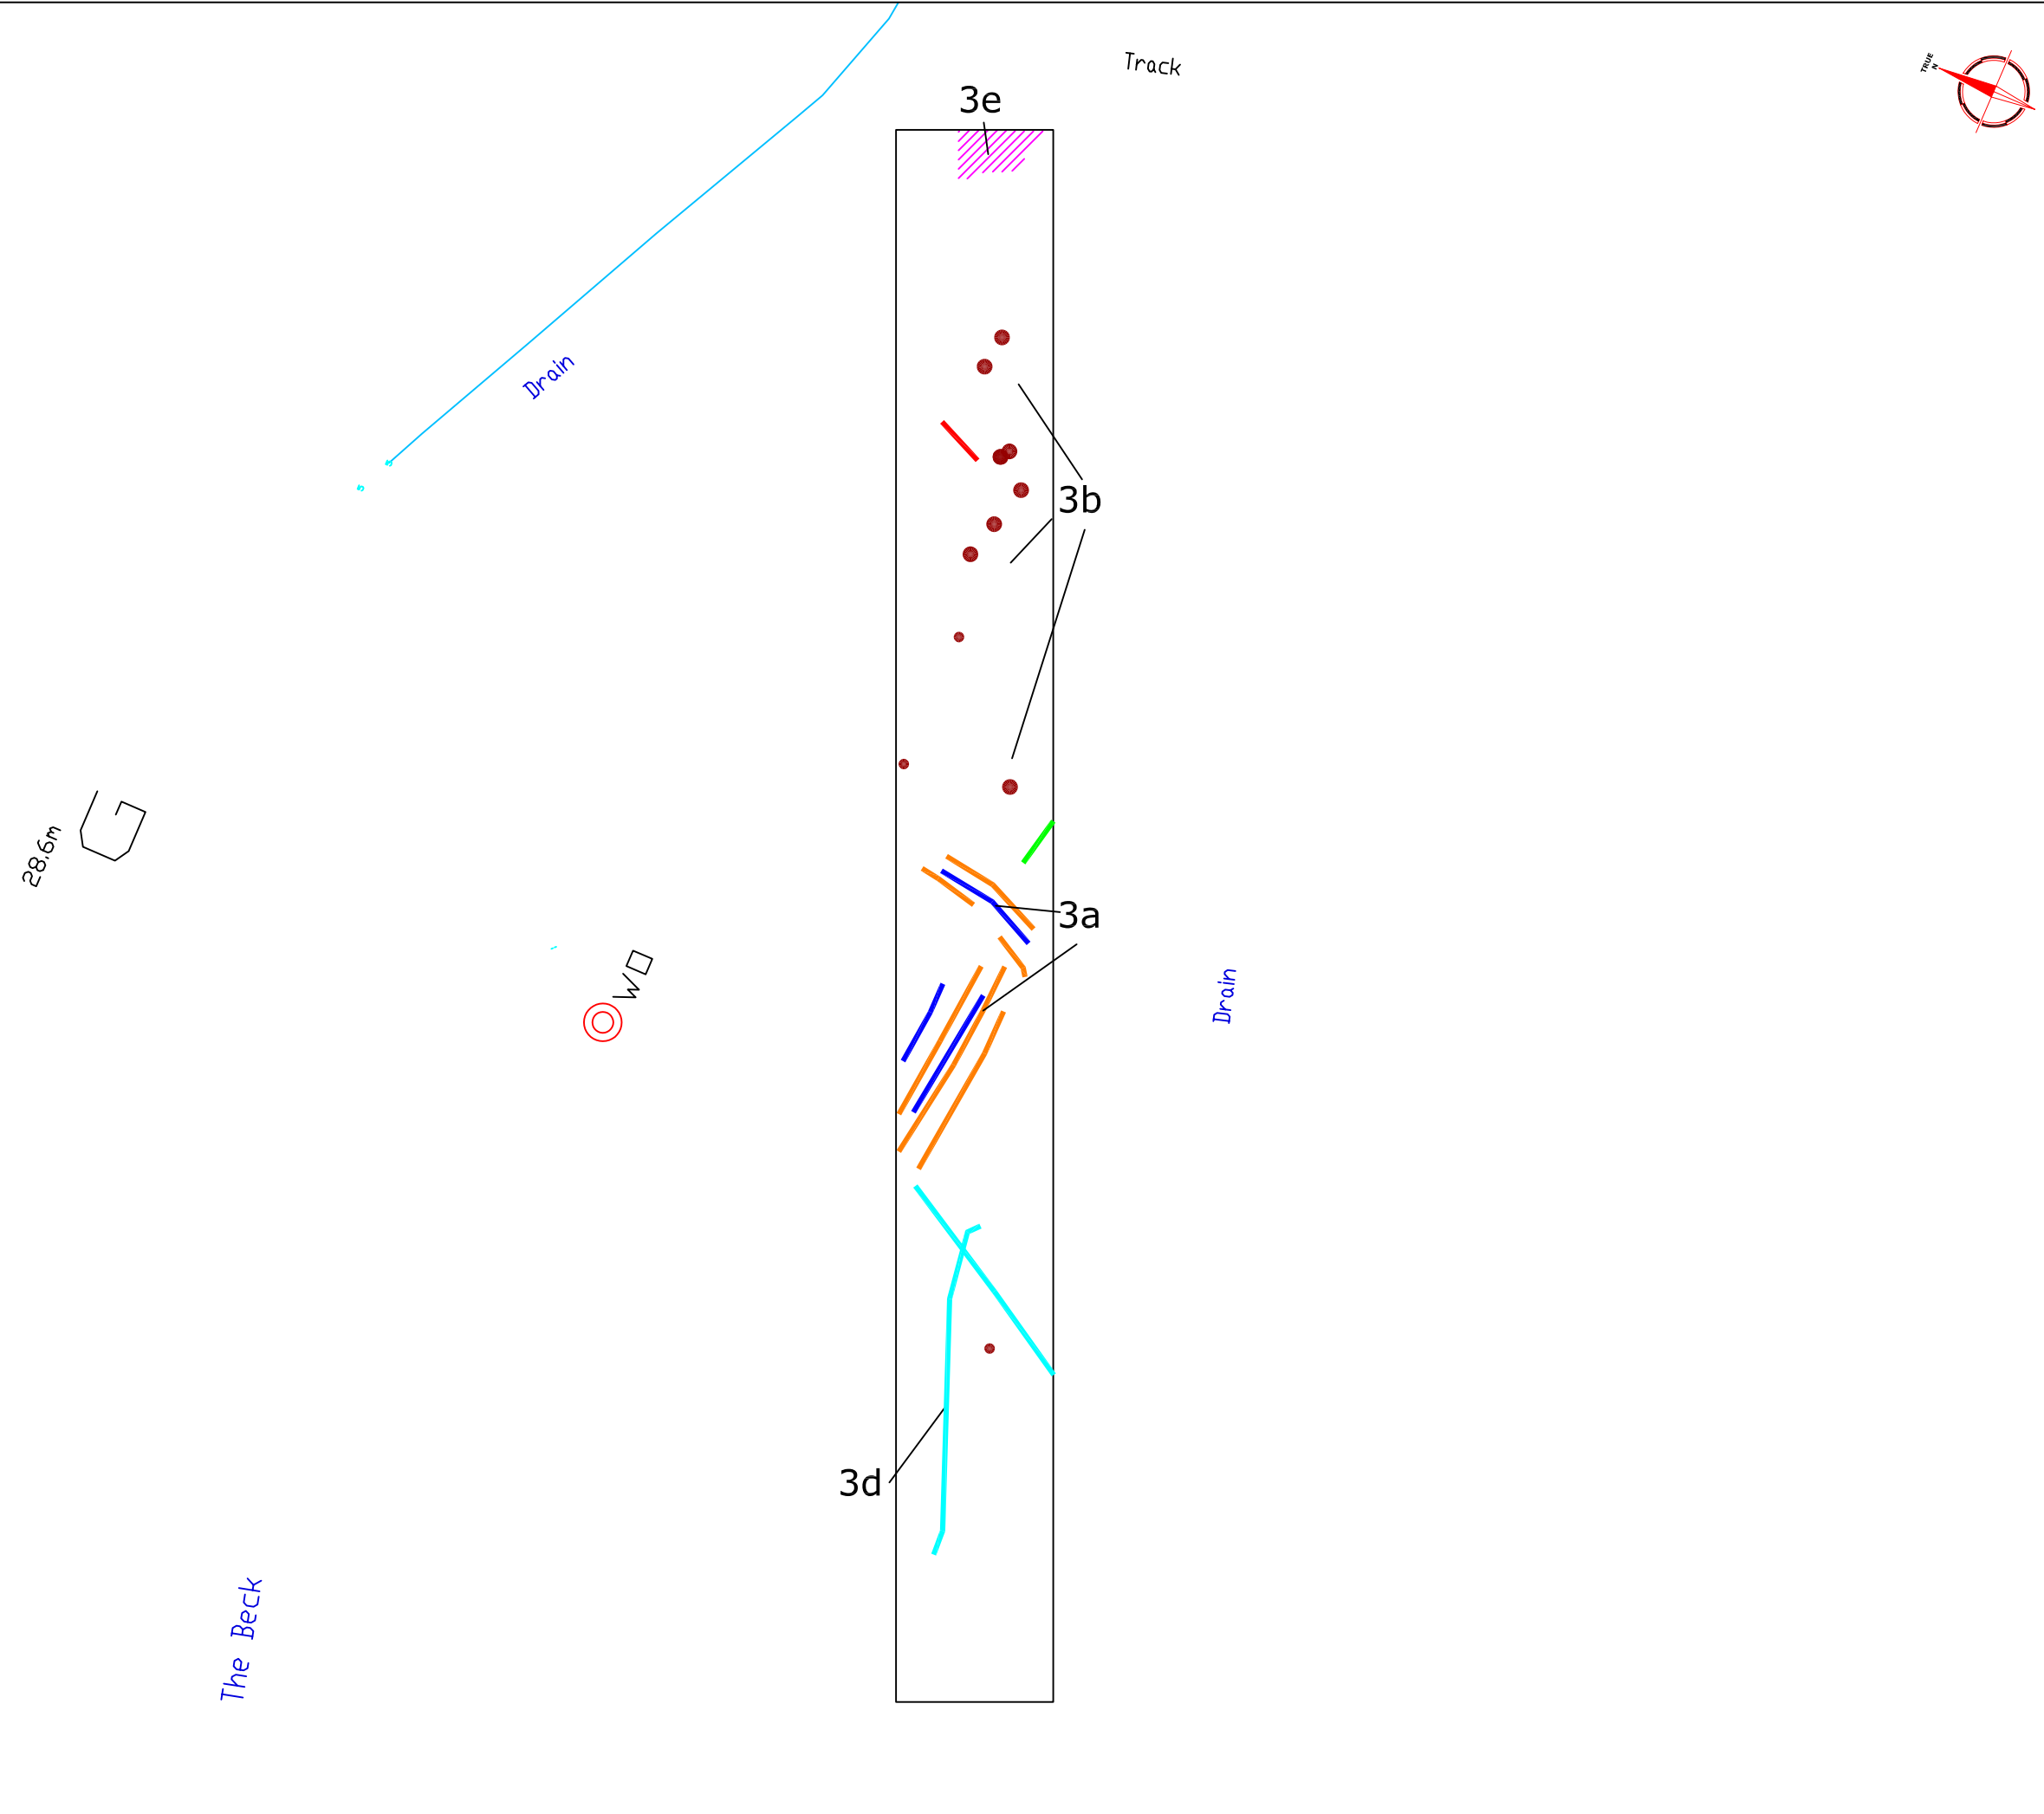

Amendments		
Issue No.	Date	Description
-	-	-
-	-	-


KEY	
3a	Feature I.D number
	Area of magnetic debris/disturbance
	Positive linear anomaly - possible archaeological origin
	Linear anomaly - agricultural mark
	Negative linear anomaly - embankment/earthwork remains
	Positive linear anomaly of unknown origin
	Land Drain
	Discrete positive anomaly - possible pit

Client	APS	
Project Title	GEOPHYSICAL SURVEY - HARROWBY-ASWARBY PIPELINE	
Job No.	1998	
Subject	ABSTRACTION AND INTERPRETATION OF MAGNETOMETER ANOMALIES - AREA 3	

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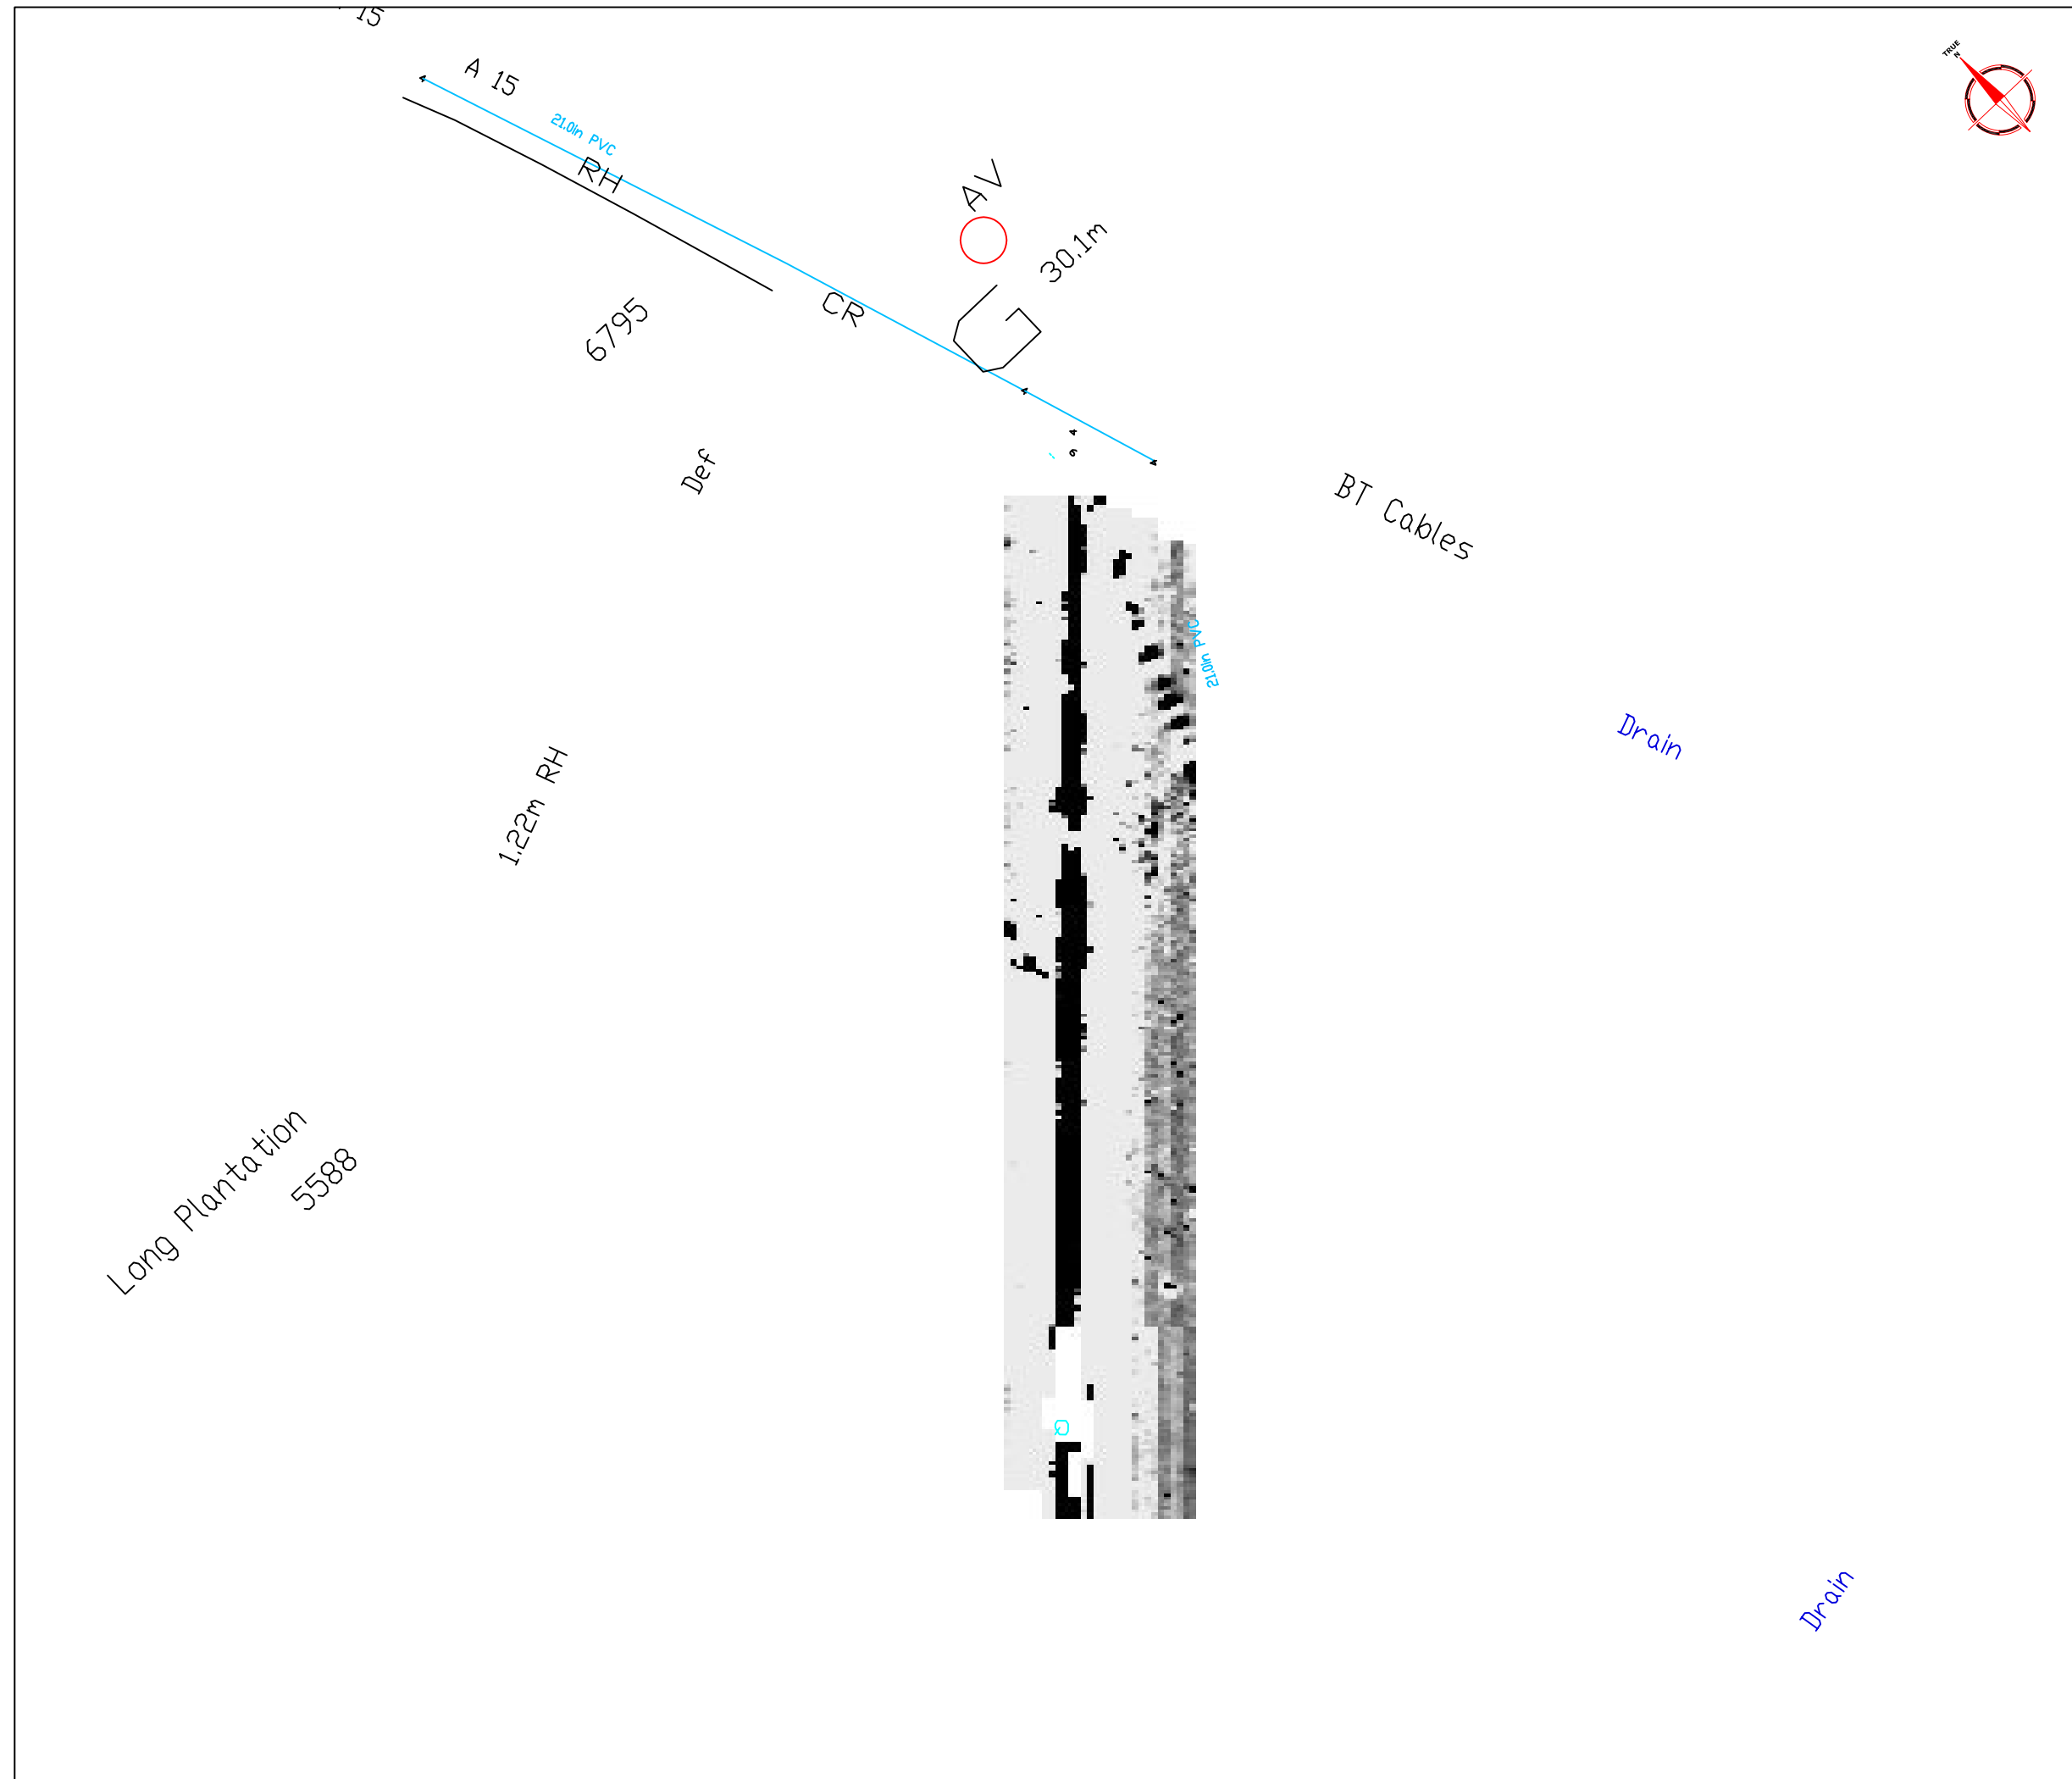
Scale	1:1250	

Plot	Checked by	Issue No.
A3	PPB	01
Survey date	Drawn by	Figure No.
APRIL 05	RAJS	20

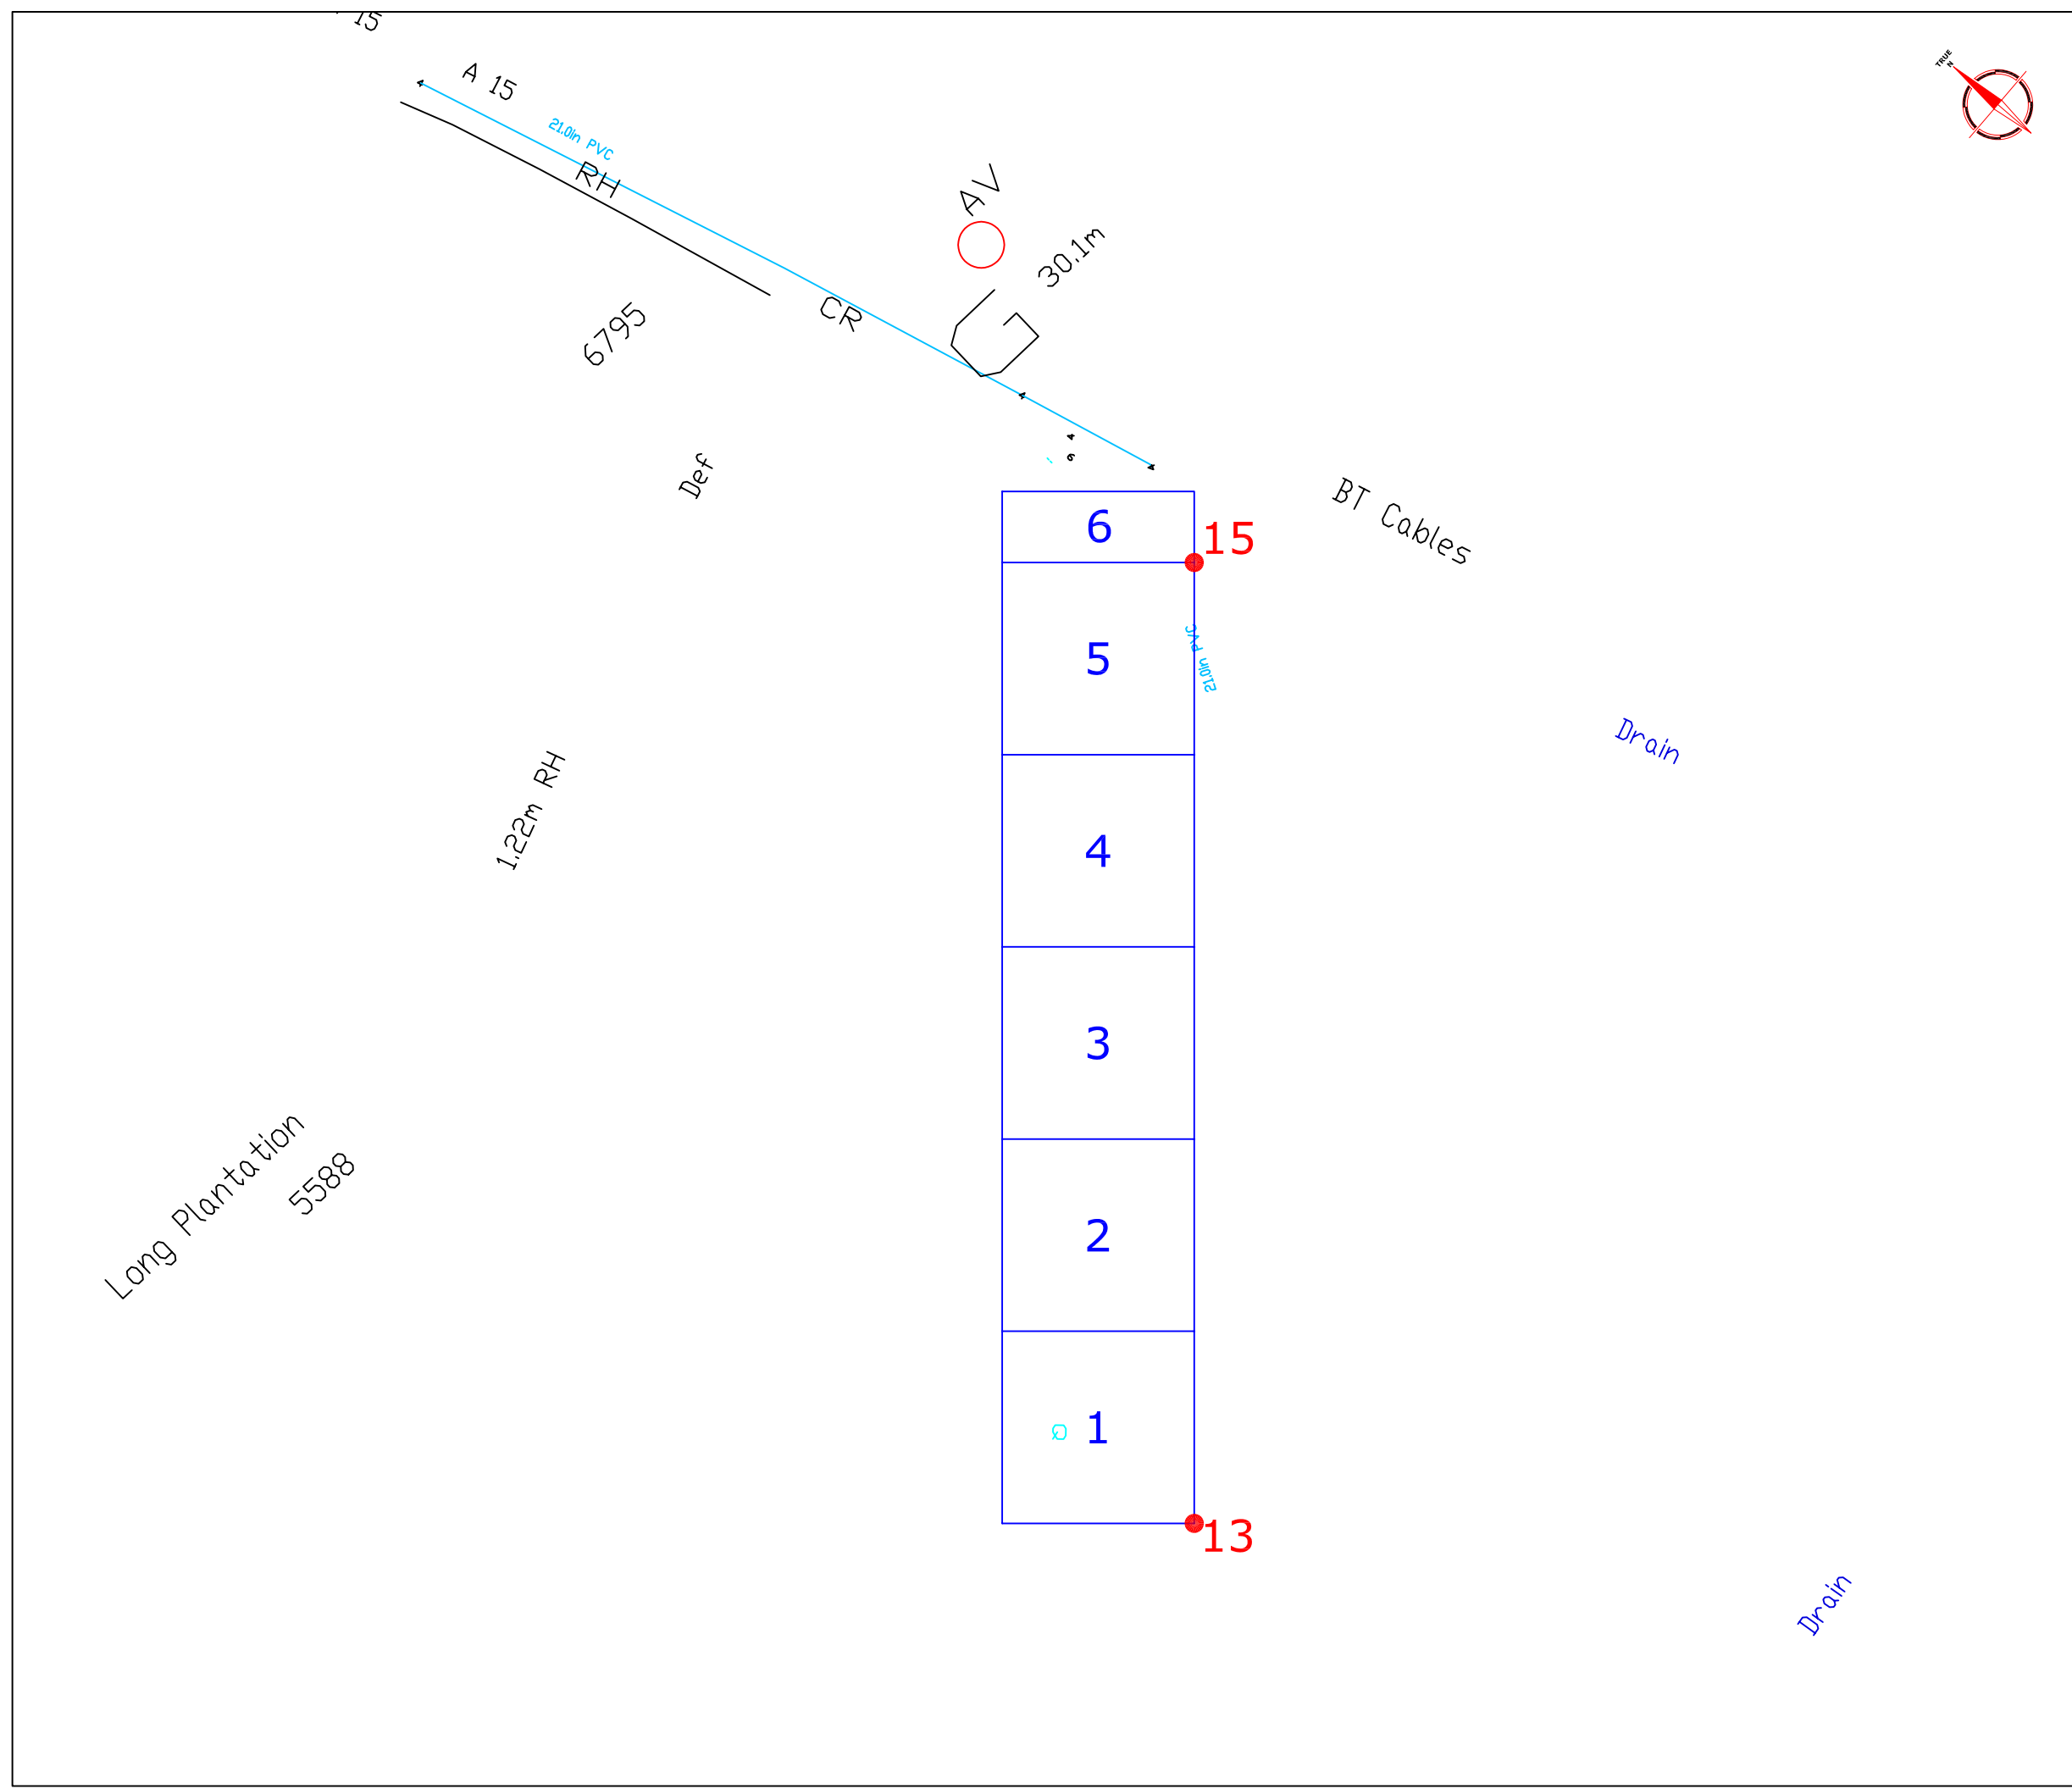


Amendments		
Issue No.	Date	Description
-	-	-
-	-	-

POINT I.D	OS GRID REFERENCE	
13	506614.9 , 338753.7	
15	506718 , 338862.6	
1	Survey grid number	
Client APS		
Project Title GEOPHYSICAL SURVEY - HARROWBY-ASWARBY PIPELINE		
Job No. 1998		
Subject Referencing- Area 4		
<p>STRATASCANTM GEOPHYSICS FOR ARCHAEOLOGY AND ENGINEERING VINEYARD HOUSE UPPER HOOK ROAD UPTON UPON SEVERN UK WR8 0SA T: +44 (0)1684 592266 F: +44 (0)1684 594142 E: info@stratascan.co.uk www.stratascan.co.uk</p>		
Scale 1:1000 		
Plot A3	Checked by PPB	Issue No. 01
Survey date APRIL 05	Drawn by RAJS	Figure No. 21



Amendments		
Issue No.	Date	Description
-	-	-
-	-	-

Plotting parameters Maximum +3nT (black) Minimum -3nT (white)		
Client APS		
Project Title GEOPHYSICAL SURVEY - HARROWBY-ASWARBY PIPELINE		Job No. 1998
Subject PLOT OF RAW MAGNETOMETER DATA - AREA 4		
 STRATASCAN™ GEOPHYSICS FOR ARCHAEOLOGY AND ENGINEERING VINEYARD HOUSE UPPER HOOK ROAD UPTON UPON SEVERN UK WR8 0SA T: +44 (0)1684 592266 F: +44 (0)1684 594142 E: info@stratascan.co.uk www.stratascan.co.uk		
Scale 1:1000		
Plot A3	Checked by PPB	Issue No. 01
Survey date APRIL 05	Drawn by RAJS	Figure No. 22

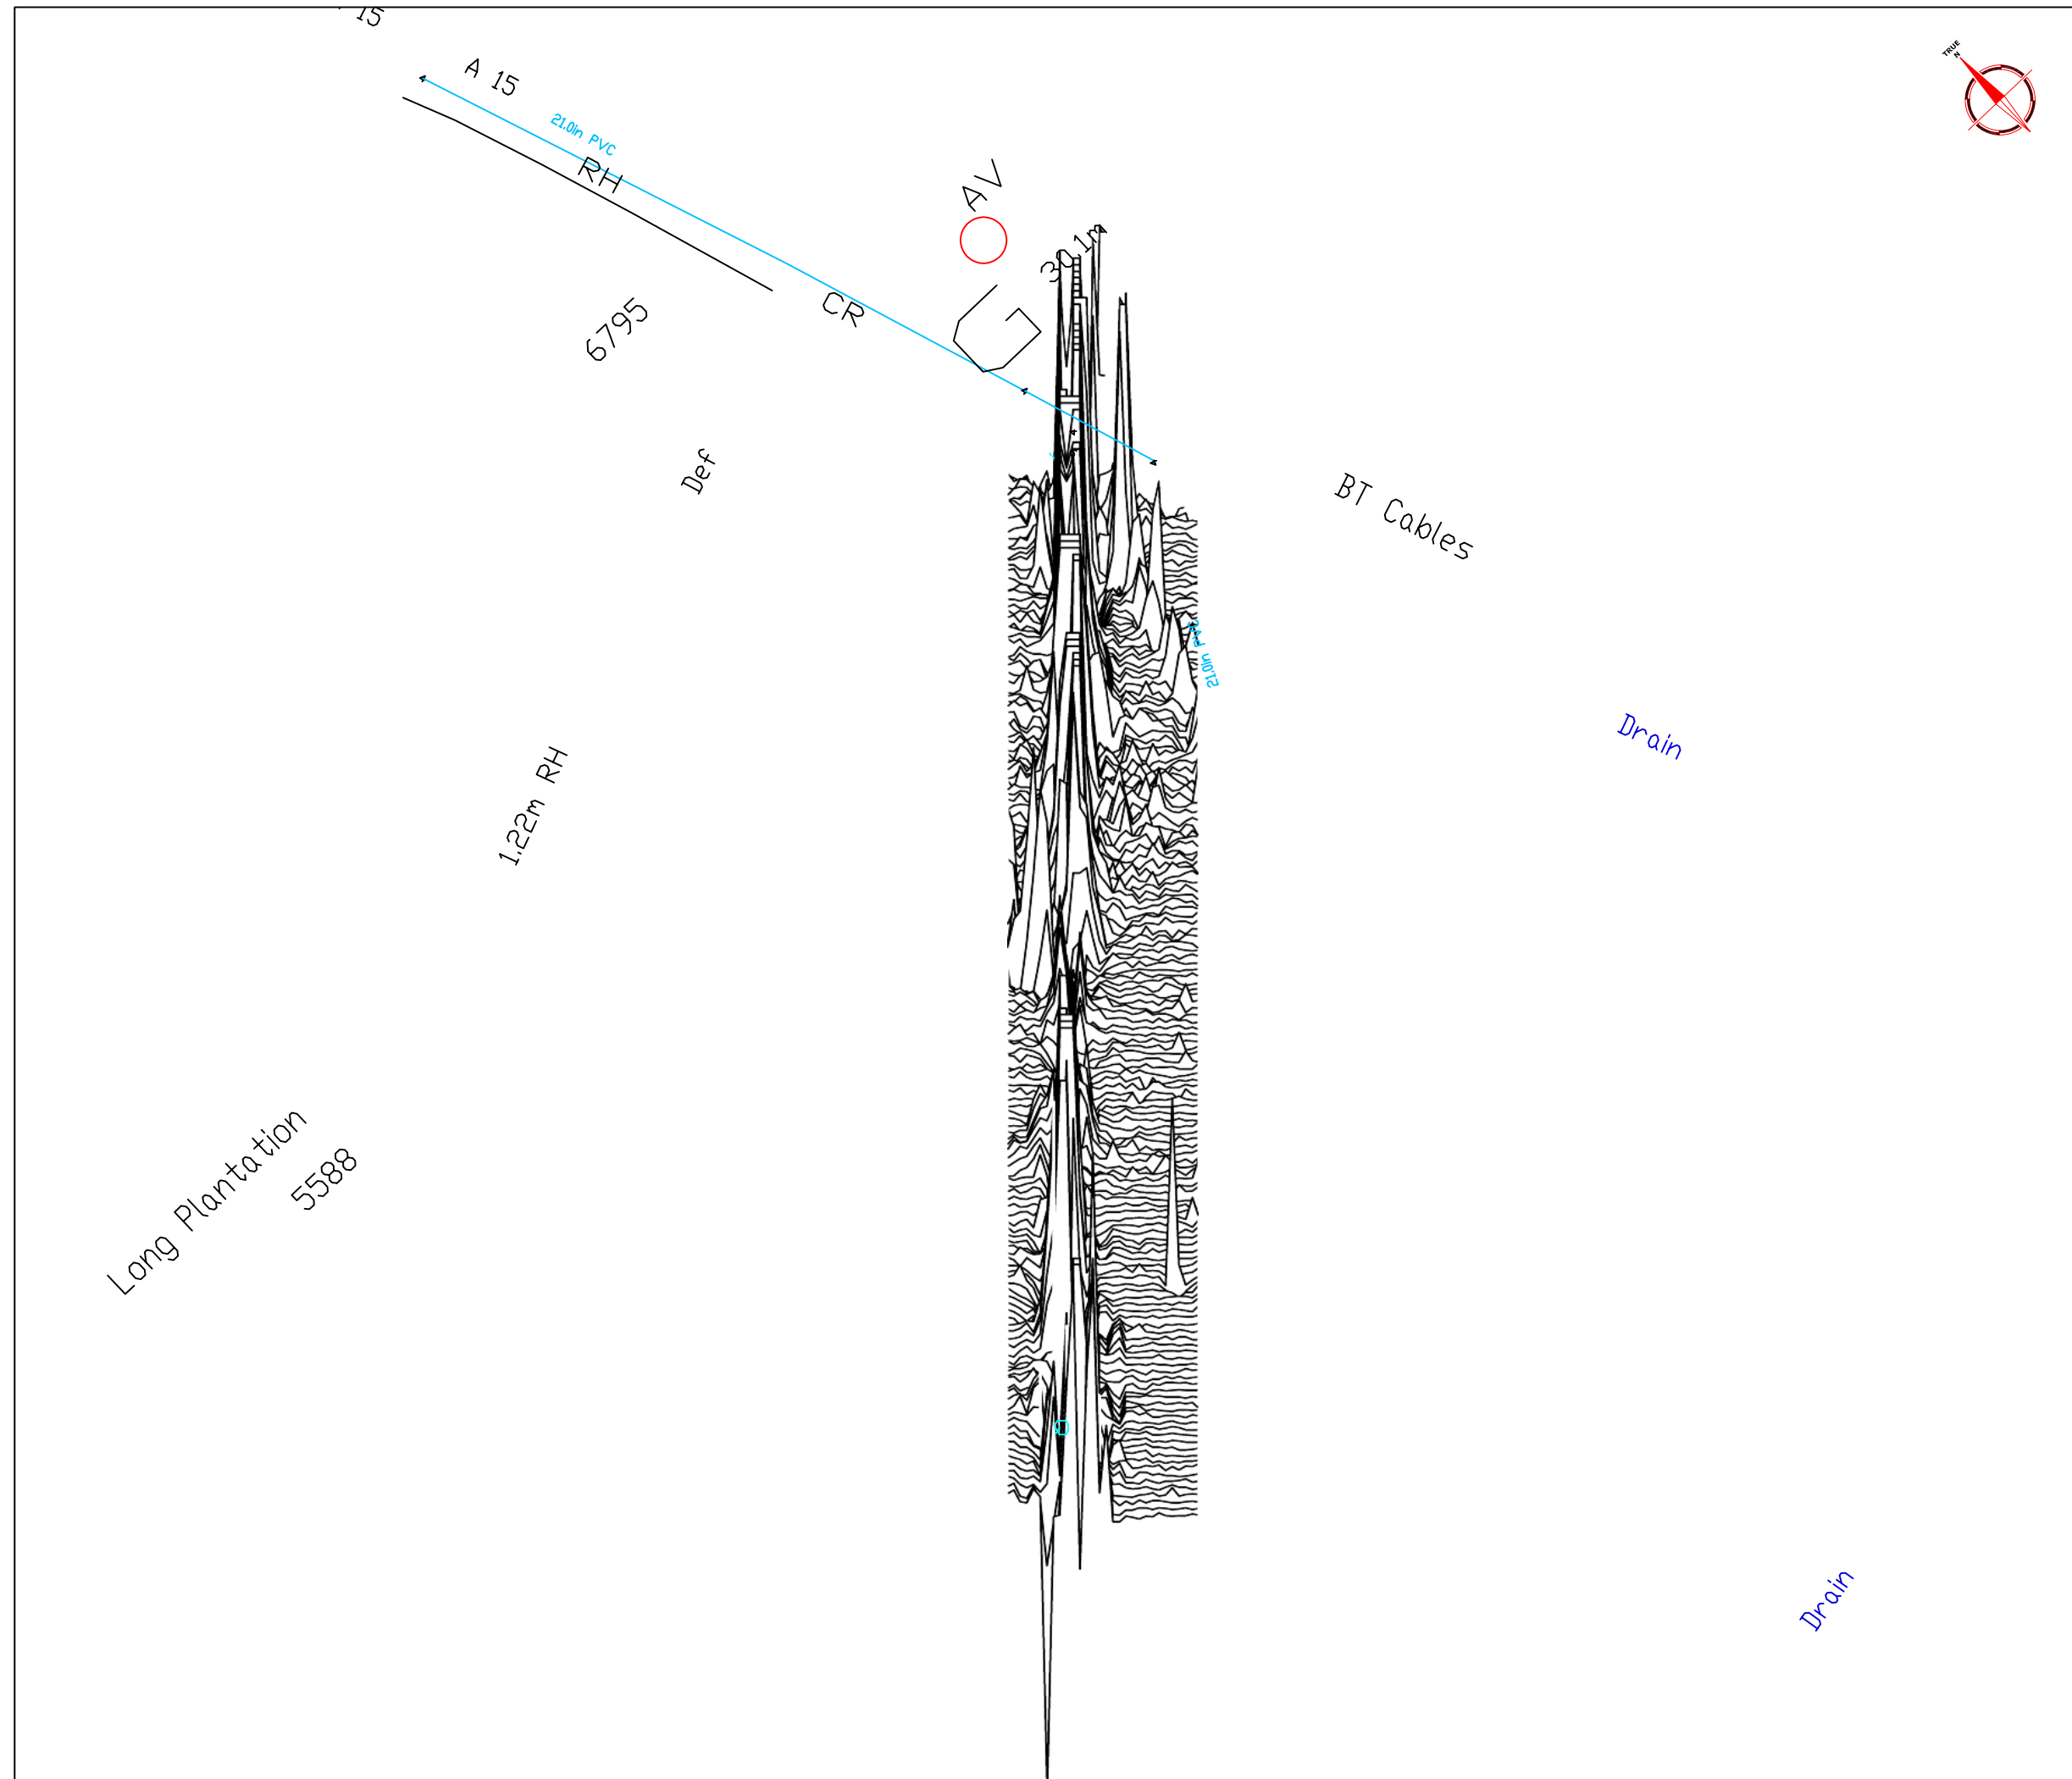

Amendments		
Issue No.	Date	Description
-	-	-
-	-	-

Plotting parameters	200nT
+40nT	160nT
Data clipped at +/- 80nT	120nT
(Positive values displace above the trace line. Hidden values have not been plotted)	80nT
	40nT
	0nT

Client	APS
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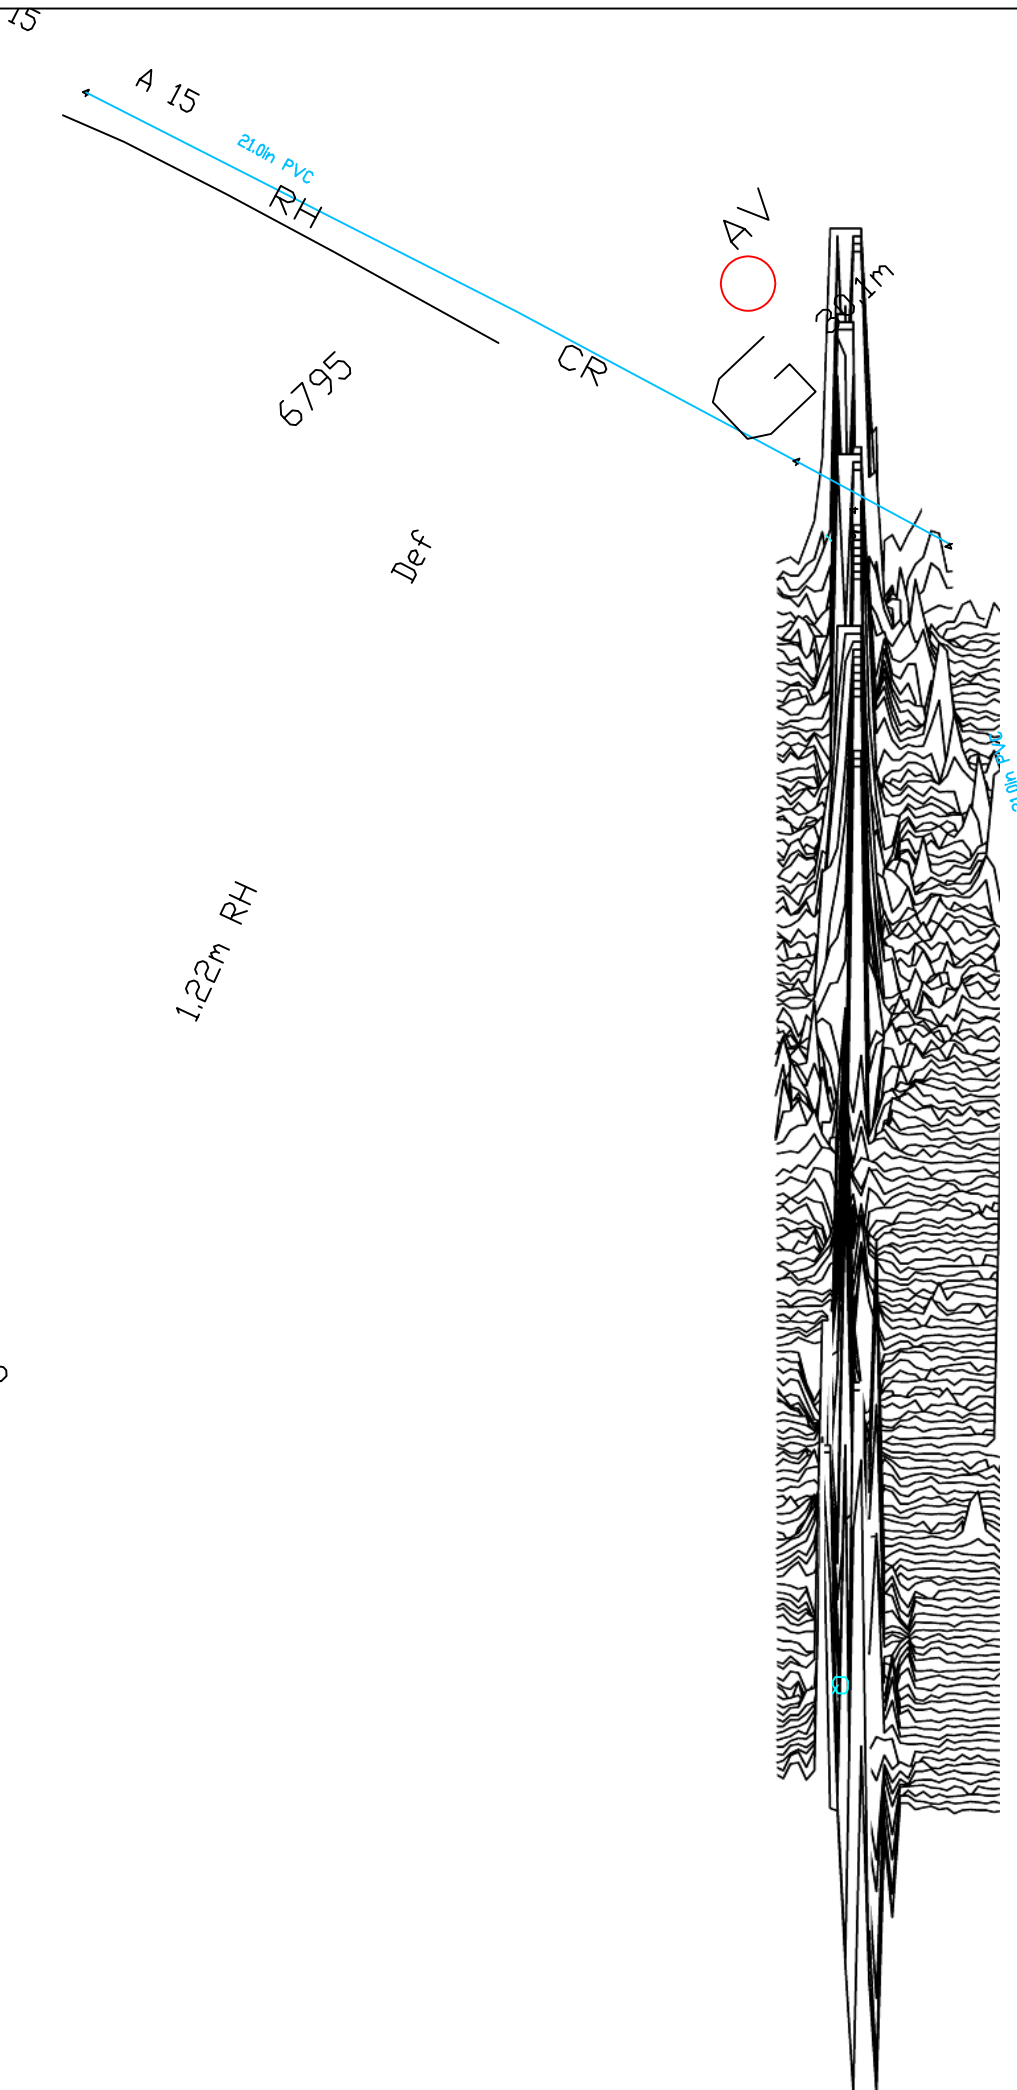
Project Title	Job No.	1998
GEOPHYSICAL SURVEY - HARROWBY-ASWARBY PIPELINE		

Subject	TRACE PLOT OF RAW MAGNETOMETER DATA SHOWING POSITIVE VALUES - AREA 4
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Scale	1:1000	
	0m 10 20 30 40m	

Plot	Checked by	Issue No.
A3	PPB	01
Survey date	Drawn by	Figure No.
APRIL 05	RAJS	23



Long Plantation
5588

Amendments		
Issue No.	Date	Description
-	-	-
-	-	-
-	-	-

Plotting parameters	-200nT
-40nT	-160nT
Data clipped at +/-80nT	-120nT
(Negative values displace above the trace line. Hidden values have not been plotted)	-80nT
	-40nT
	0nT

Client	APS	
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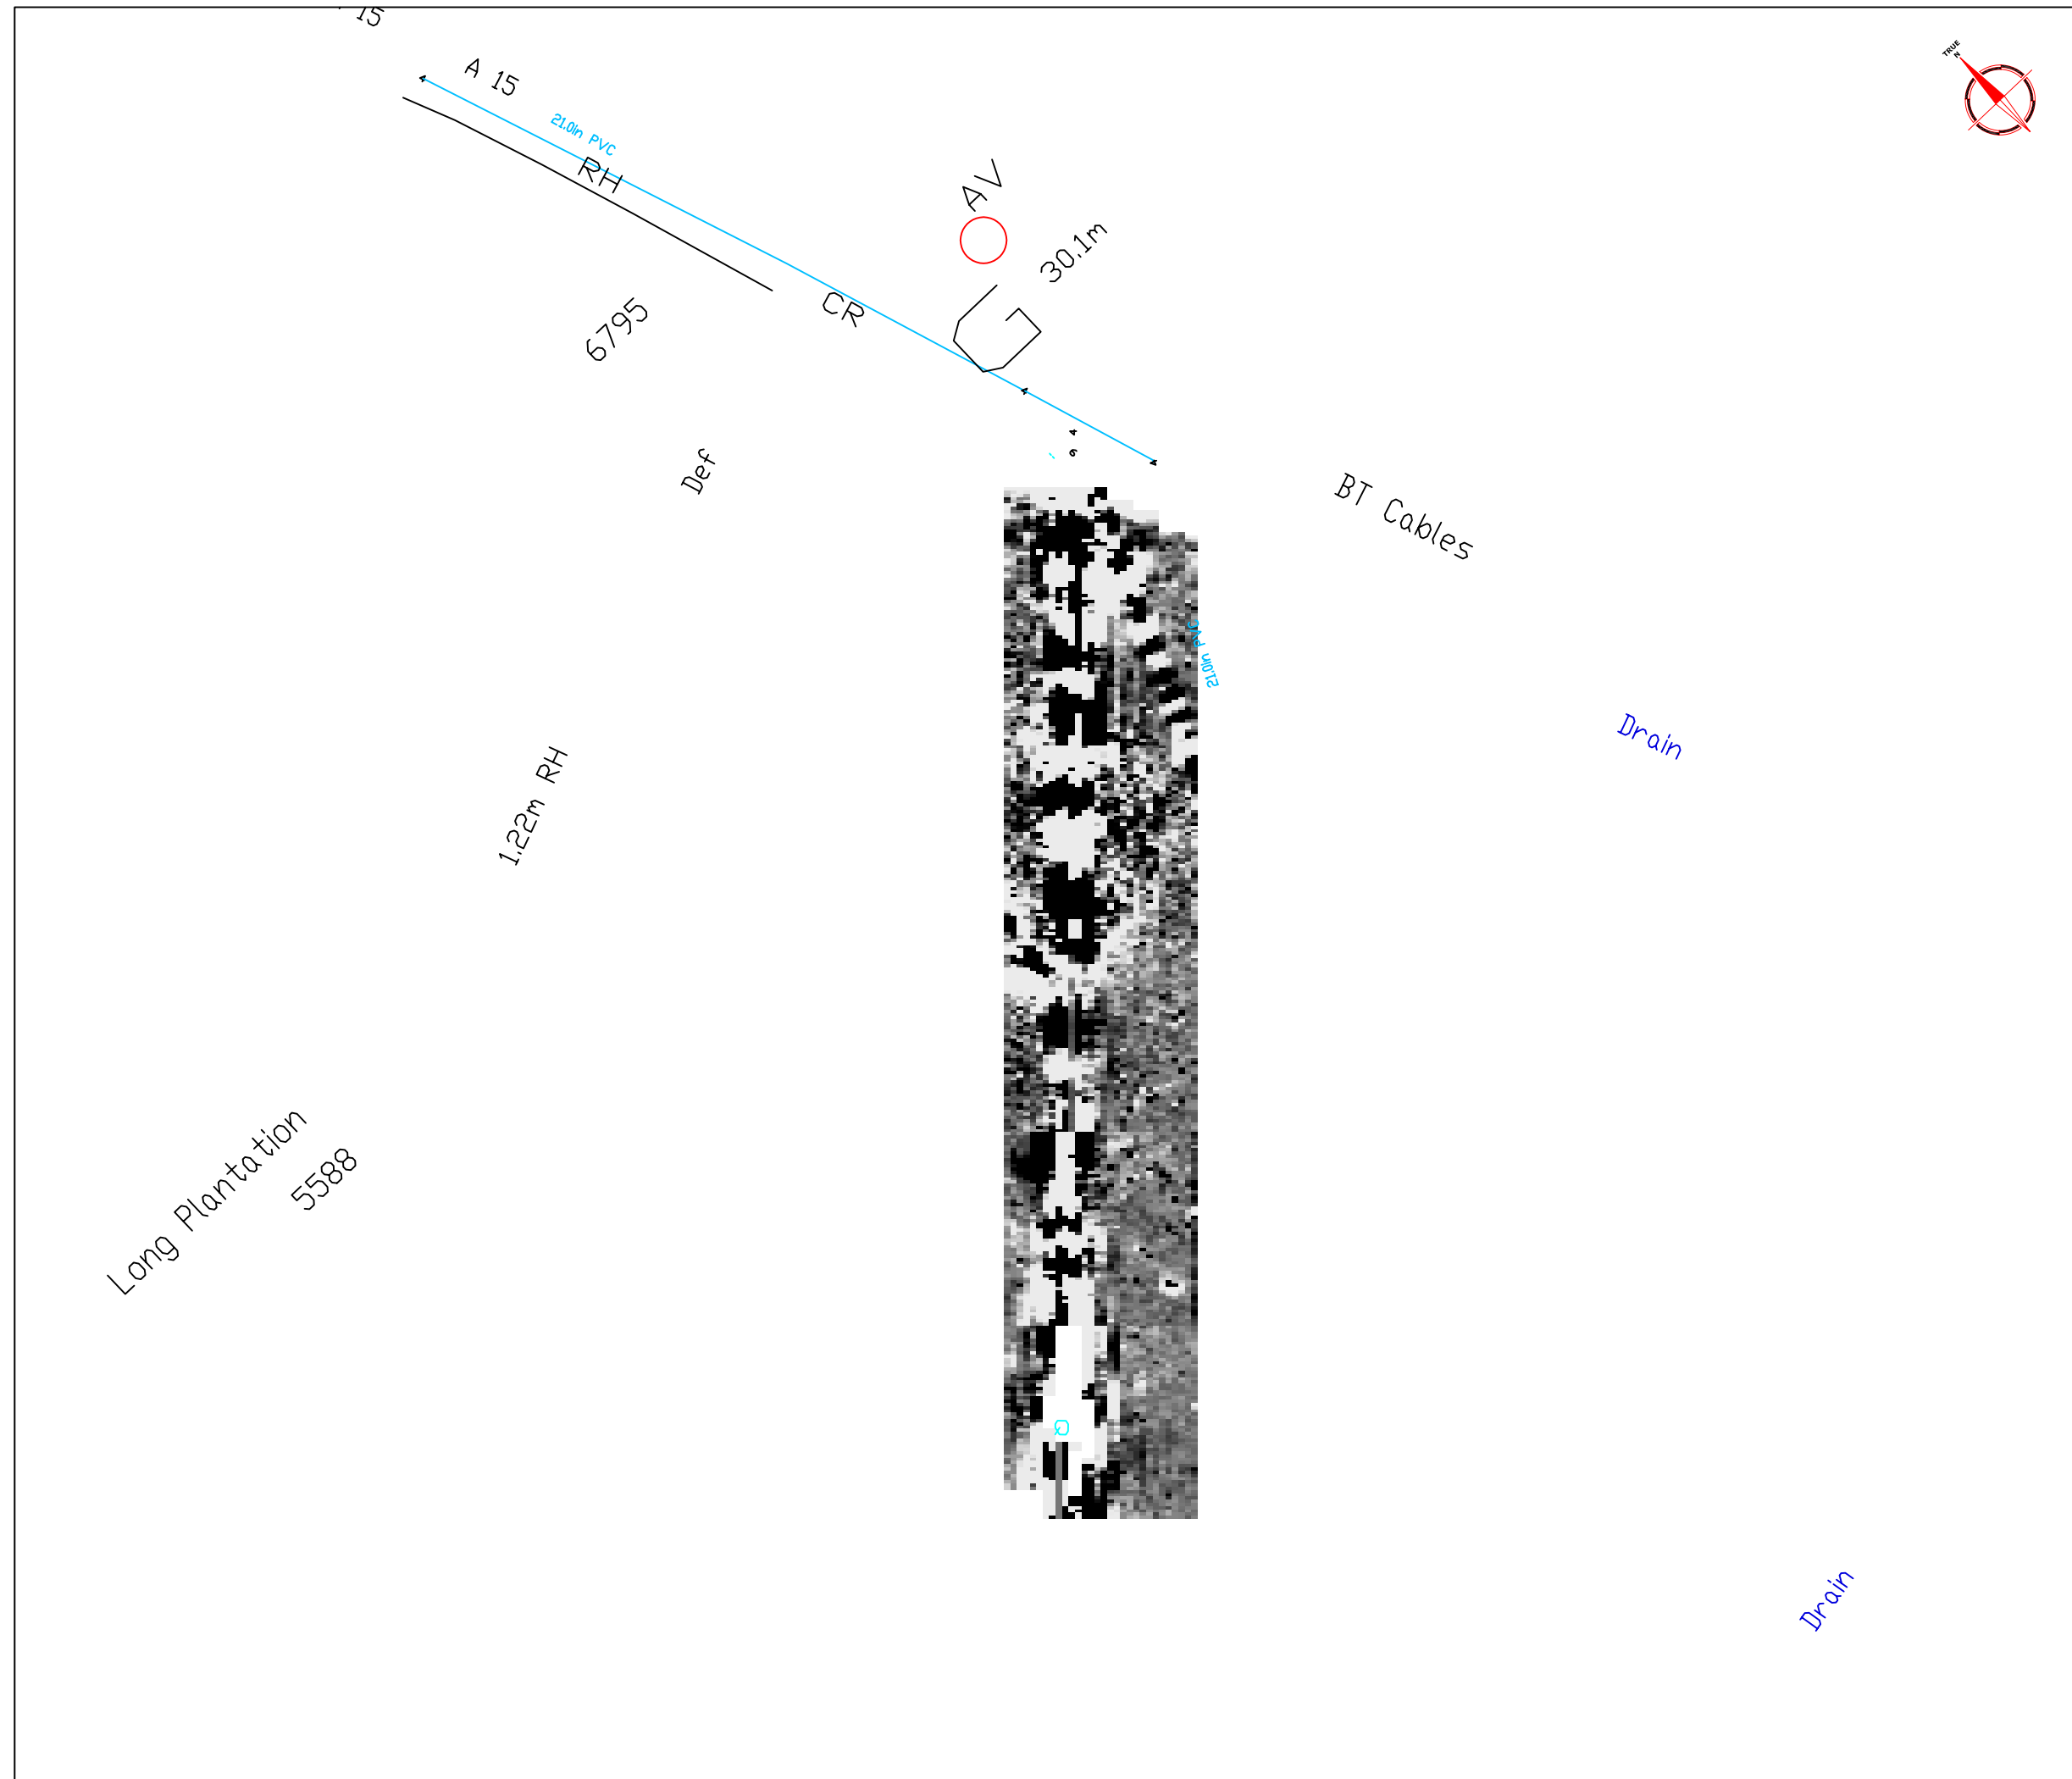
Project Title	Job No.	1998
GEOPHYSICAL SURVEY - HARROWBY-ASWARBY PIPELINE		

Subject	TRACE PLOT OF RAW MAGNETOMETER DATA SHOWING NEGATIVE VALUES - AREA 4	
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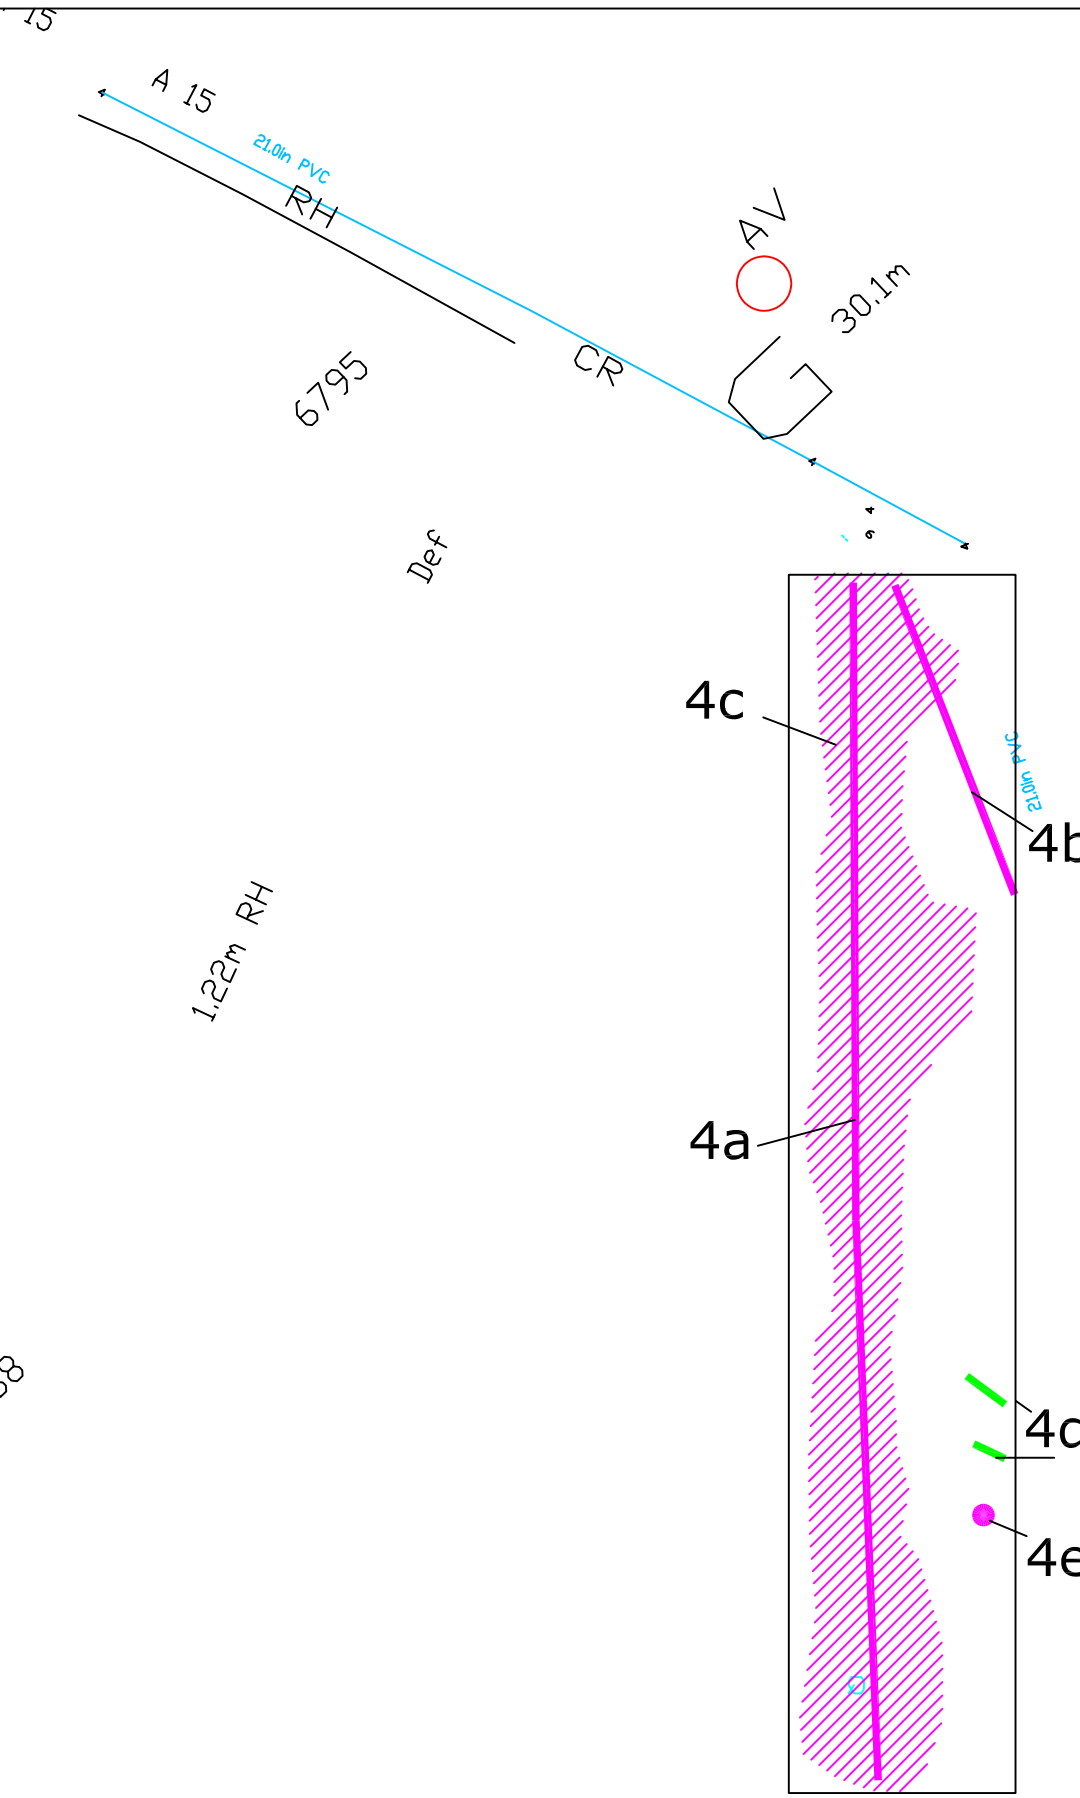
Scale	1:1000	
	0m 10 20 30 40m	

Plot	Checked by	Issue No.
A3	PPB	01
Survey date	Drawn by	Figure No.
APRIL 05	RAJS	24



Amendments		
Issue No.	Date	Description
-	-	-
-	-	-

Plotting parameters		
Maximum +2nT (black) Minimum -2nT (white)		
Client		
APS		
Project Title	Job No.	1998
GEOPHYSICAL SURVEY - HARROWBY-ASWARBY PIPELINE		
Subject		
PLOT OF PROCESSED MAGNETOMETER DATA - AREA 4		
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Scale		
1:1000		
Plot	Checked by	Issue No.
A3	PPB	01
Survey date	Drawn by	Figure No.
APRIL 05	RAJS	25



Amendments		
Issue No.	Date	Description
-	-	-
-	-	-

KEY	
4a	Feature I.D number
	Area of magnetic debris/disturbance
	Pipeline
	Linear anomaly- agricultural mark
	Discrete positive anomaly with negative return- possible ferrous object

Client	APS	
Project Title	Job No. 1998	
	GEOPHYSICAL SURVEY - HARROWBY-ASWARBY PIPELINE	
Subject	ABSTRACTION AND INTERPRETATION OF MAGNETOMETER ANOMALIES - AREA 4	

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Scale	1:1000	
Plot	Checked by	Issue No.
A3	PPB	01
Survey date	Drawn by	Figure No.
APRIL 05	RAJS	26

Long Plantation
5588

1.22m RH

6795

Def

CR

30.1m

BT Cables

Drain

Drain

4c

4b

4a

4d

4e

15

A 15

21.0m PVC

RH

AV

9

21.0m PVC

