


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 WR8 0SA
 OS 100km square = SP





85
84
83
82
81

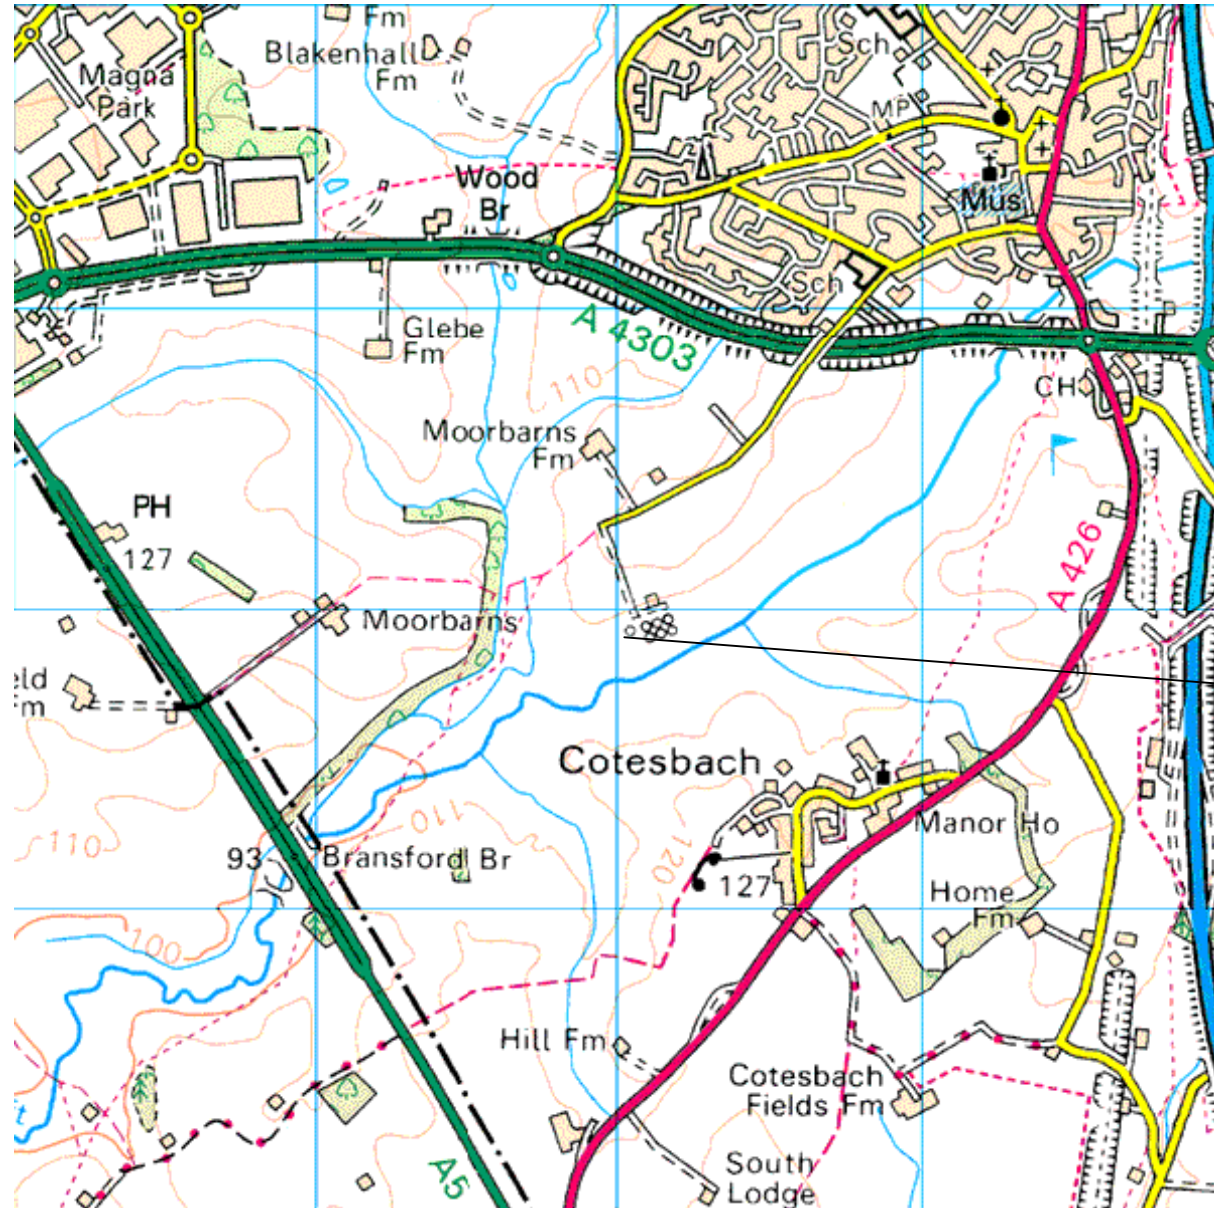

SURVEY AREA

51 52 53 54 55

Amendments		
Issue No.	Date	Description
-	-	-
Site centred on NGR		SP 531 829
Client		ULAS
Project Title	Job No.	2036
GEOPHYSICAL SURVEY - LUTTERWORTH STW		
Subject		LOCATION PLAN OF SURVEY AREA
Scale 1:25 000		
Plot	Checked by	Issue No.
A3	SAS	01
Survey date	Drawn by	Figure No.
JULY 05	DGE	01

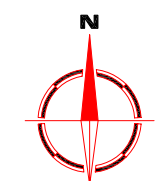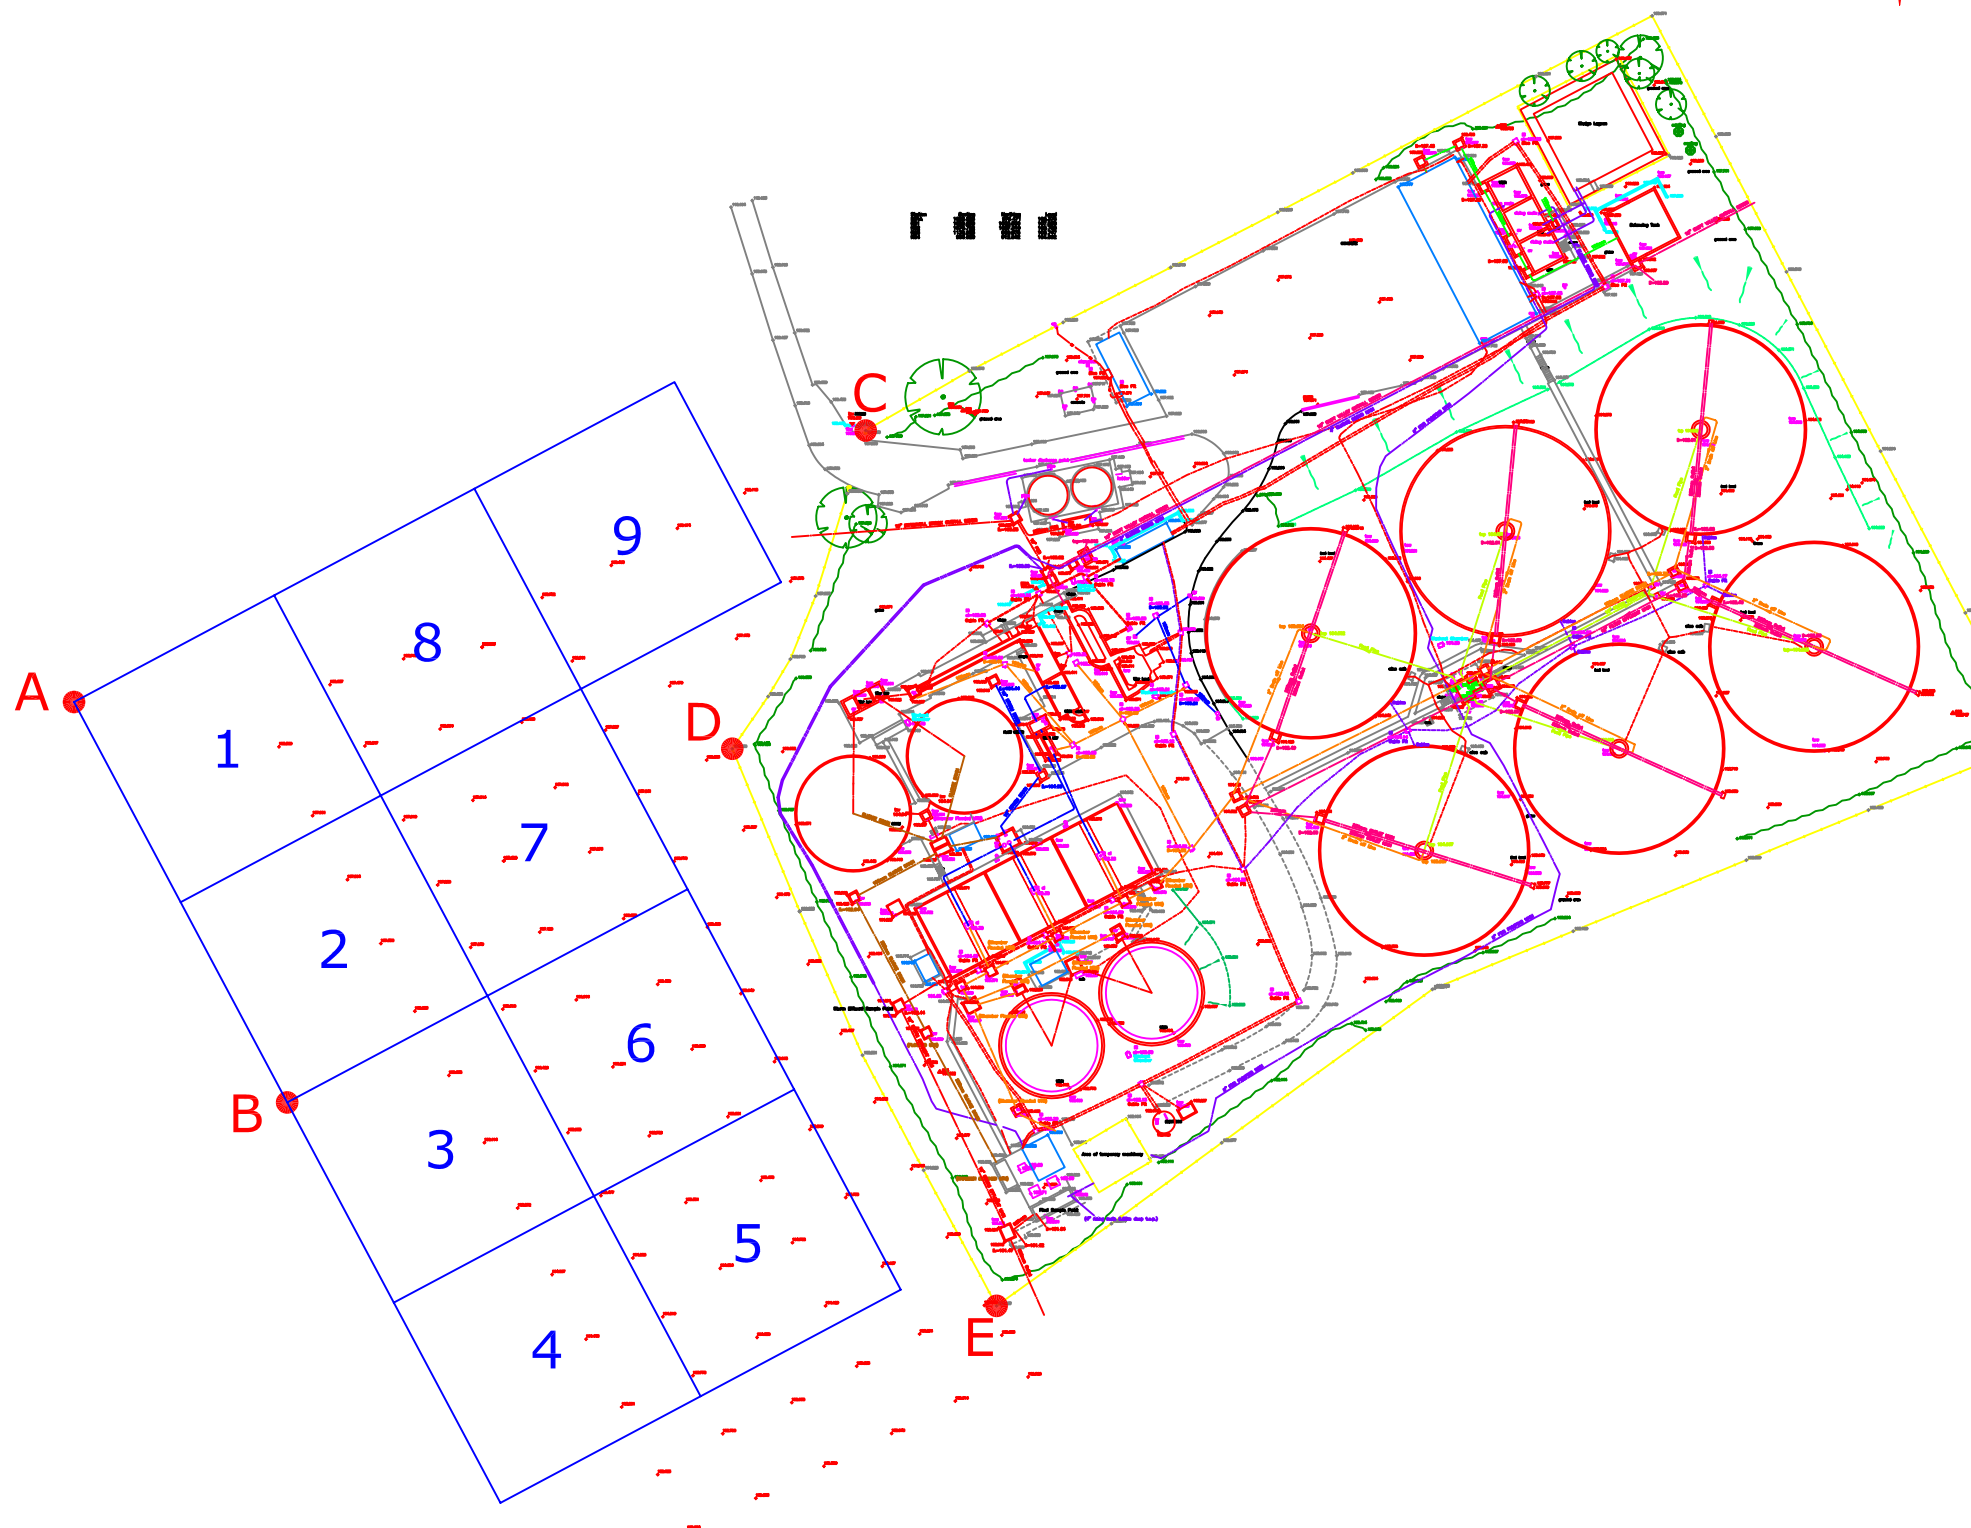

Amendments		
Issue No.	Date	Description
-	-	-
-	-	-

REFERENCING INFORMATION					
A-B	60m	A-C	110.84m	A-D	87.43m
A-E	145.98m	B-C	117.36m	B-D	75.20m
B-E	97.73m				
A-B	Base line				
C, D, E	Referencing points				
2	Grid number				

Client
ULAS

Project Title
GEOPHYSICAL SURVEY - LUTTERWORTH STW


Job No. 2036

Subject
SITE PLAN SHOWING LOCATION OF SURVEY GRIDS AND REFERENCING



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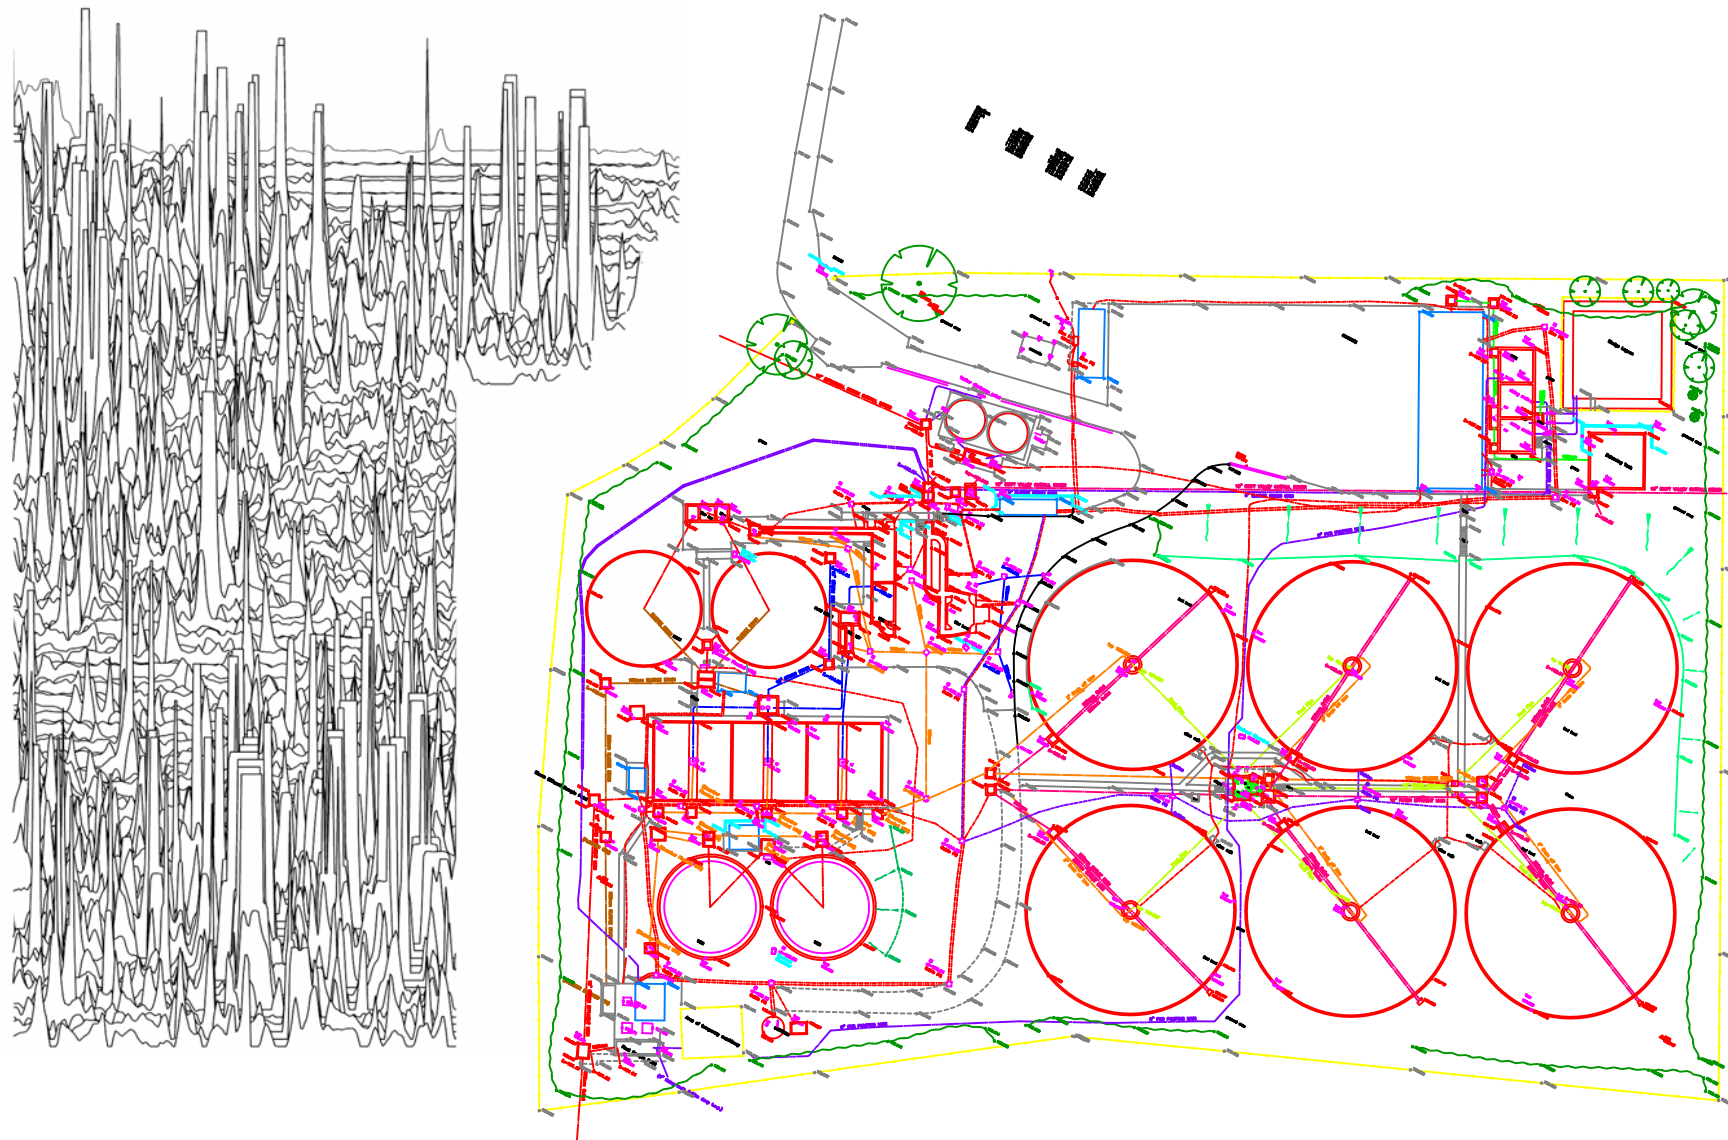
Scale
1:1000



Plot A3	Checked by SAS	Issue No. 01
Survey date JULY 05	Drawn by DGE	Figure No. 02

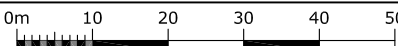

Amendments		
Issue No.	Date	Description
-	-	-
Plotting parameters		
Maximum +10nT (black)		+10nT
Minimum -10nT (white)		
-3SD		-10nT
+3SD		
Client		
ULAS		
Project Title		Job No. 2036
GEOPHYSICAL SURVEY - LUTTERWORTH STW		
Subject		
PLOT OF RAW GRADIOMETER DATA		
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www.stratascan.co.uk		
Scale		
1:500		
0m 5 10 15 20 25m		
Plot	Checked by	Issue No.
A3	SAS	01
Survey date	Drawn by	Figure No.
JULY 05	DGE	03

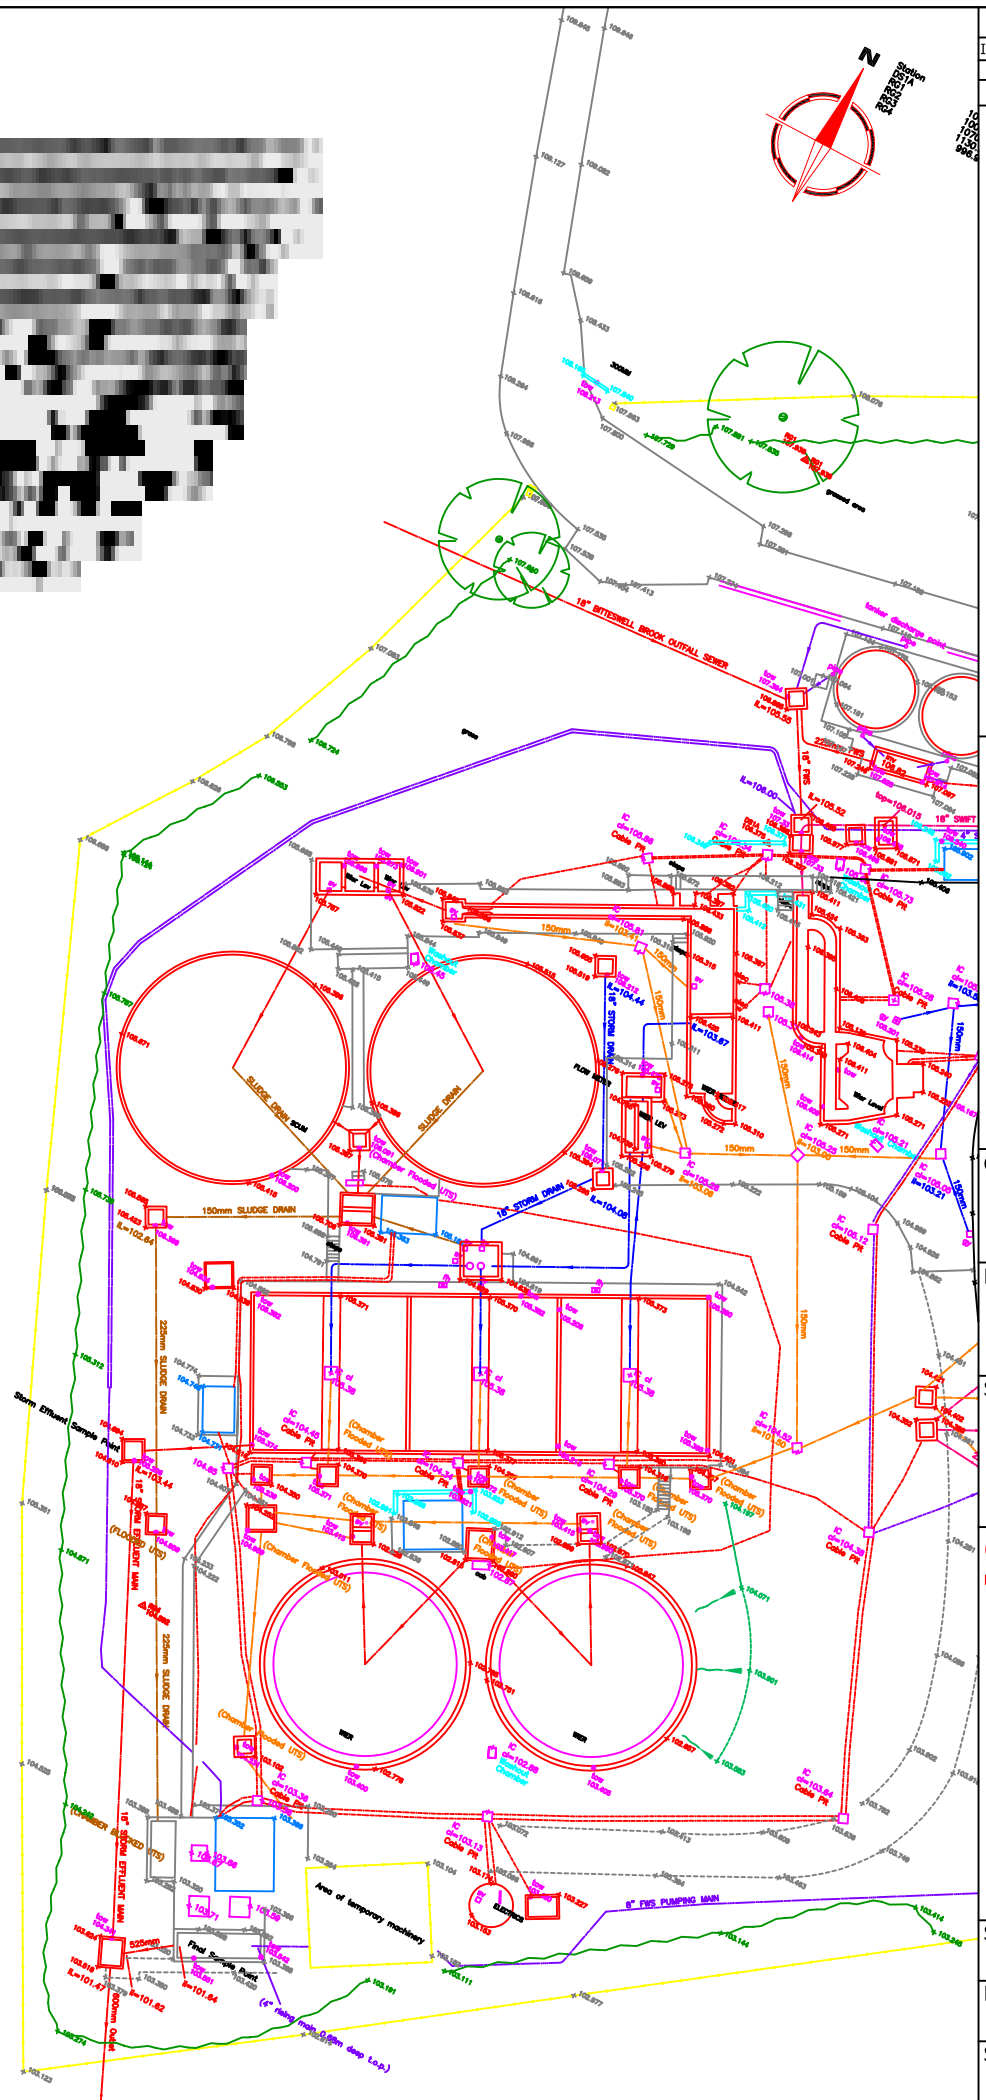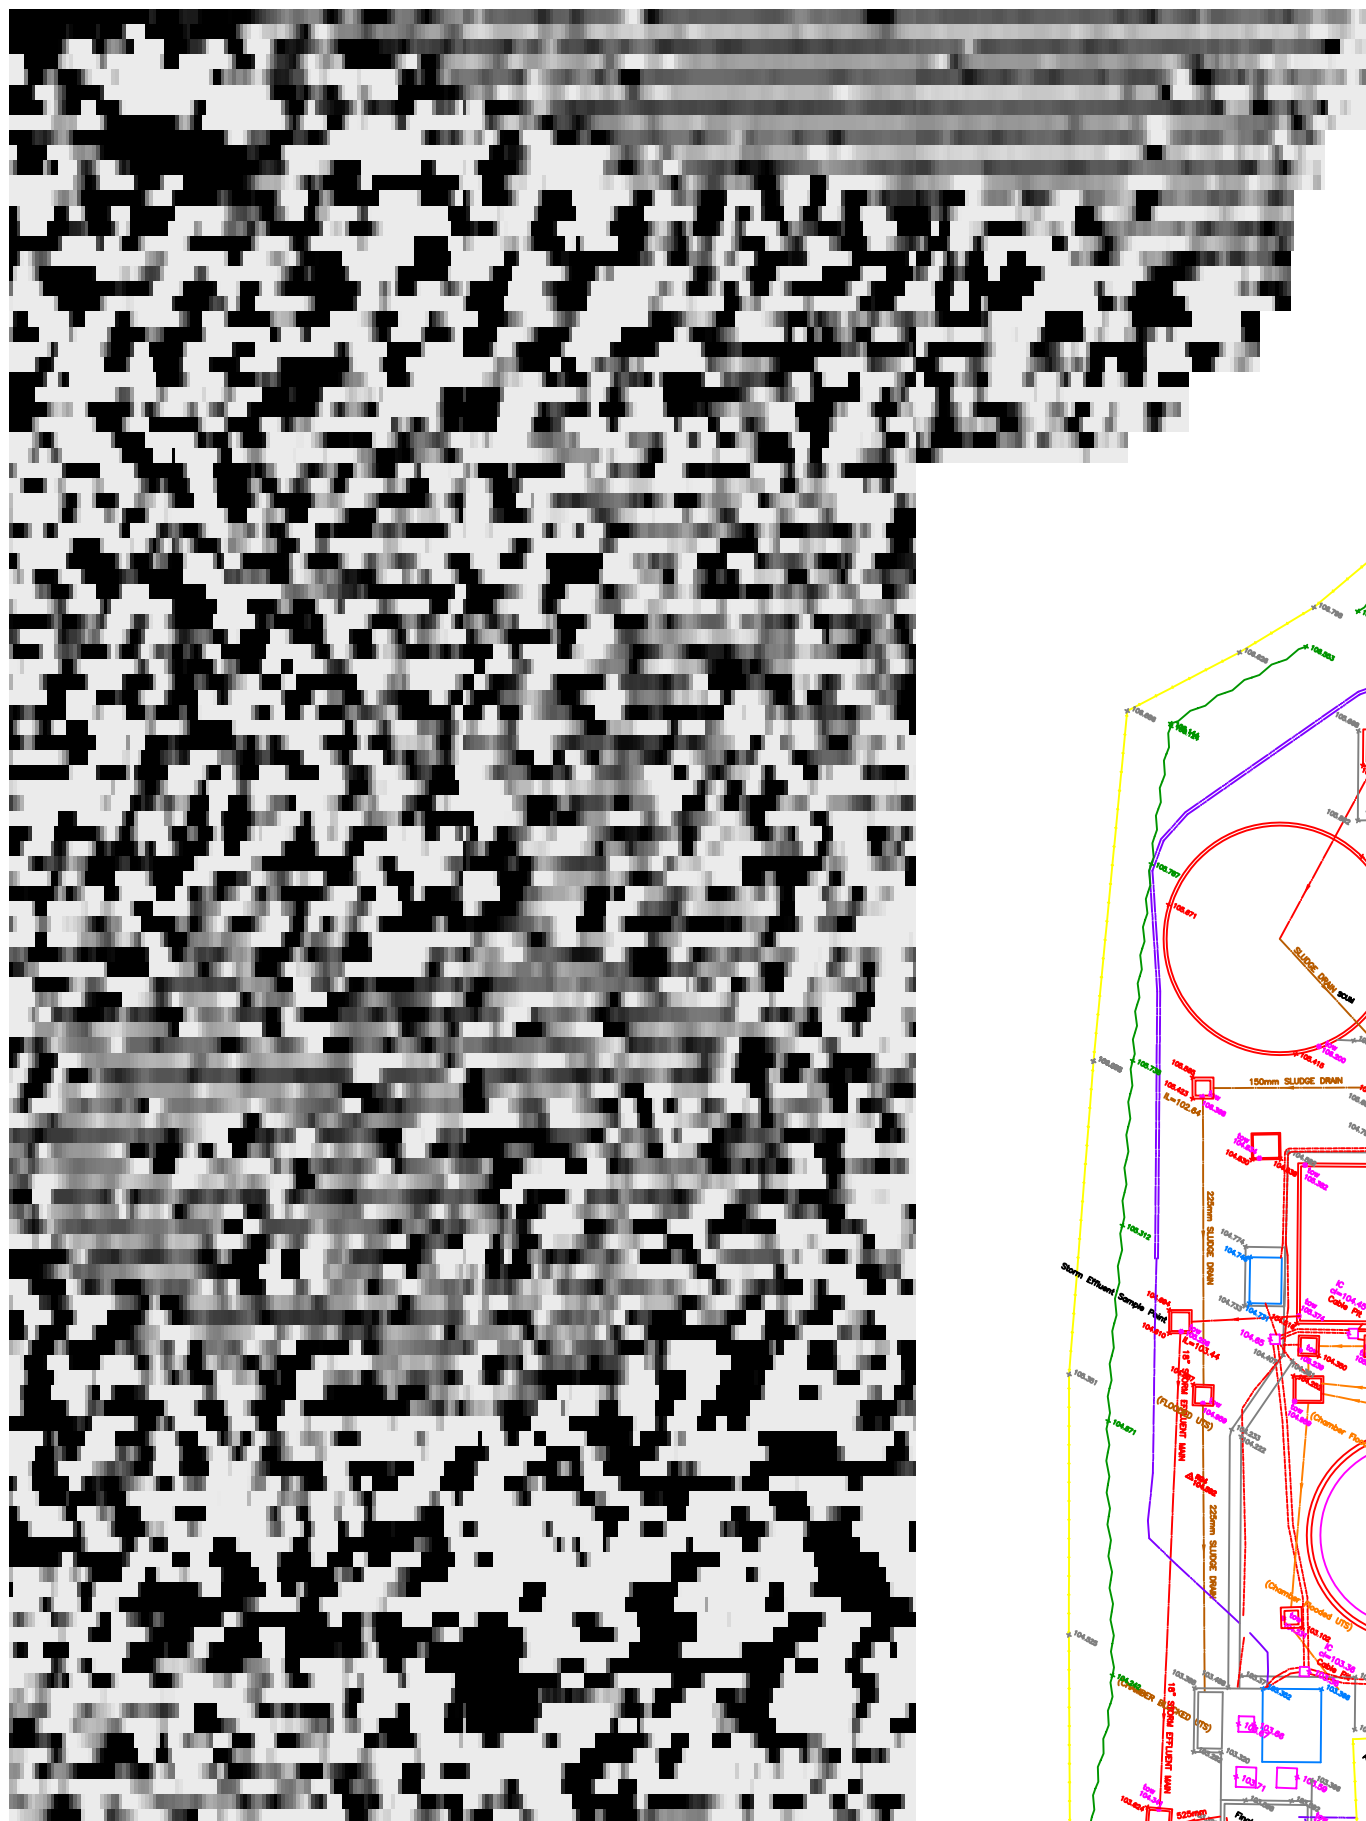

Amendments		
Issue No.	Date	Description
-	-	-
-	-	-

Plotting parameters +100nT <i>(Positive values displace above the trace line. Hidden values have not been plotted)</i>	
--	--

Client
ULAS

Project Title **GEOPHYSICAL SURVEY -LUTTERWORTH STW** Job No. 2036


Subject
TRACE PLOT OF RAW GRADIOMETER DATA SHOWING POSITIVE VALUES

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Scale **1:1000**

Plot A3	Checked by SAS	Issue No. 01
Survey date JULY 05	Drawn by DGE	Figure No. 04



Amendments		
Issue No.	Date	Description
-	-	-
-	-	-

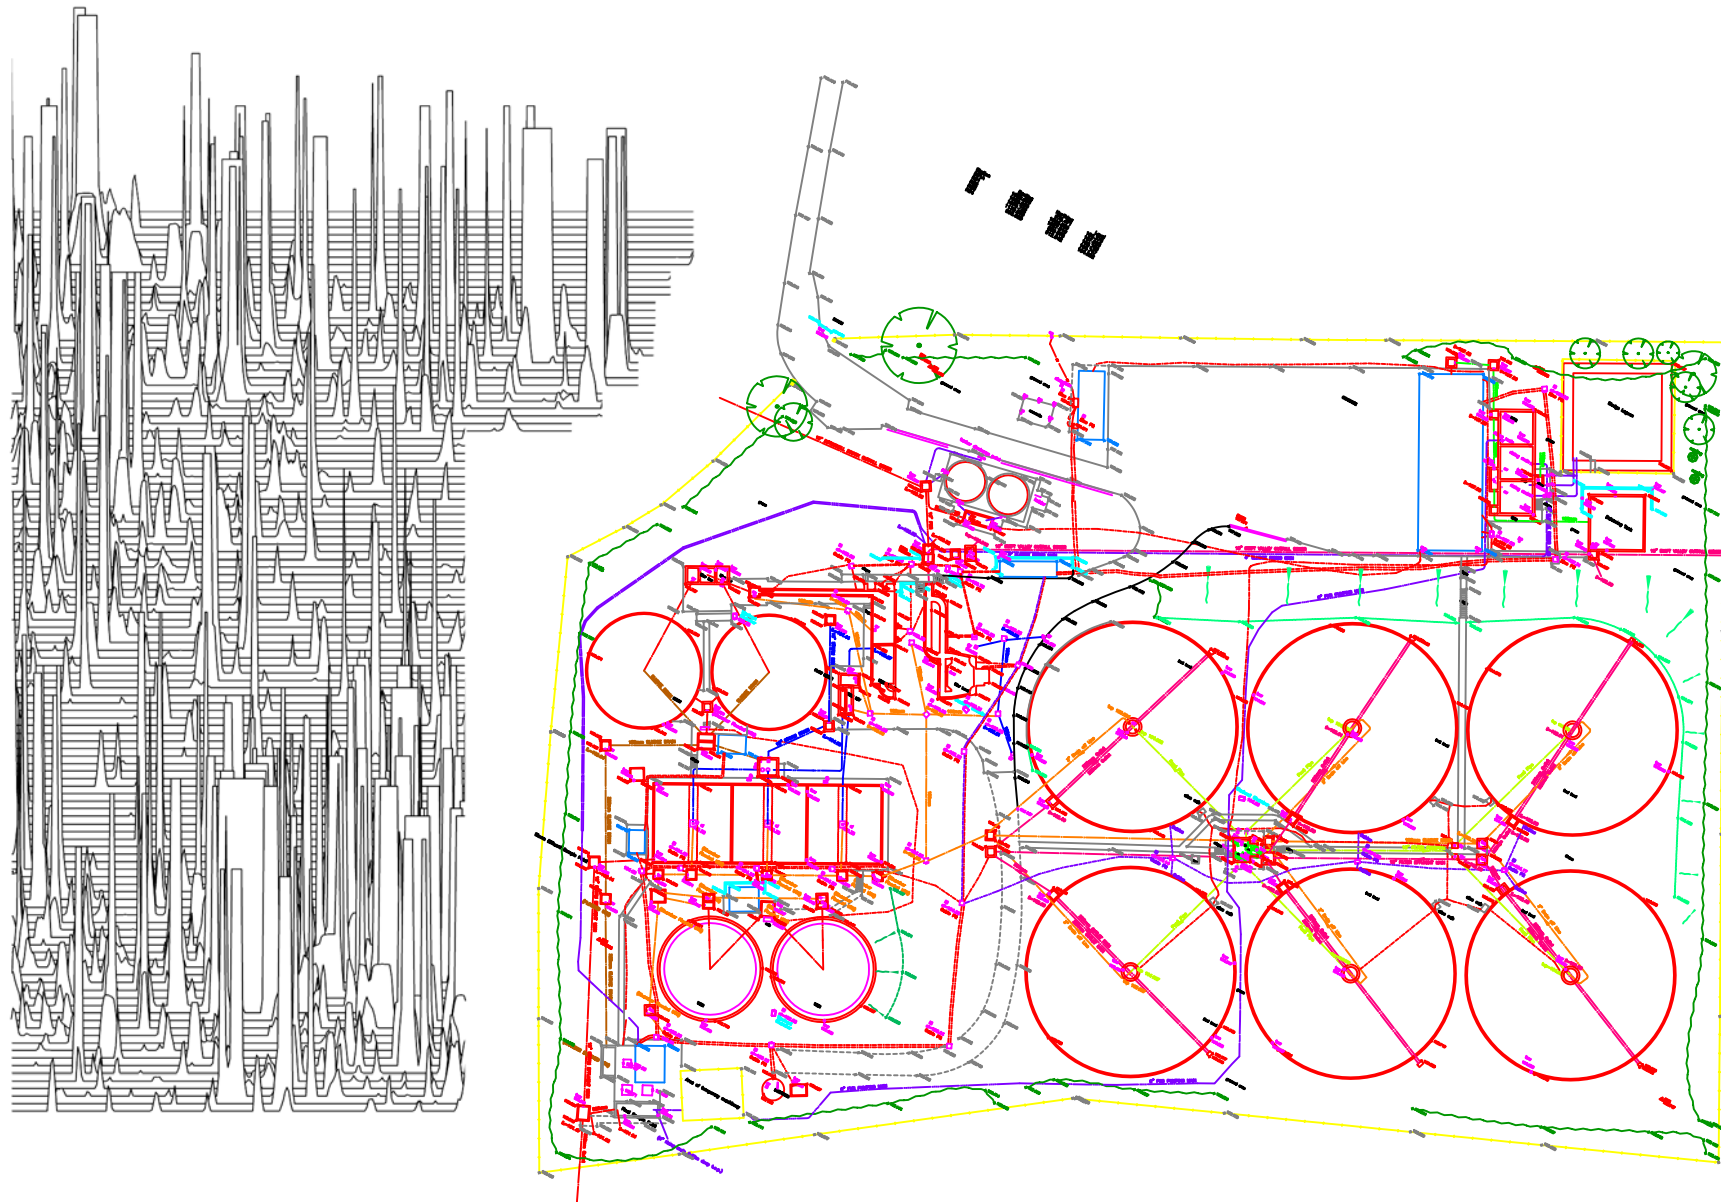Plotting parameters	
-100nT <i>(Negative values displace above the trace line. Hidden values have not been plotted)</i>	

Client
ULAS

Project Title **GEOPHYSICAL SURVEY - LUTTERWORTH STW** Job No. 2036



Subject
TRACE PLOT OF RAW GRADIOMETER DATA SHOWING NEGATIVE VALUES

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


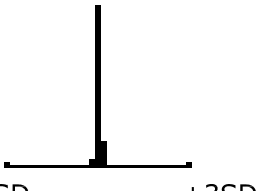
Scale 1:1000

Plot A3	Checked by SAS	Issue No. 01
Survey date JULY 05	Drawn by DGE	Figure No. 05

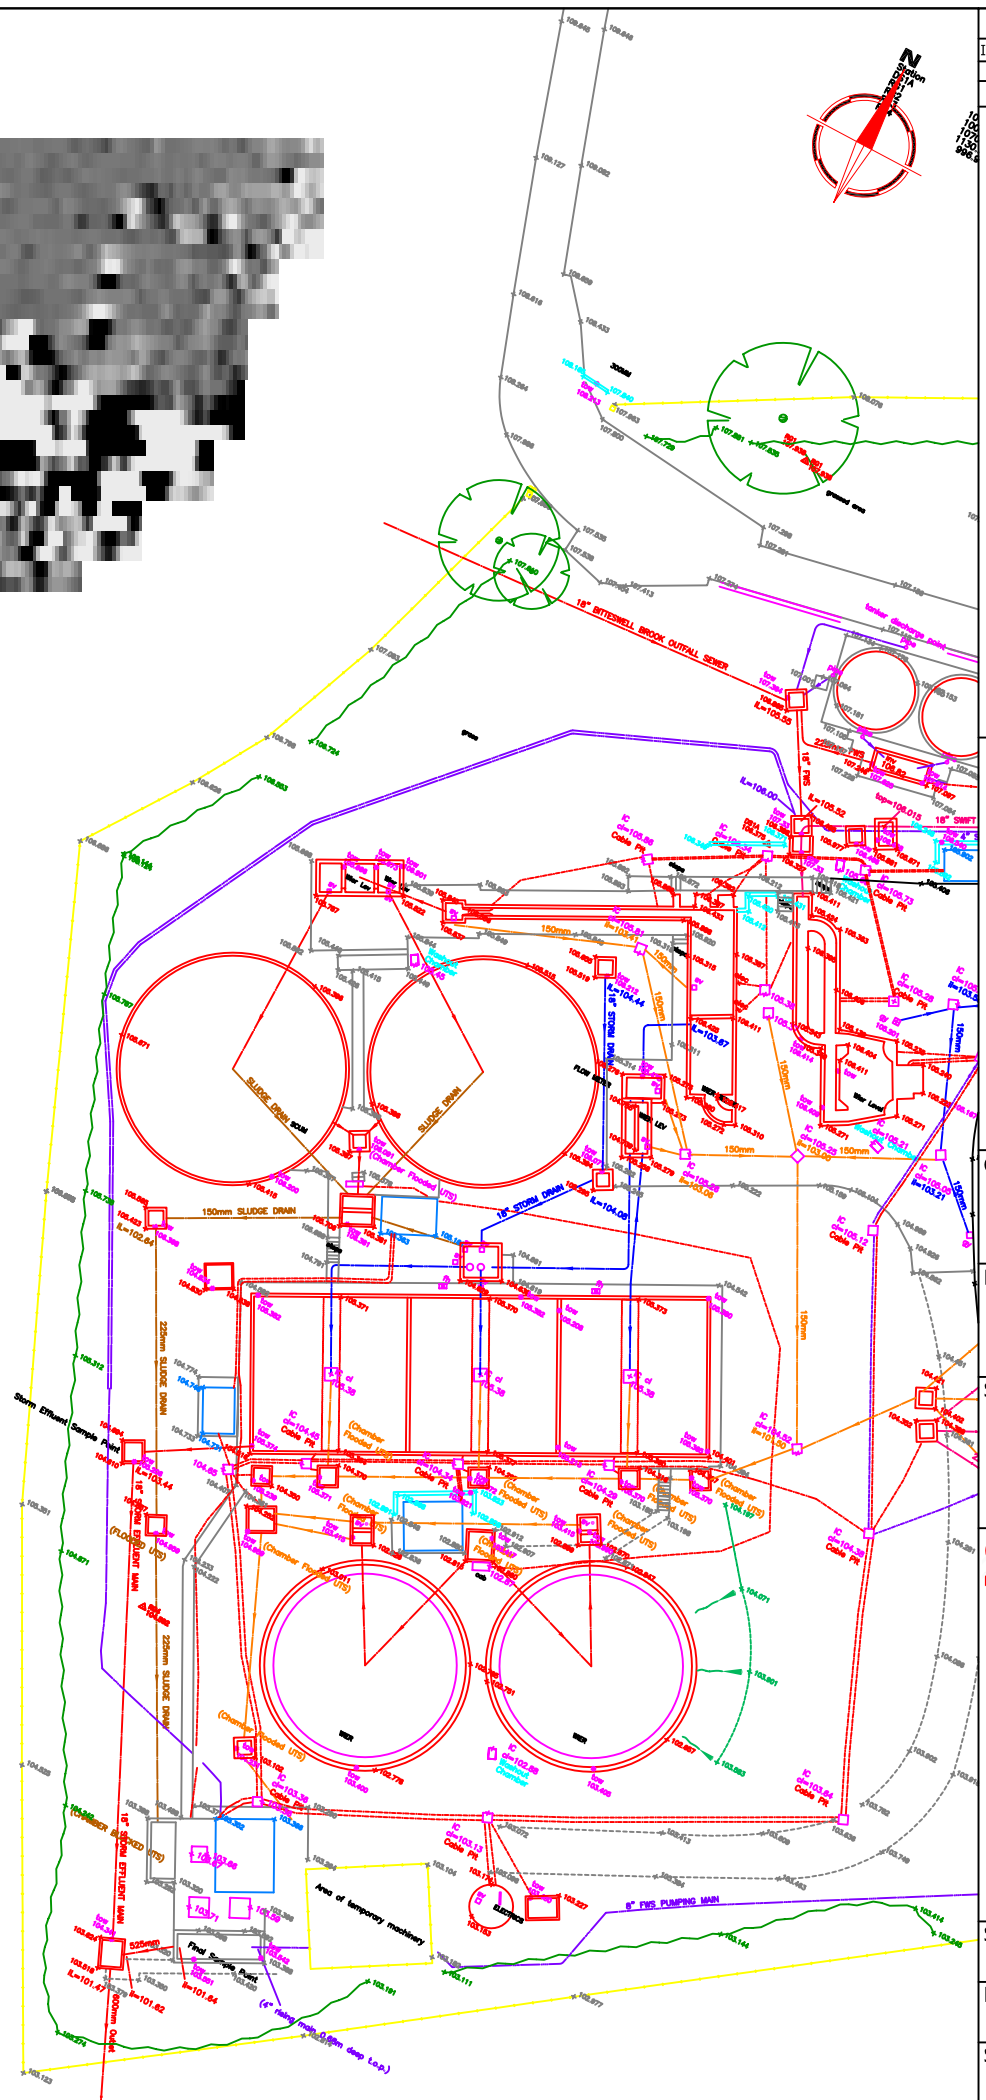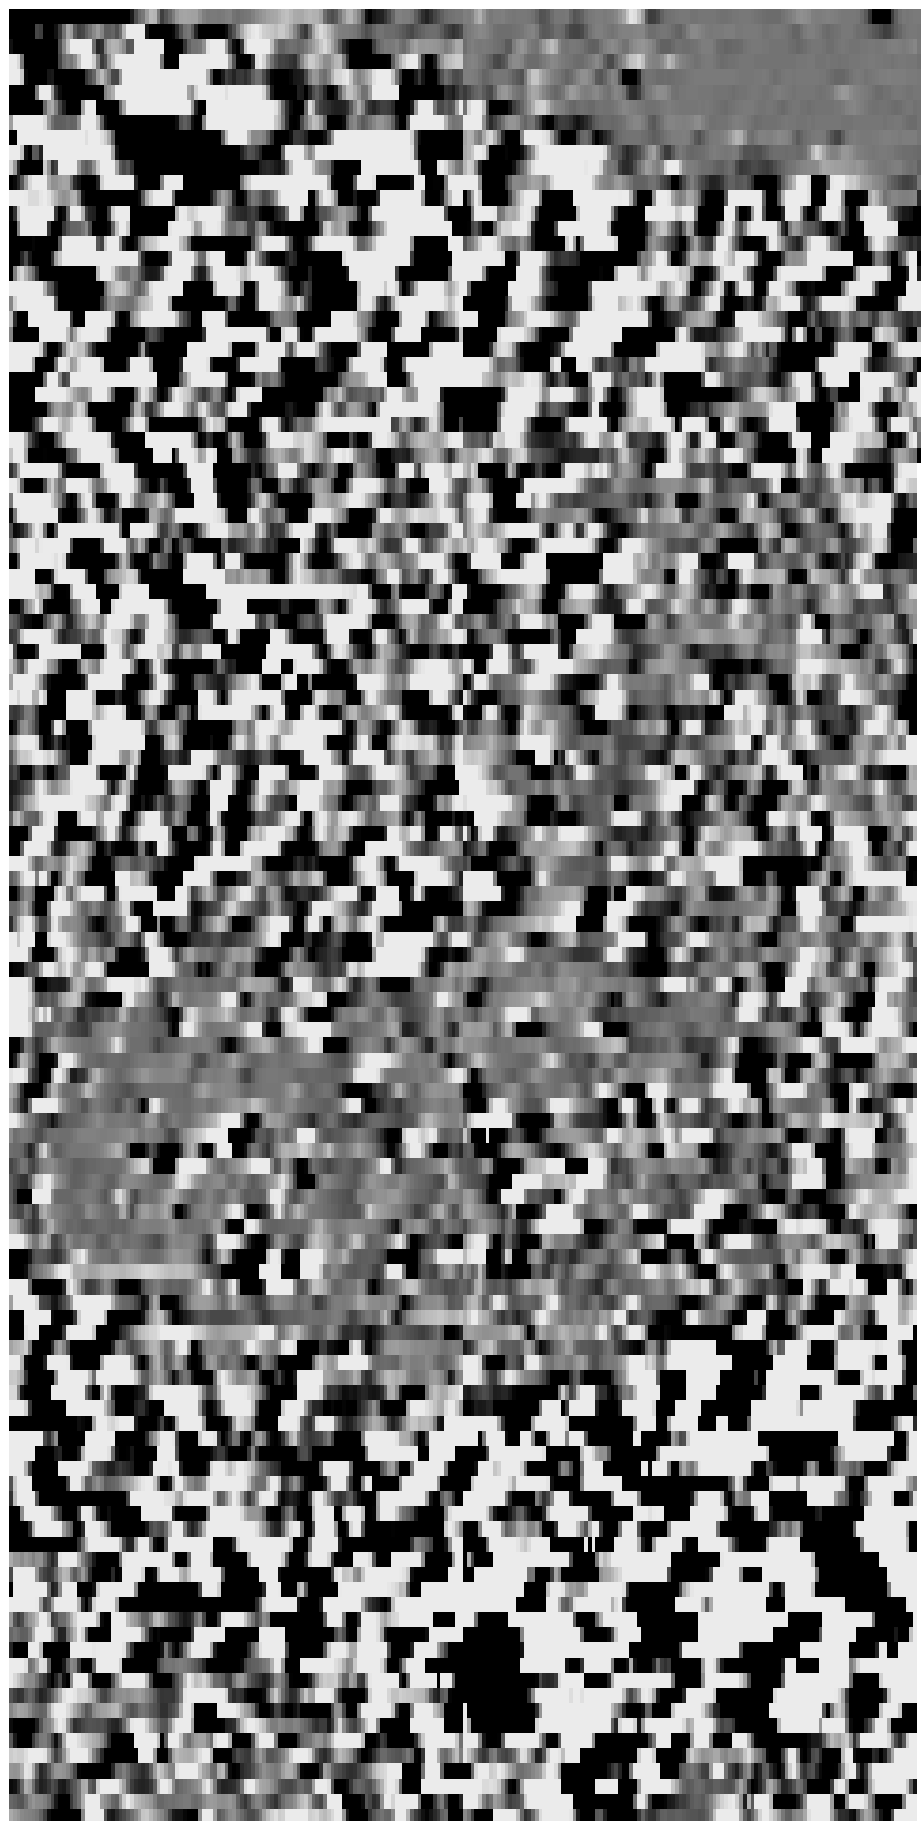

Amendments		
Issue No.	Date	Description
-	-	-
-	-	-


Plotting parameters	
Maximum +15nT (black) Minimum -15nT (white)	


	-3SD	0	+3SD
--	------	---	------

Client	ULAS
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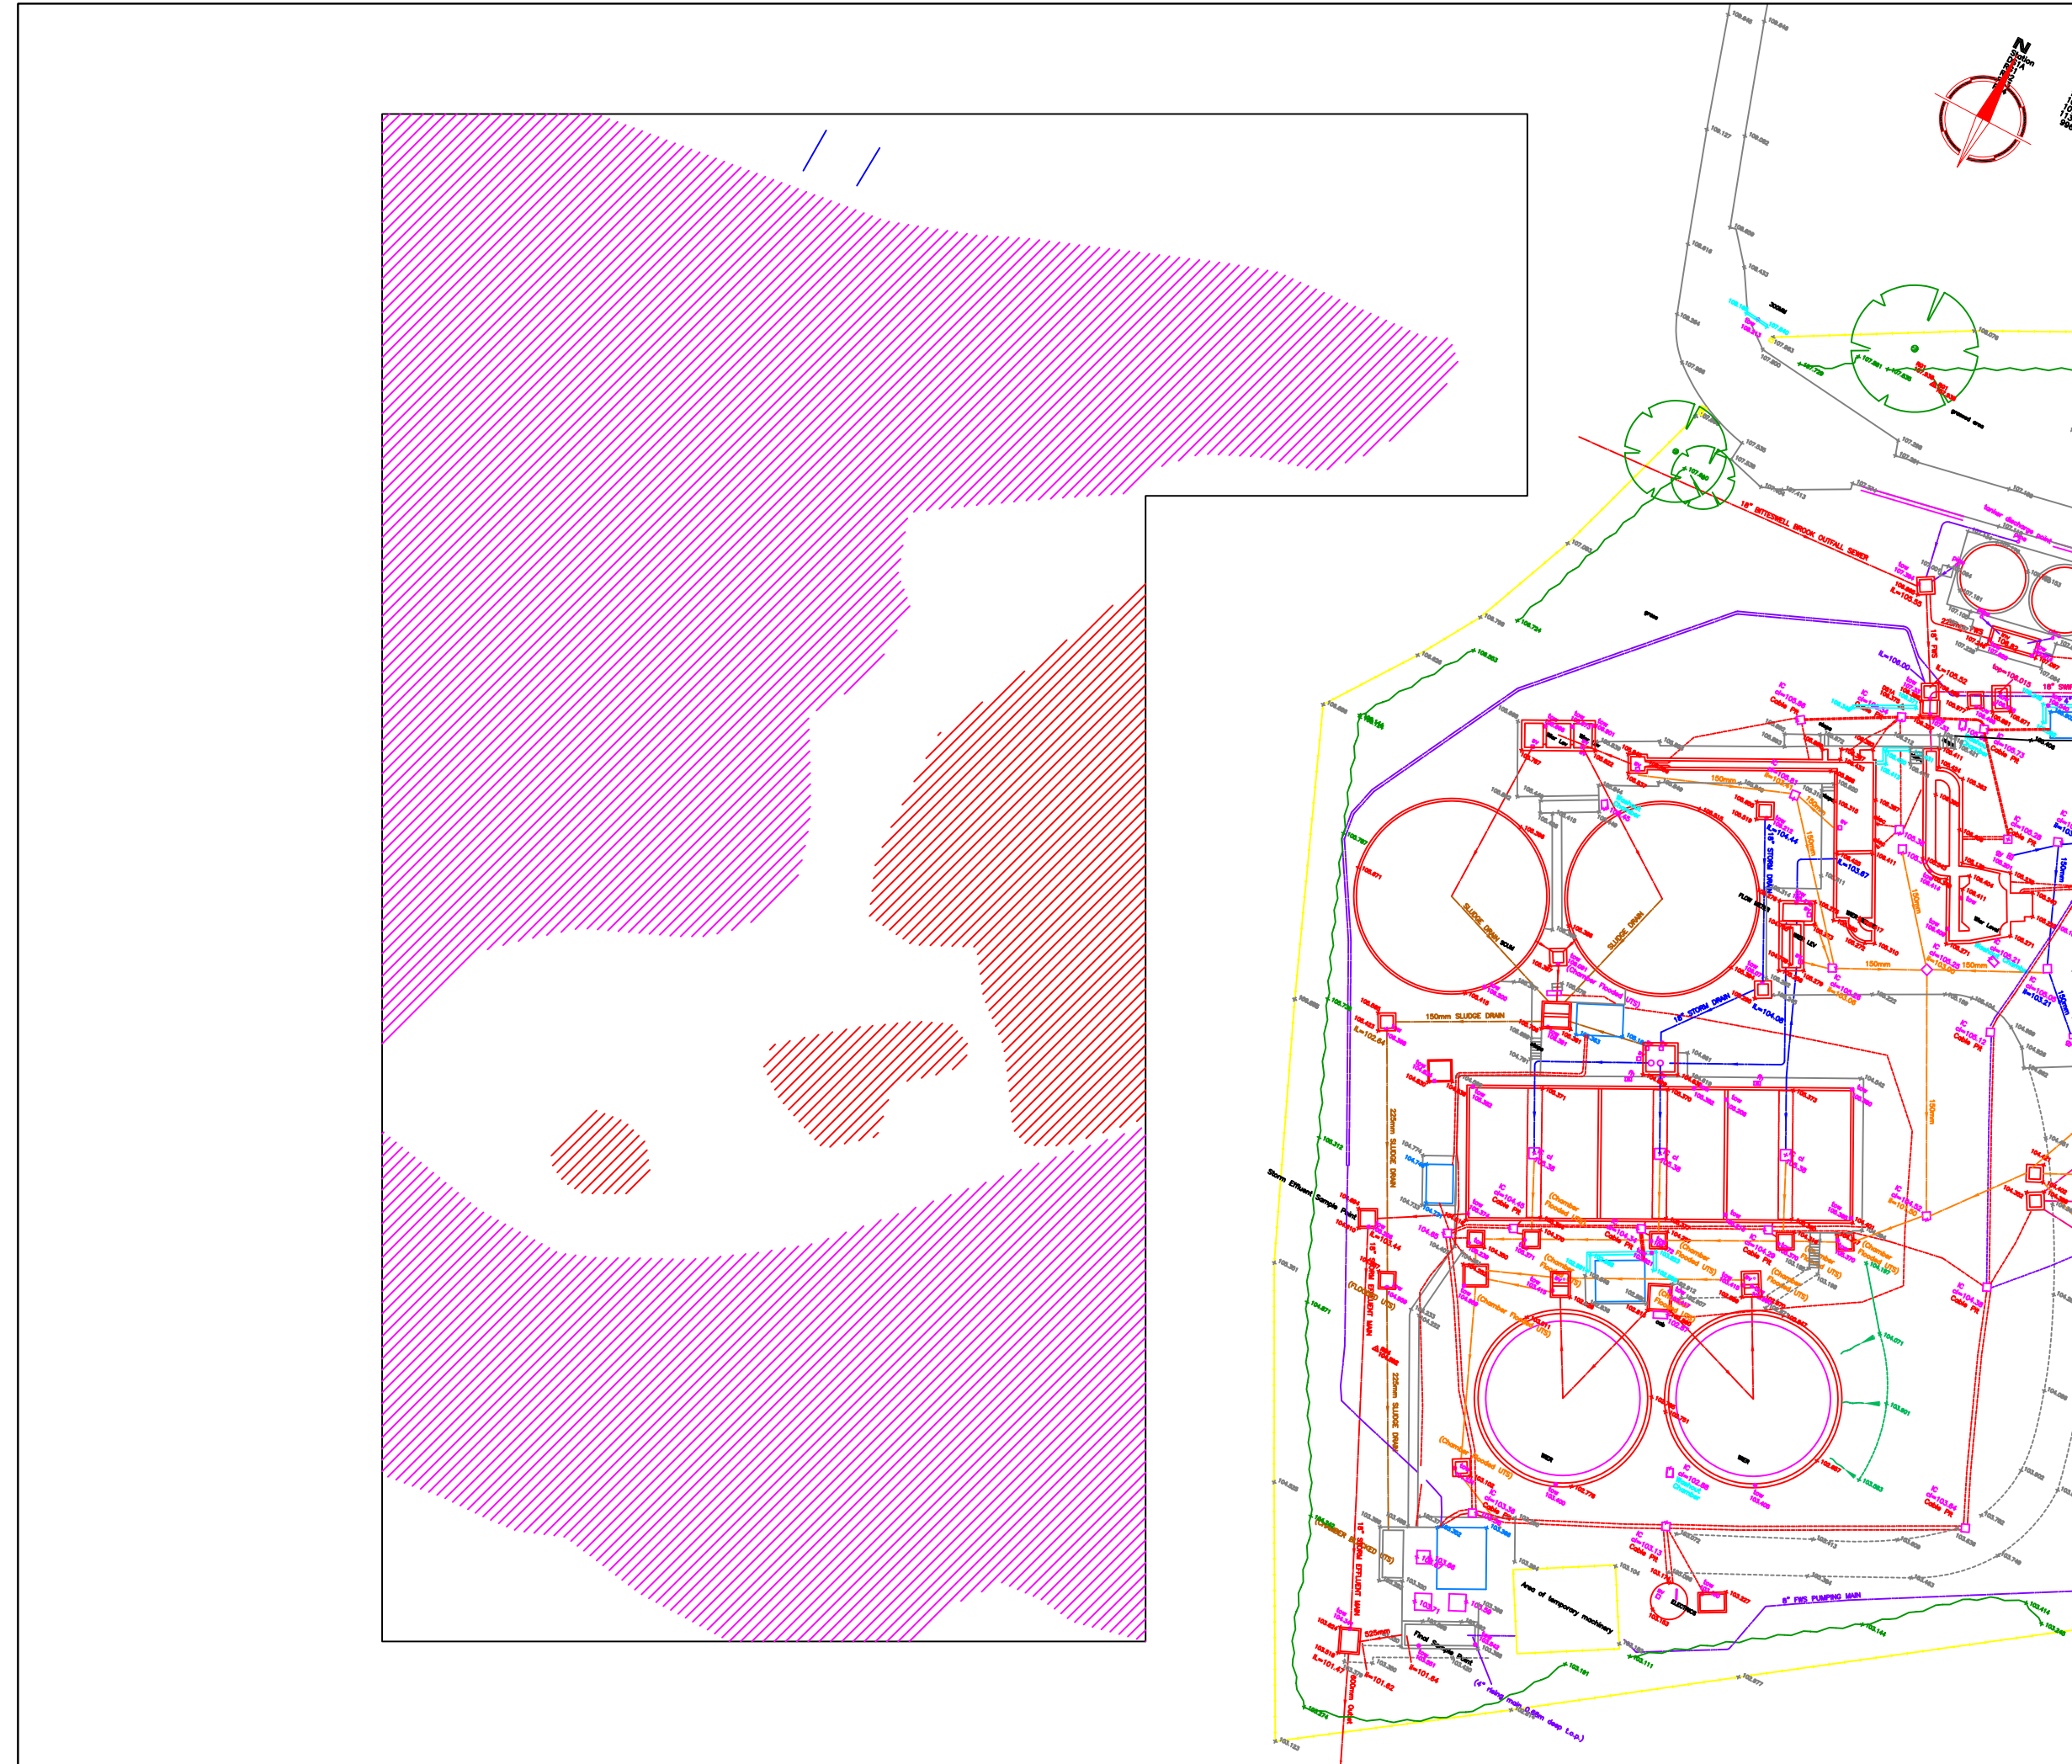
Project Title	Job No.
GEOPHYSICAL SURVEY - LUTTERWORTH STW	2036

Subject	PLOT OF PROCESSED GRADIOMETER DATA
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Scale	
1:500	

Plot	Checked by	Issue No.
A3	SAS	01
Survey date	Drawn by	Figure No.
JULY 05	DGE	06



Amendments		
Issue No.	Date	Description
-	-	-
-	-	-

KEY	
	Negative linear anomaly - uncertain origin
	Area of magnetic disturbance - probable modern ferrous objects
	Area of strong magnetic disturbance - probable modern ferrous objects

Client
ULAS

Project Title
GEOPHYSICAL SURVEY - LUTTERWORTH STW

Job No. 2036

Subject
ABSTRACTION AND INTERPRETATION OF GRADIOMETER ANOMALIES

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Scale
1:500

Plot A3	Checked by SAS	Issue No. 01
Survey date JULY 05	Drawn by DGE	Figure No. 07