


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 Upper Hook Road  
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 WR8 0SA  
 OS 100km square = SS

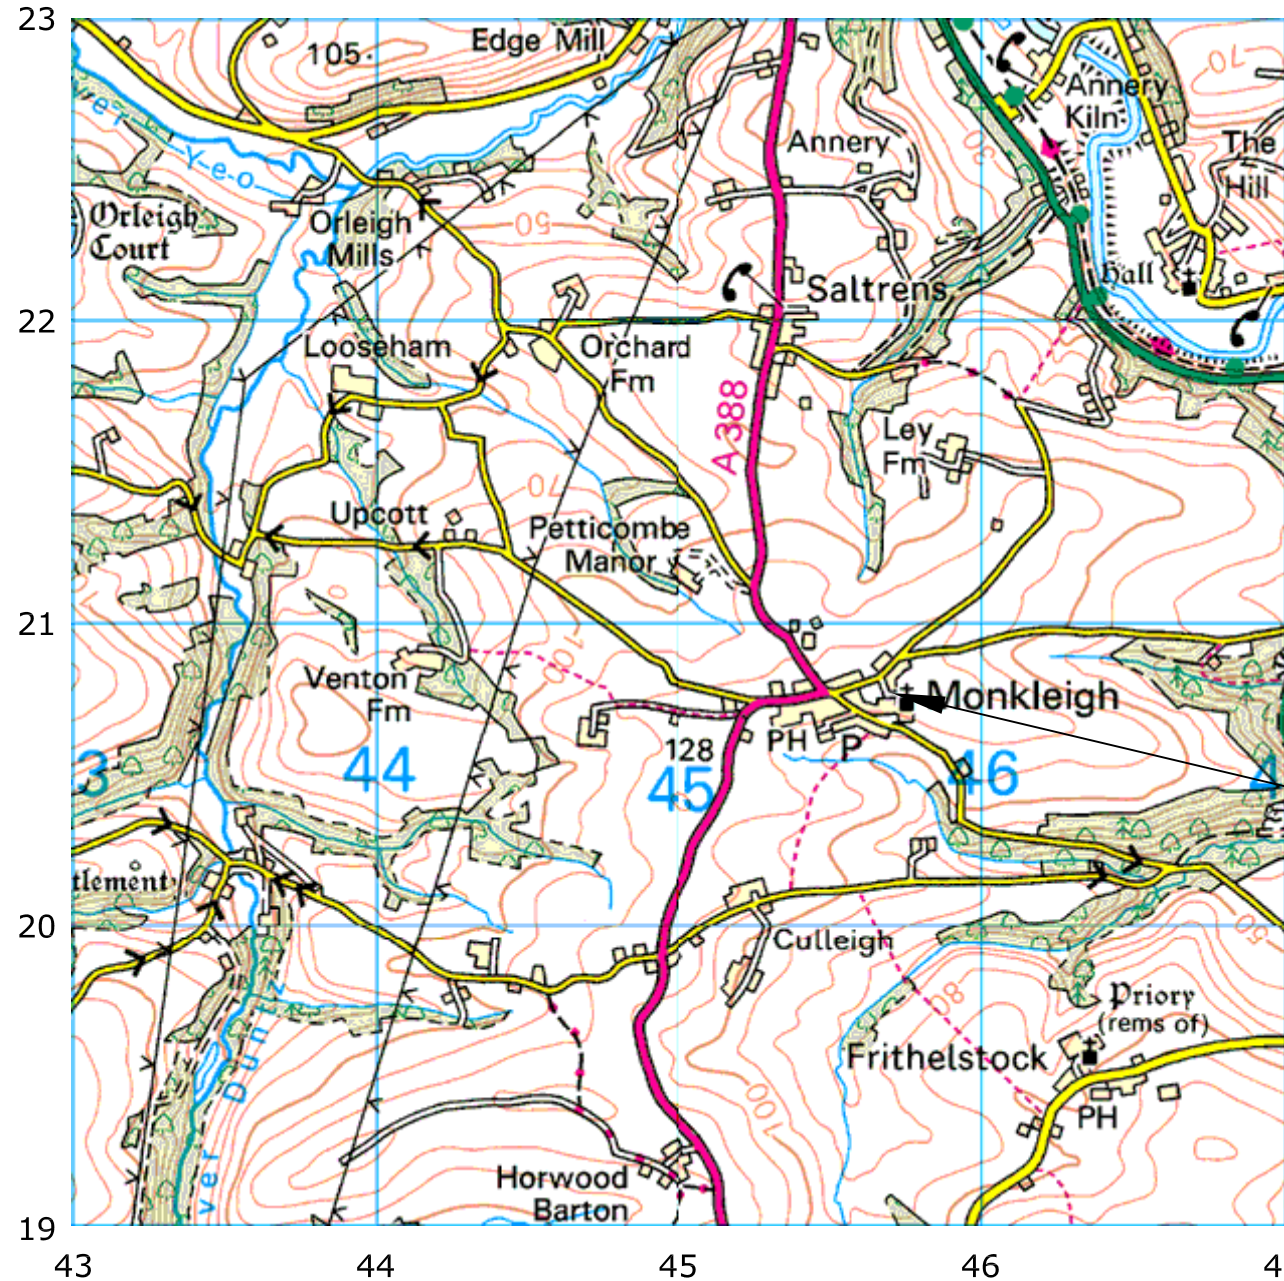

Survey Area

Amendments		
Issue No.	Date	Description
-	-	-

Site centred on NGR **SS 457 207**

Client  
**EXETER ARCHAEOLOGY**



Project Title **GEOPHYSICAL SURVEY - MONKLEIGH NORTH DEVON** Job No. 2219

Subject  
**LOCATION PLAN OF SURVEY AREA**

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 AND ENGINEERING  
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 T: +44 (0)1684 592266  
 F: +44 (0)1684 594142  
 E: info@stratascan.co.uk  
 www.stratascan.co.uk

Scale **1:25 000** 0m 500 1000m

Plot <b>A3</b>	Checked by <b>SAS</b>	Issue No. <b>01</b>
Survey date <b>SEPT 06</b>	Drawn by <b>HH</b>	Figure No. <b>01</b>

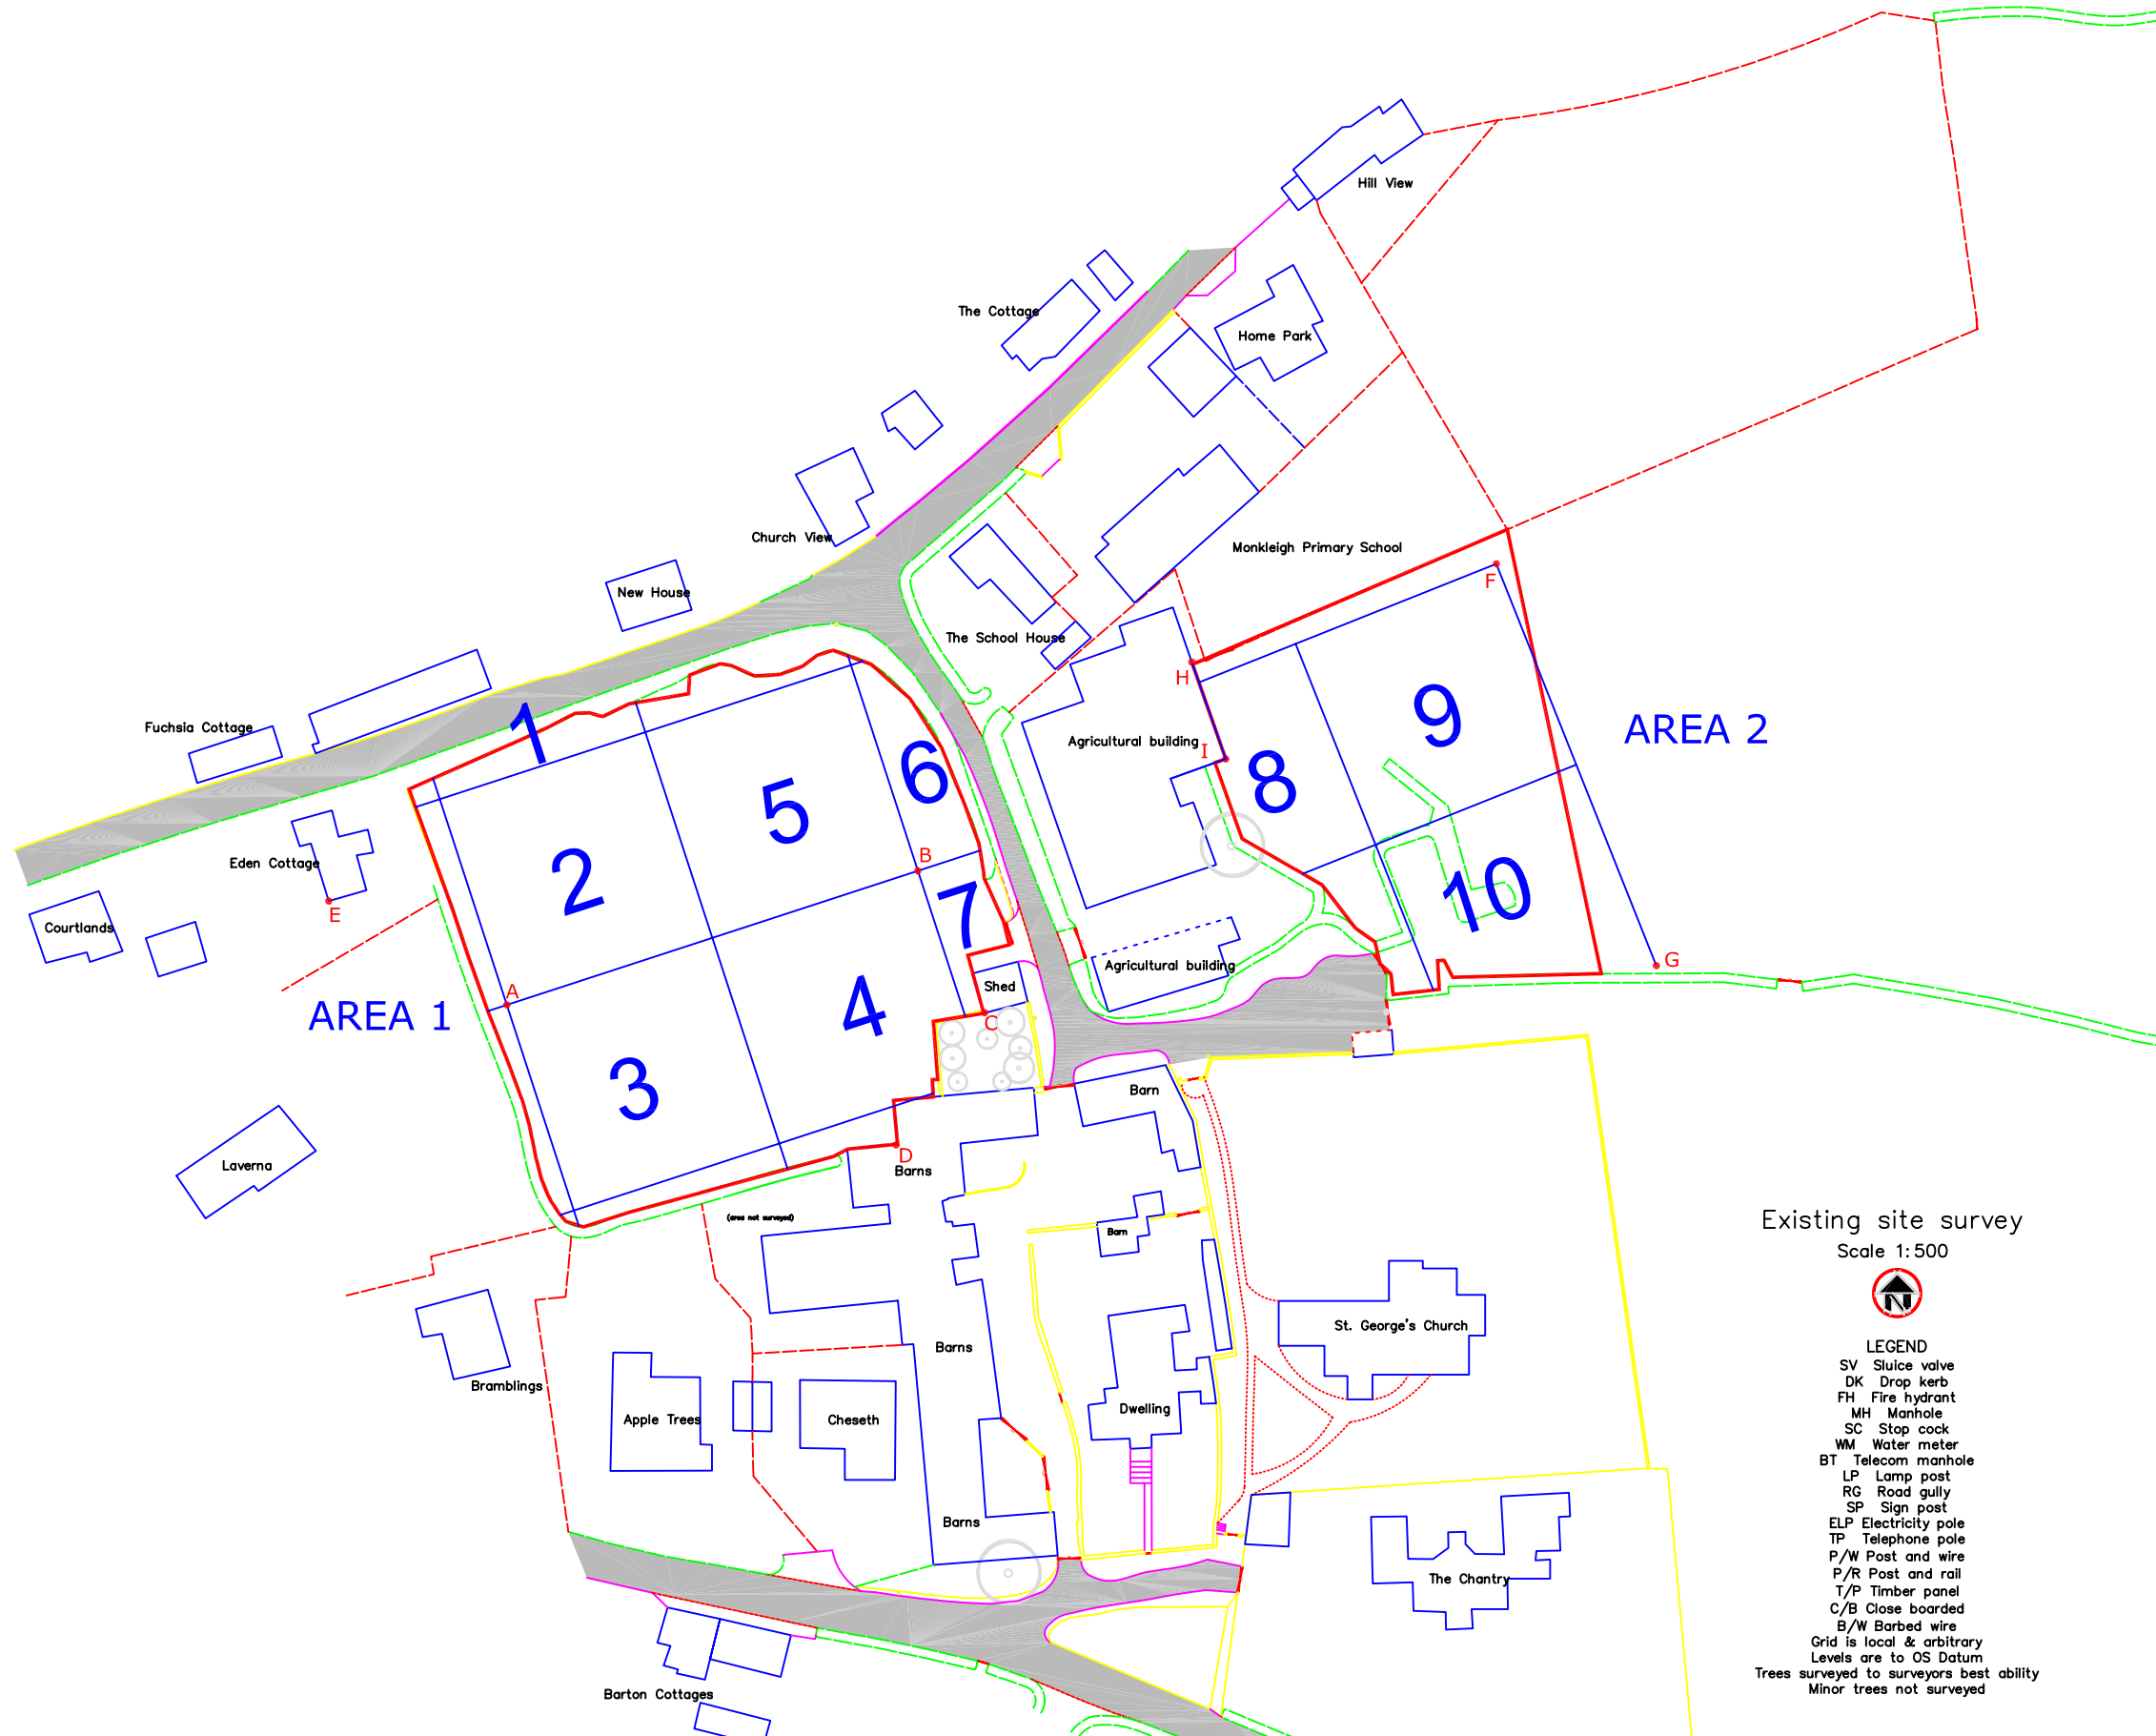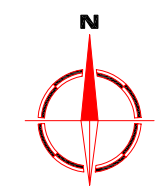

Existing site survey  
Scale 1:500

- LEGEND**
- SV Sluice valve
  - DK Drop kerb
  - FH Fire hydrant
  - MH Manhole
  - SC Stop cock
  - WM Water meter
  - BT Telecom manhole
  - LP Lamp post
  - RG Road gully
  - SP Sign post
  - ELP Electricity pole
  - TP Telephone pole
  - P/W Post and wire
  - P/R Post and rail
  - T/P Timber panel
  - C/B Close boarded
  - B/W Barbed wire
- Grid is local & arbitrary  
Levels are to OS Datum  
Trees surveyed to surveyors best ability  
Minor trees not surveyed

Amendments		
Issue No.	Date	Description
-	-	-
-	-	-

REFERENCING INFORMATION					
A-B	60m	A-C	66.4m	A-D	57.46m
A-E	28.44m	B-C	21.75m	B-D	38.14m
B-E	81.36m	H-I	14.08m	H-F	44.50m
I-F	46.16m	H-G	77.08m	I-G	66.35m
A-B F-G	Base line				
C,D, E	Referencing points				
2	Grid number				

Client  
**EXETER ARCHAEOLOGY**

Project Title  
**GEOPHYSICAL SURVEY - MONKLEIGH NORTH DEVON**

Job No. 2219


Subject  
**SITE PLAN SHOWING LOCATION OF SURVEY GRIDS AND REFERENCING**

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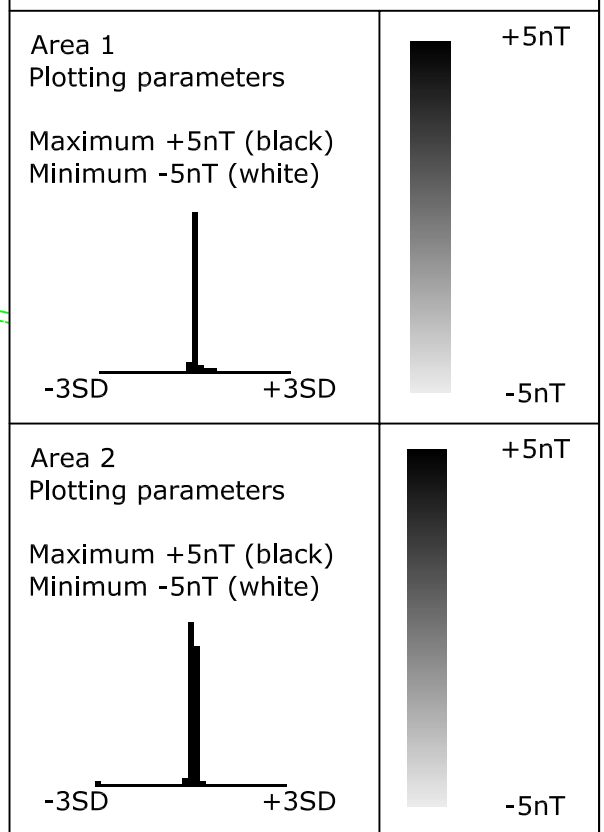
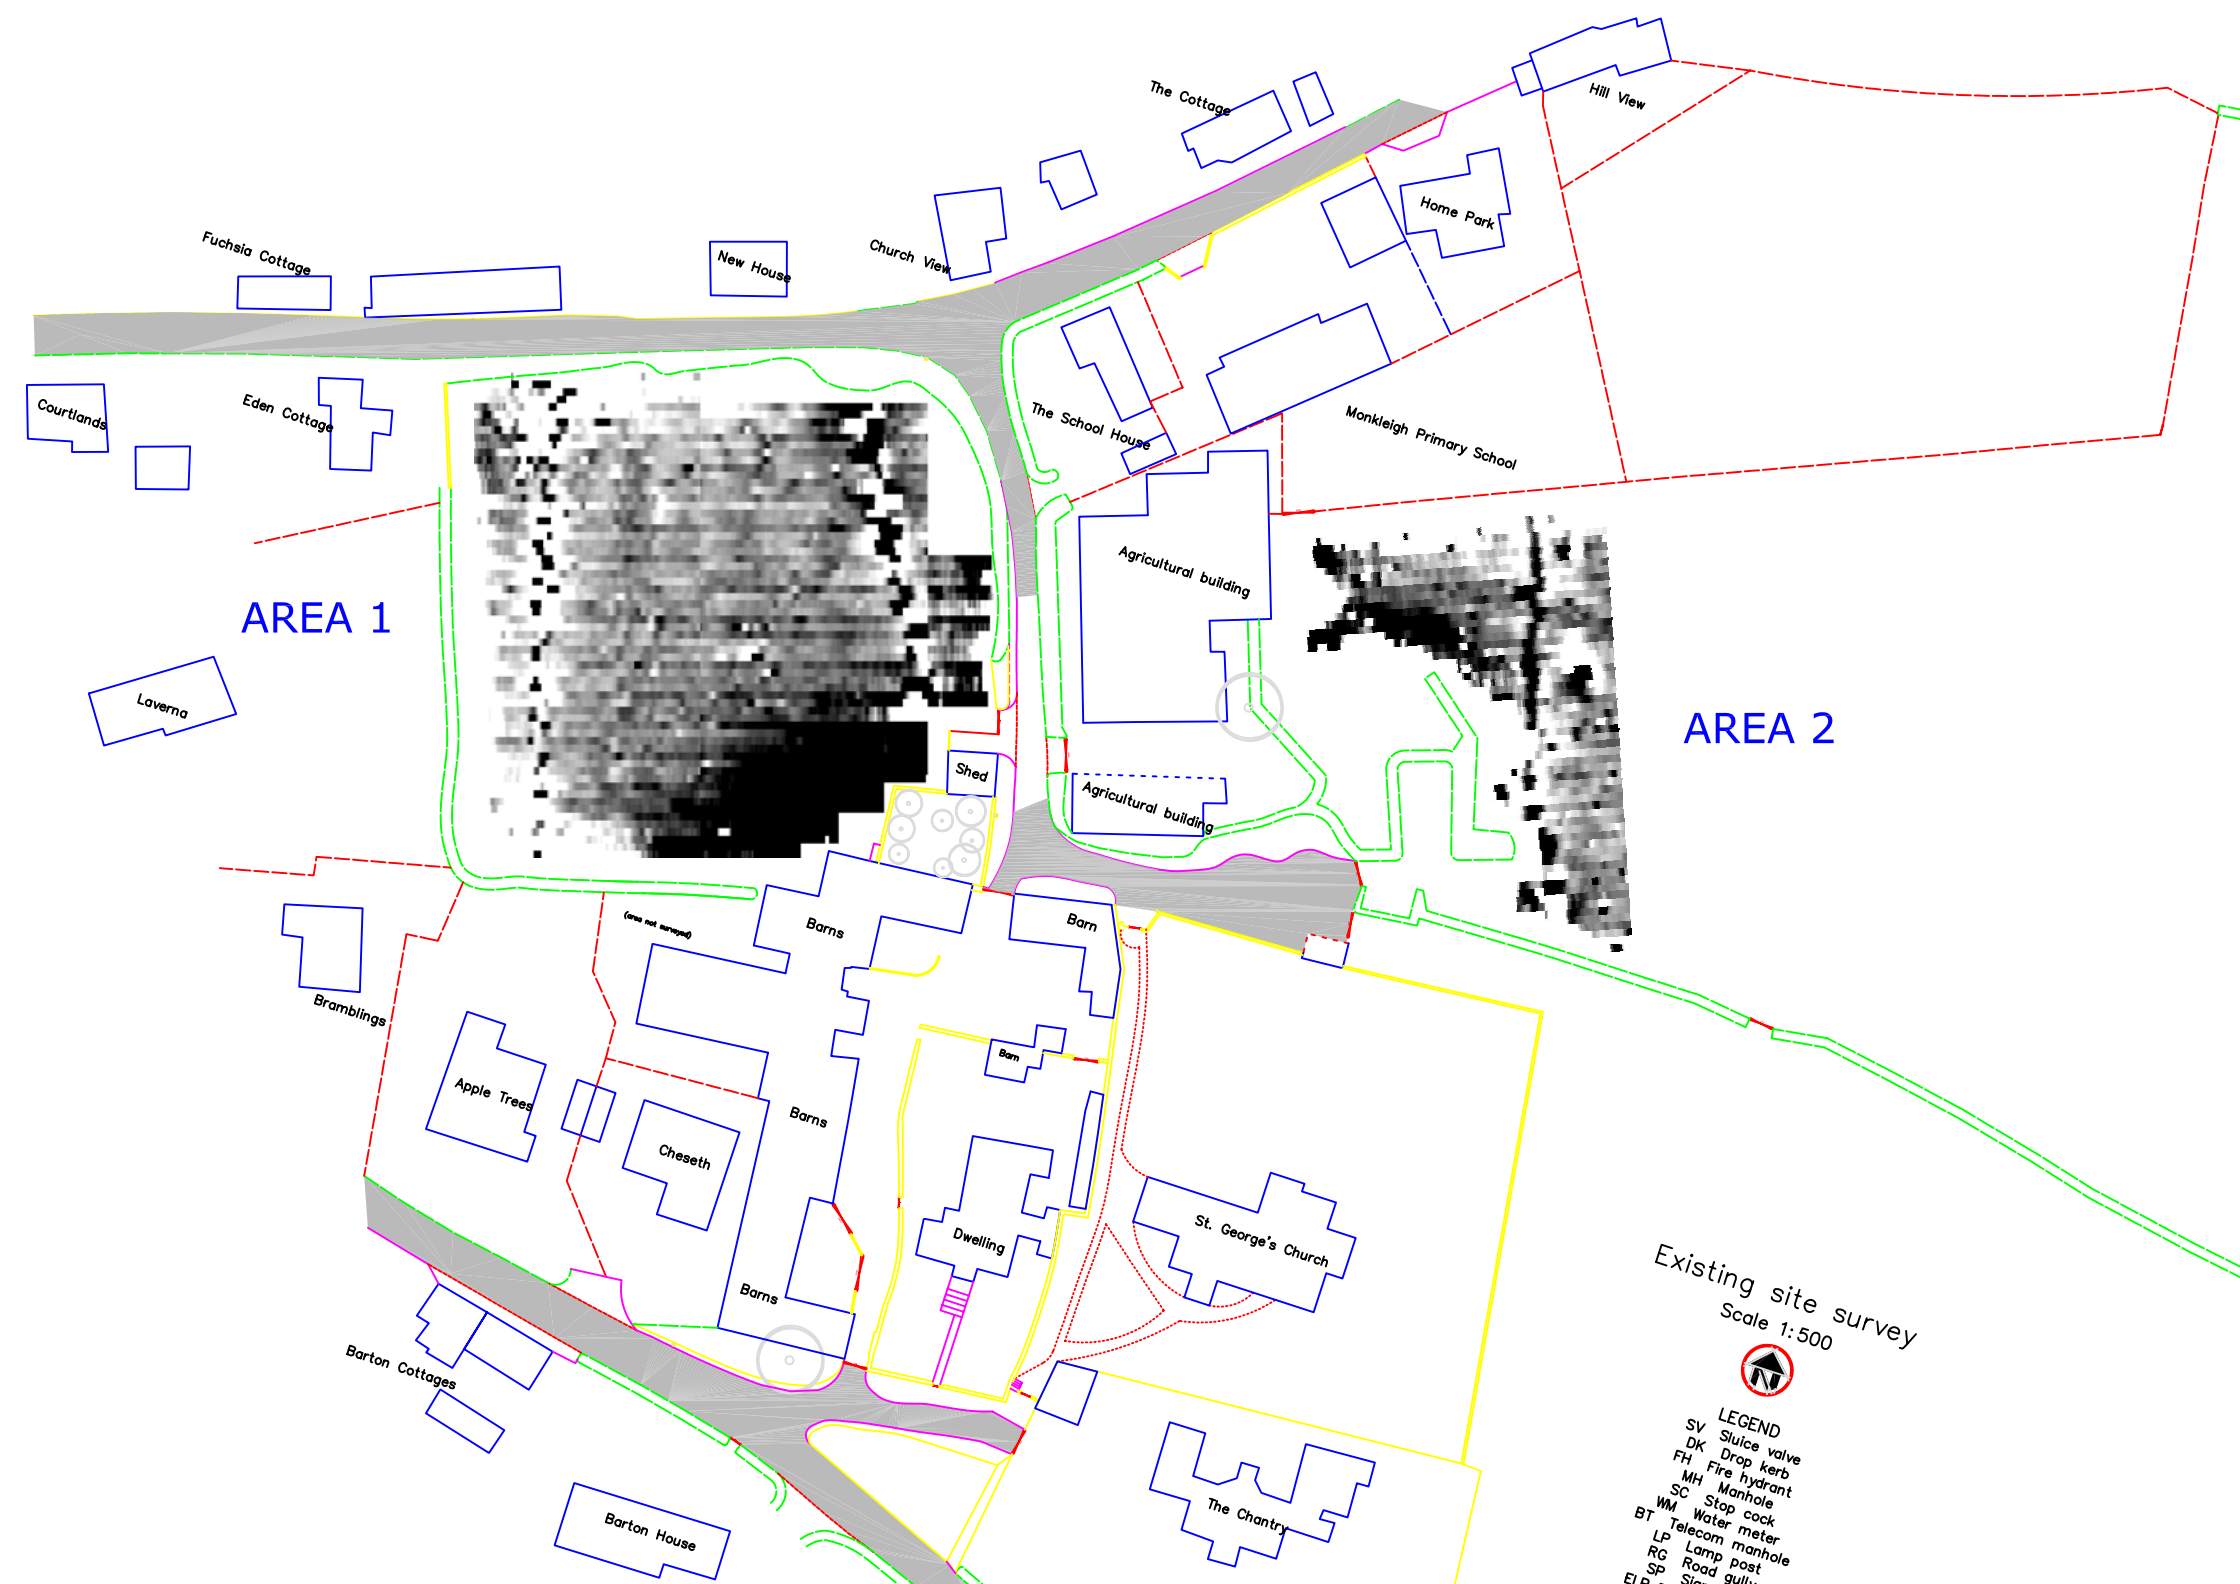
REGISTERED ORGANISATION  
IFA



Scale <b>1:1000</b>	Checked by <b>SAS</b>	Issue No. <b>01</b>
Plot <b>A3</b>	Drawn by <b>HH</b>	Figure No. <b>02</b>
Survey date <b>SEPT 06</b>		

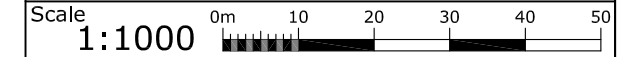

Amendments		
Issue No.	Date	Description
-	-	-
-	-	-




Client  
**EXETER ARCHAEOLOGY**

Project Title  
**GEOPHYSICAL SURVEY - MONKLEIGH NORTH DEVON**

Job No. 2219

Subject  
**PLOT OF RAW GRADIOMETER DATA**


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 www.stratascan.co.uk

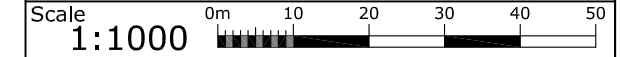

Existing site survey  
Scale 1:500

- LEGEND**
- SV Sluice valve
  - DK Drop kerb
  - FH Fire hydrant
  - MH Manhole
  - SC Stop cock
  - WM Water meter
  - BT Telecom manhole
  - LP Lamp post
  - RG Road gully
  - SP Sign
  - ELP

Plot <b>A3</b>	Checked by <b>SAS</b>	Issue No. <b>01</b>
Survey date <b>SEPT 06</b>	Drawn by <b>HH</b>	Figure No. <b>03</b>

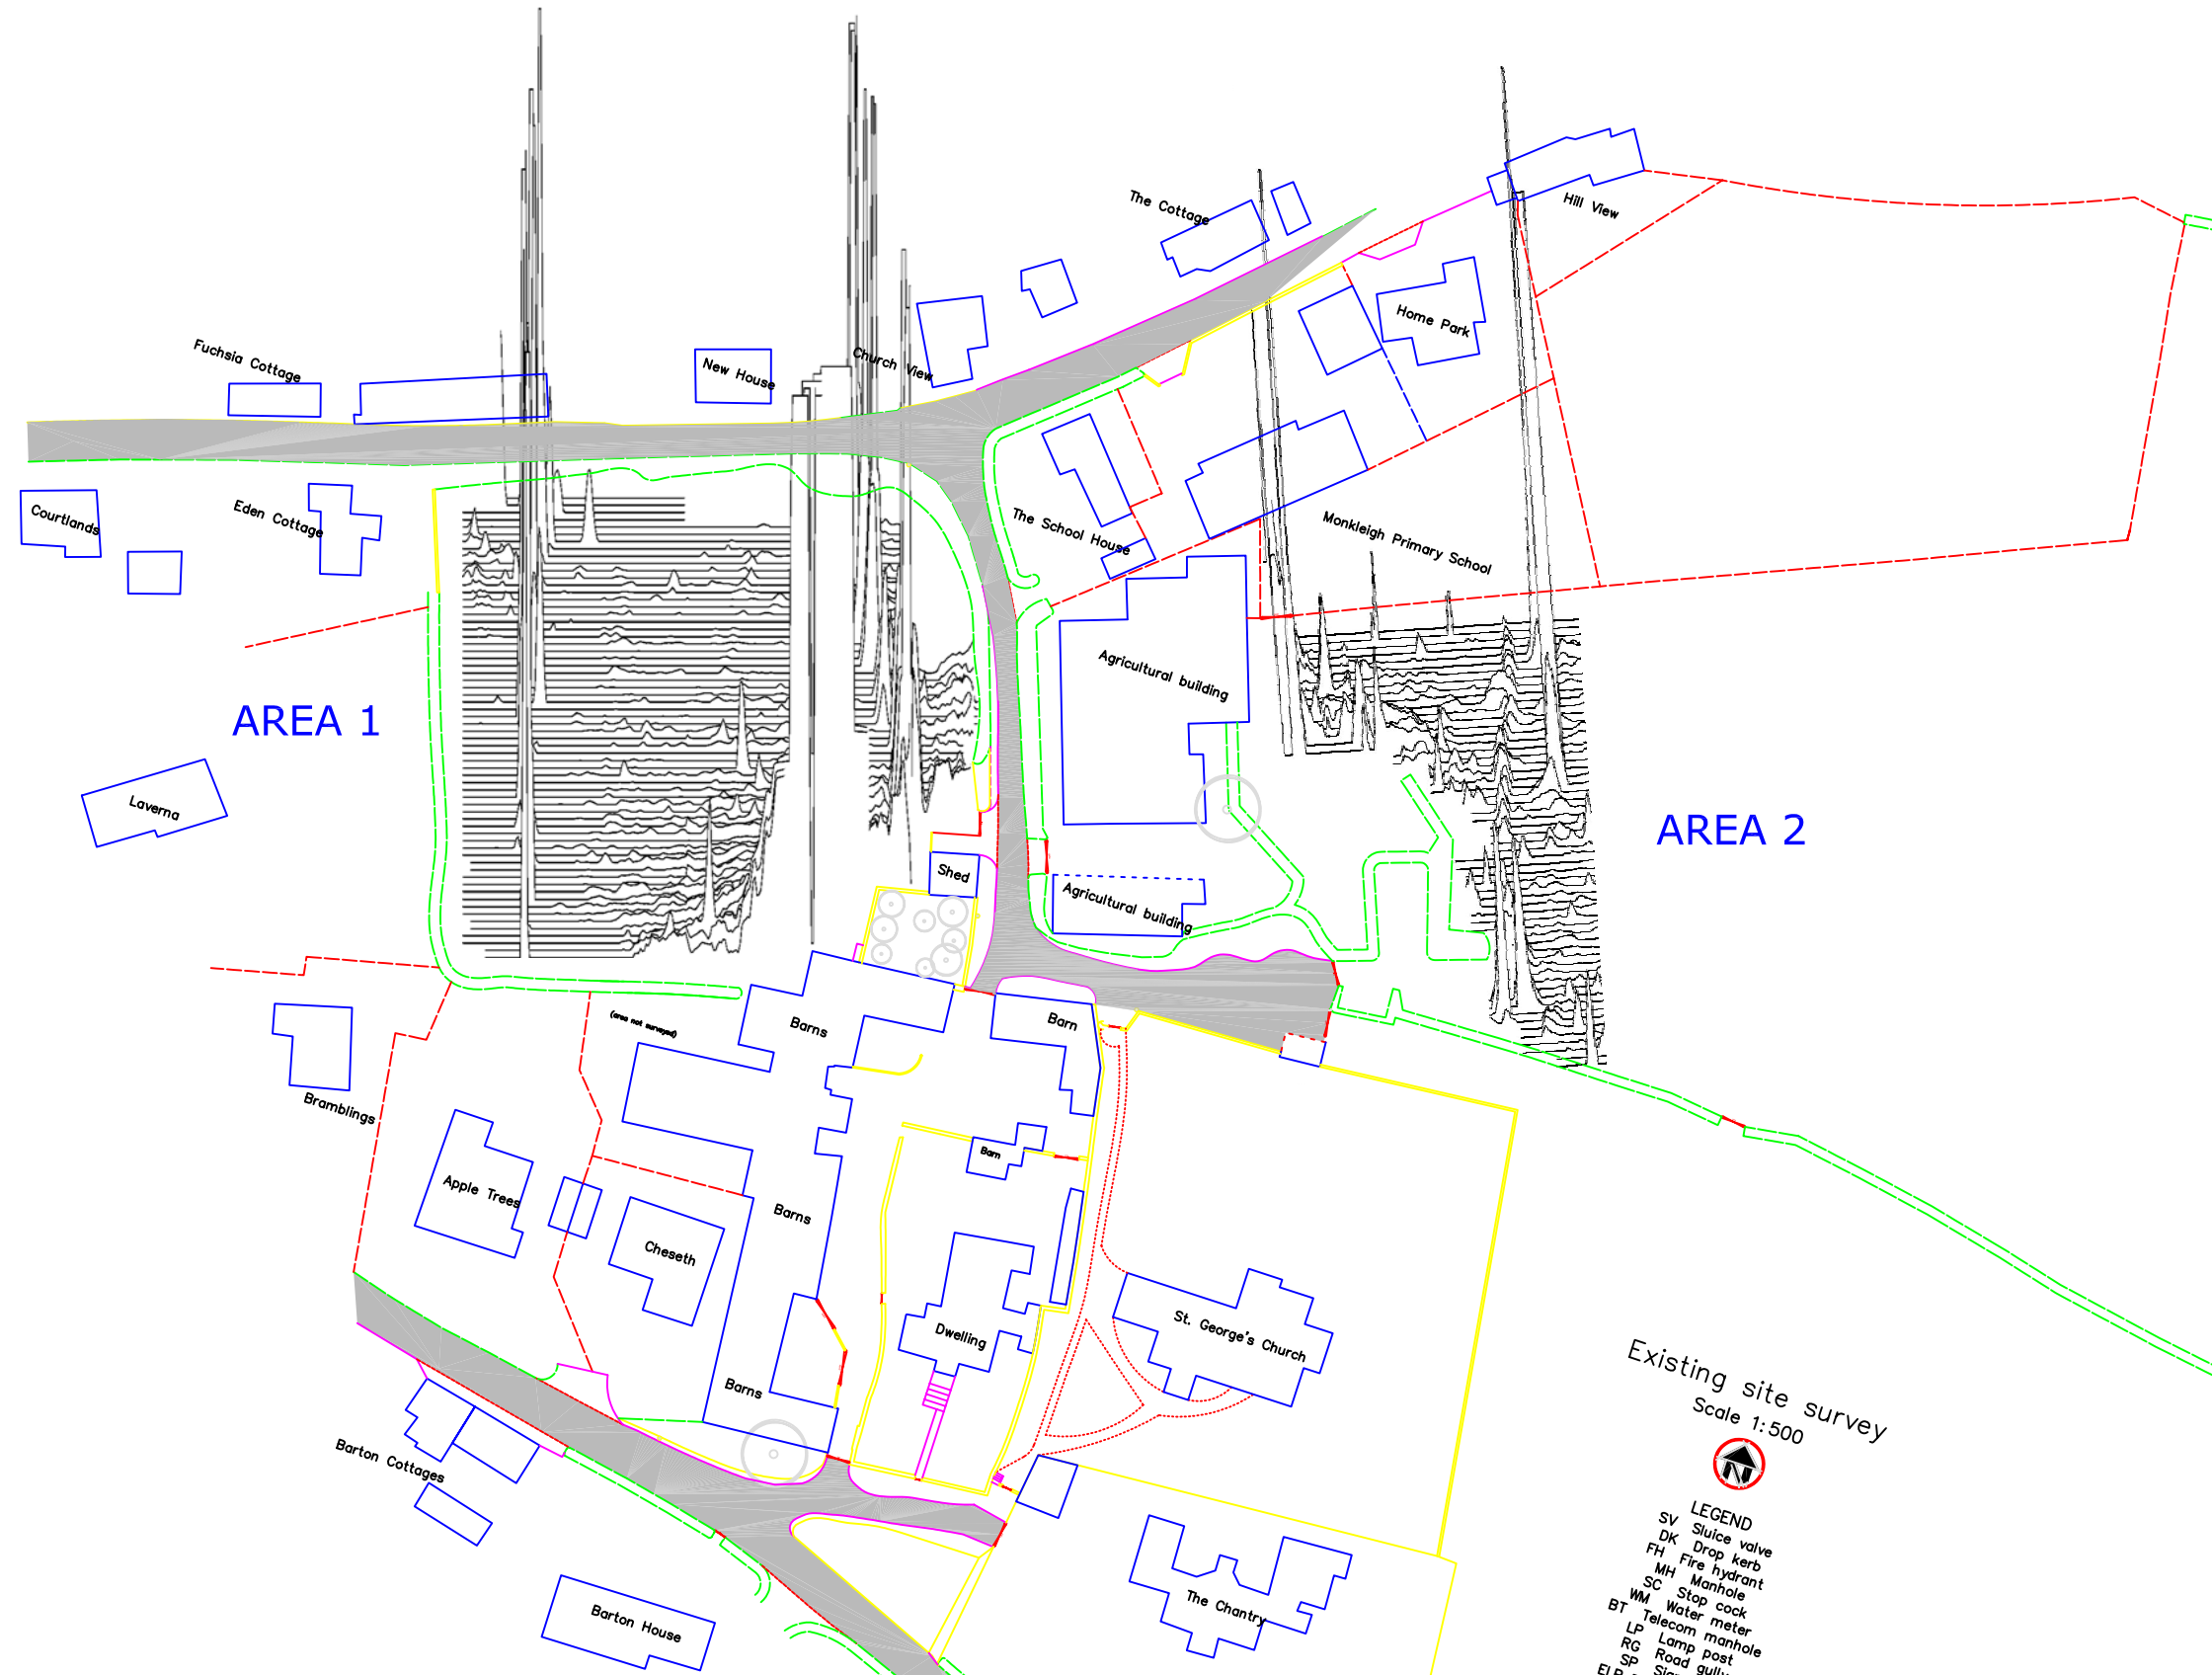

Amendments		
Issue No.	Date	Description
-	-	-

Plotting parameters	200nT
+40nT	160nT
(Positive values displace above the trace line. Hidden values have not been plotted). Data clipped at 300nT	120nT
	80nT
	40nT
	0nT

Client  
**EXETER ARCHAEOLOGY**

Project Title  
**GEOPHYSICAL SURVEY - MONKLEIGH NORTH DEVON**


Job No. 2219

Subject  
**TRACE PLOT OF GRADIOMETER DATA SHOWING POSITIVE VALUES**


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Scale  
**1:1000**



Plot <b>A3</b>	Checked by <b>SAS</b>	Issue No. <b>01</b>
Survey date <b>SEPT 06</b>	Drawn by <b>HH</b>	Figure No. <b>04</b>

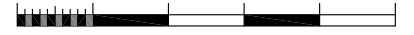

Amendments		
Issue No.	Date	Description
-	-	-

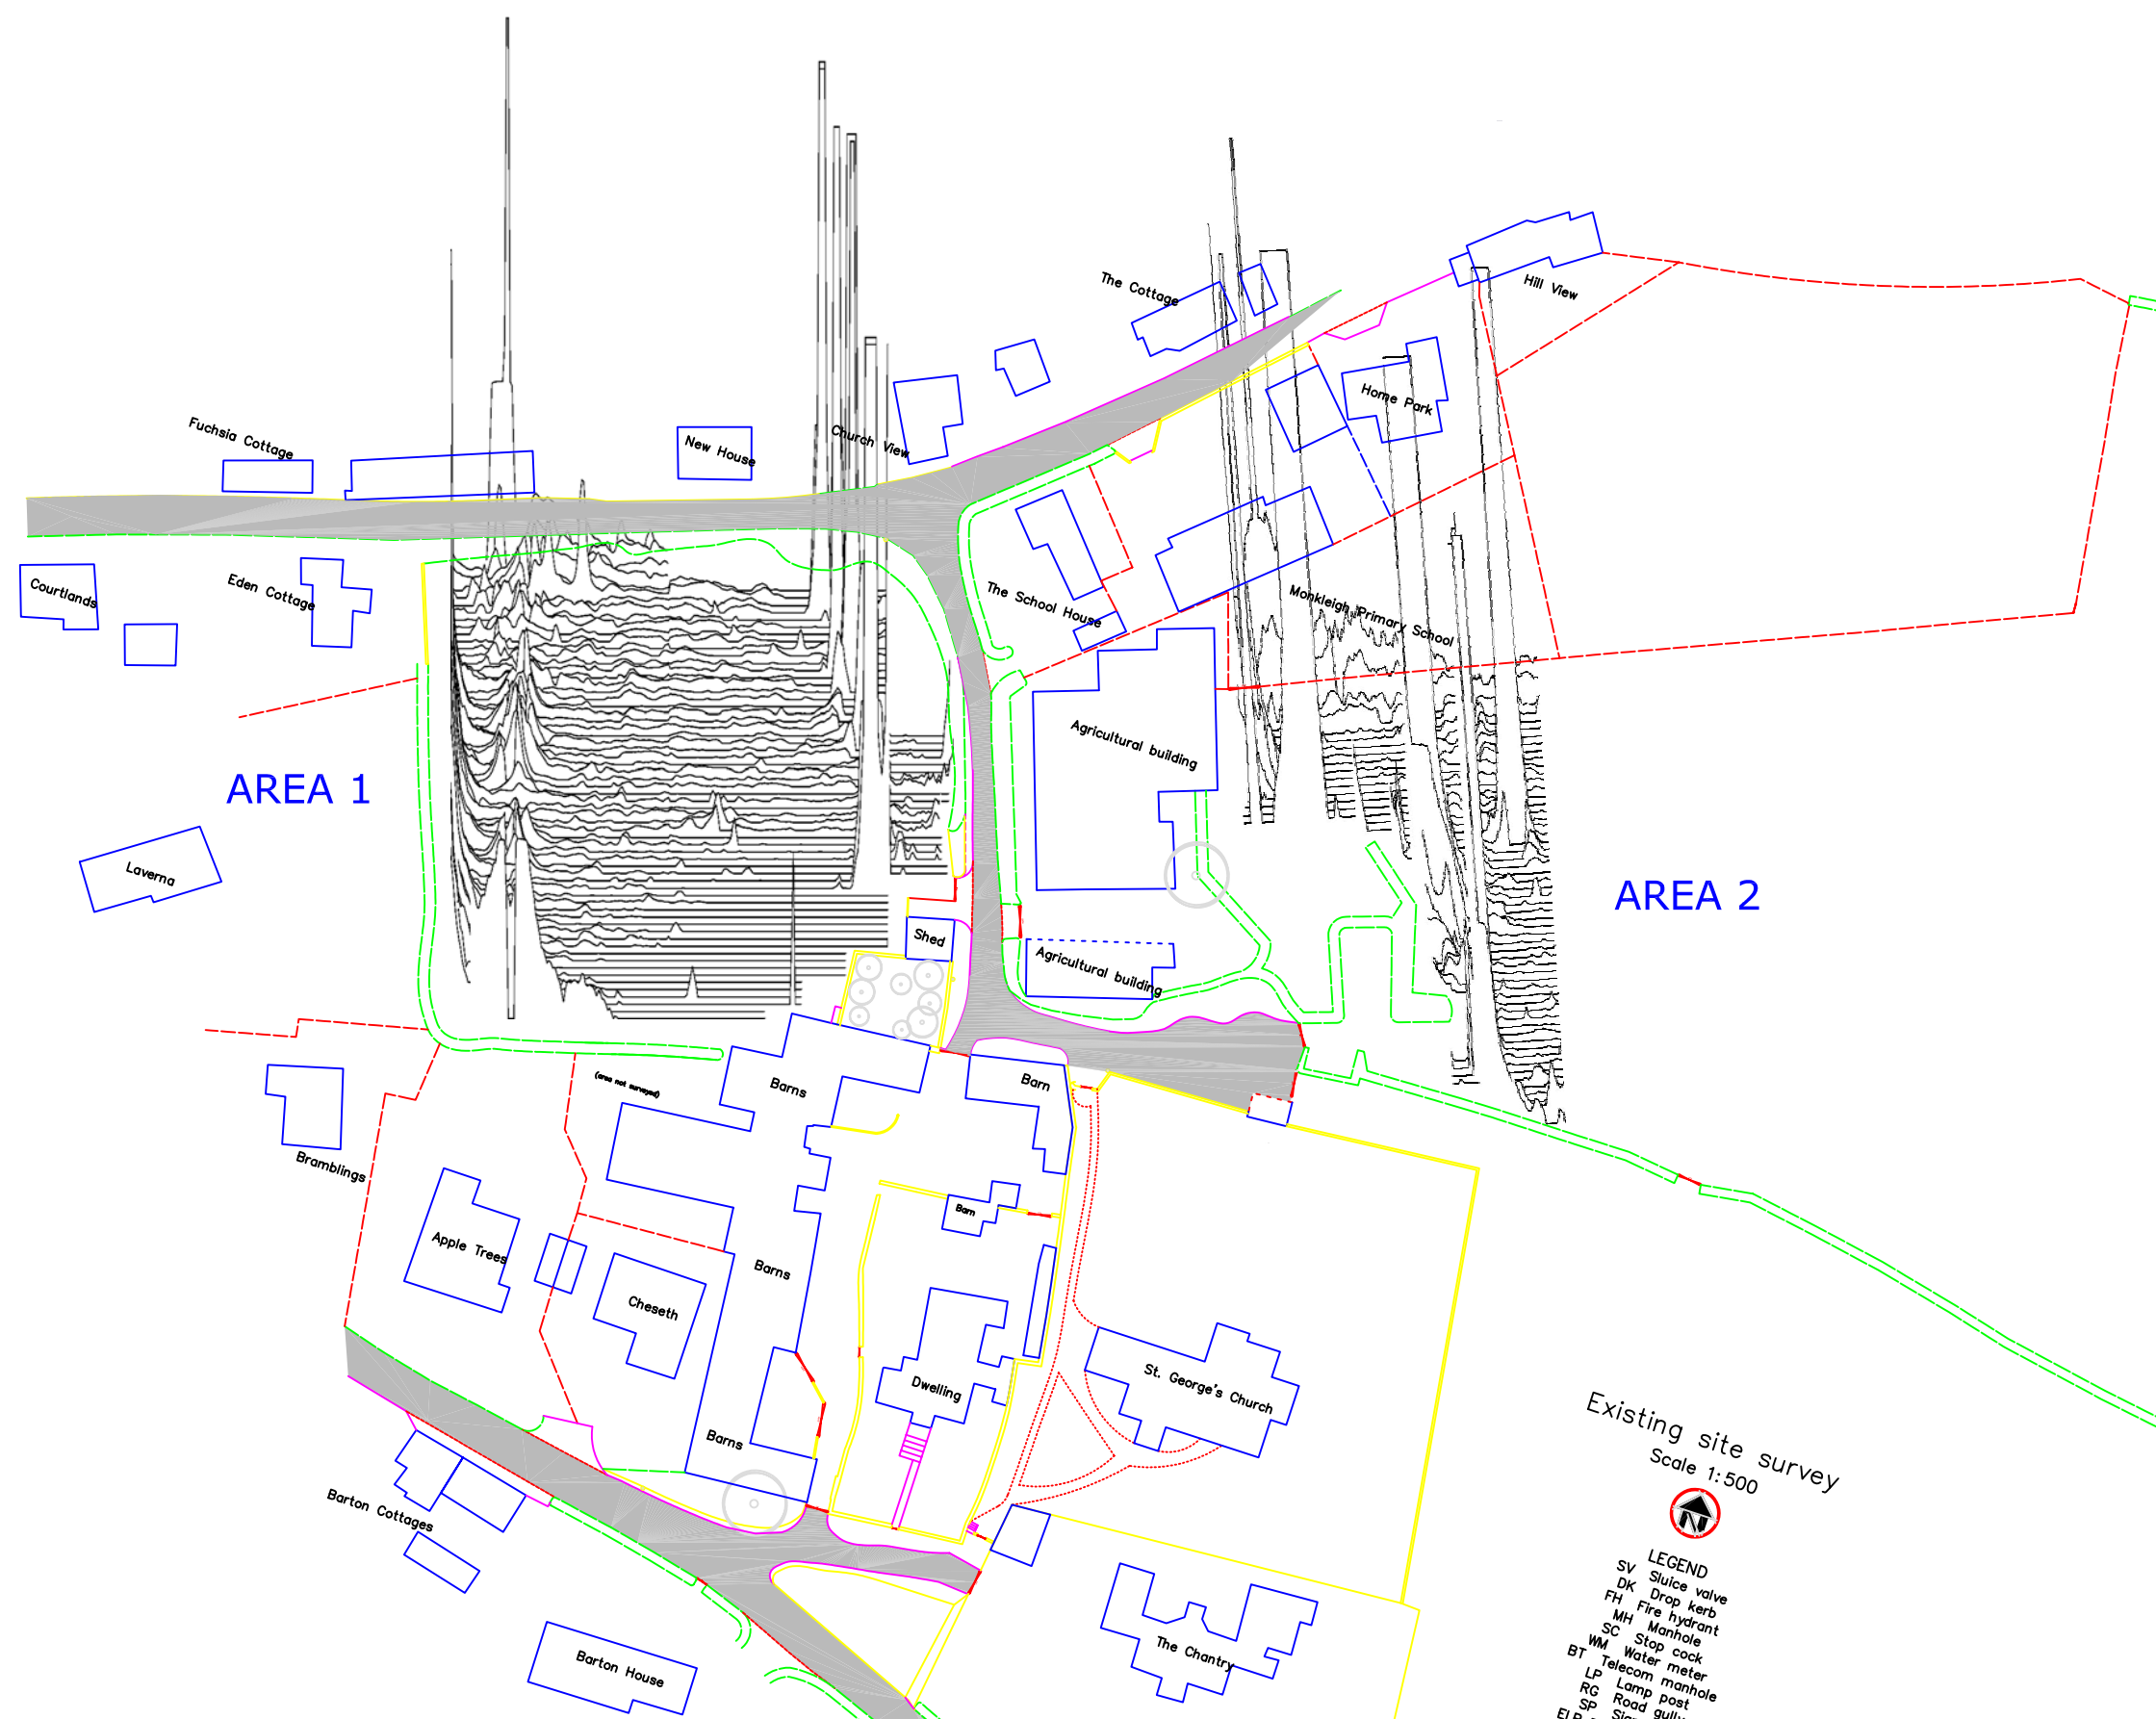Plotting parameters	-200nT
-40nT	-160nT
(Negative values displace above the trace line. Hidden values have not been plotted. Data clipped at -300nT)	-120nT
	-80nT
	-40nT
	0nT

Client  
**EXETER ARCHAEOLOGY**

Project Title  
**GEOPHYSICAL SURVEY - MONKLEIGH NORTH DEVON**


Job No. 2219

Subject  
**TRACE PLOT OF GRADIOMETER DATA SHOWING NEGATIVE VALUES**


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Scale  
**1:1000**





Plot <b>A3</b>	Checked by <b>SAS</b>	Issue No. <b>01</b>
Survey date <b>SEPT 06</b>	Drawn by <b>HH</b>	Figure No. <b>05</b>

- Existing site survey  
Scale 1:500
- 
- LEGEND**
- SV Sluice valve
  - DK Drop kerb
  - FH Fire hydrant
  - MH Manhole
  - SC Stop cock
  - WM Water meter
  - BT Telecom manhole
  - LP Lamp post
  - RG Road gully
  - SP
  - ELP



Amendments		
Issue No.	Date	Description
-	-	-
-	-	-

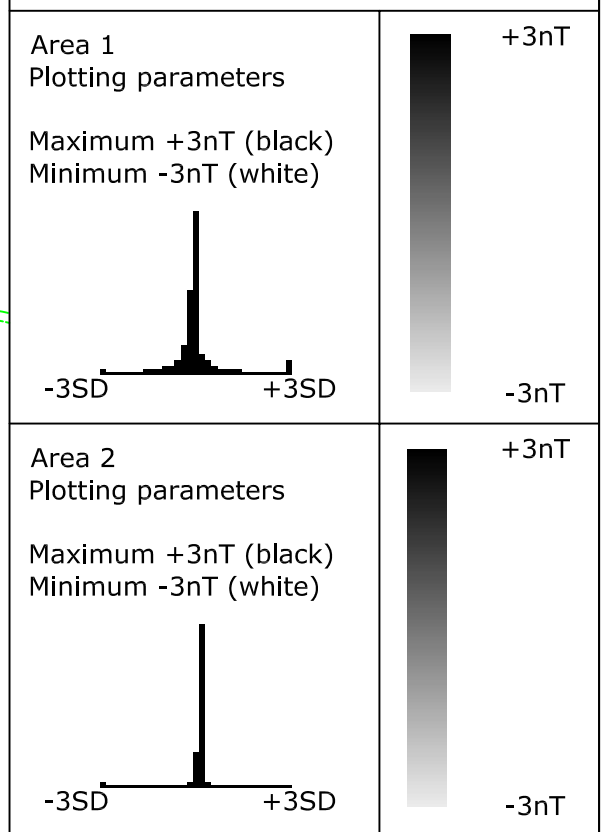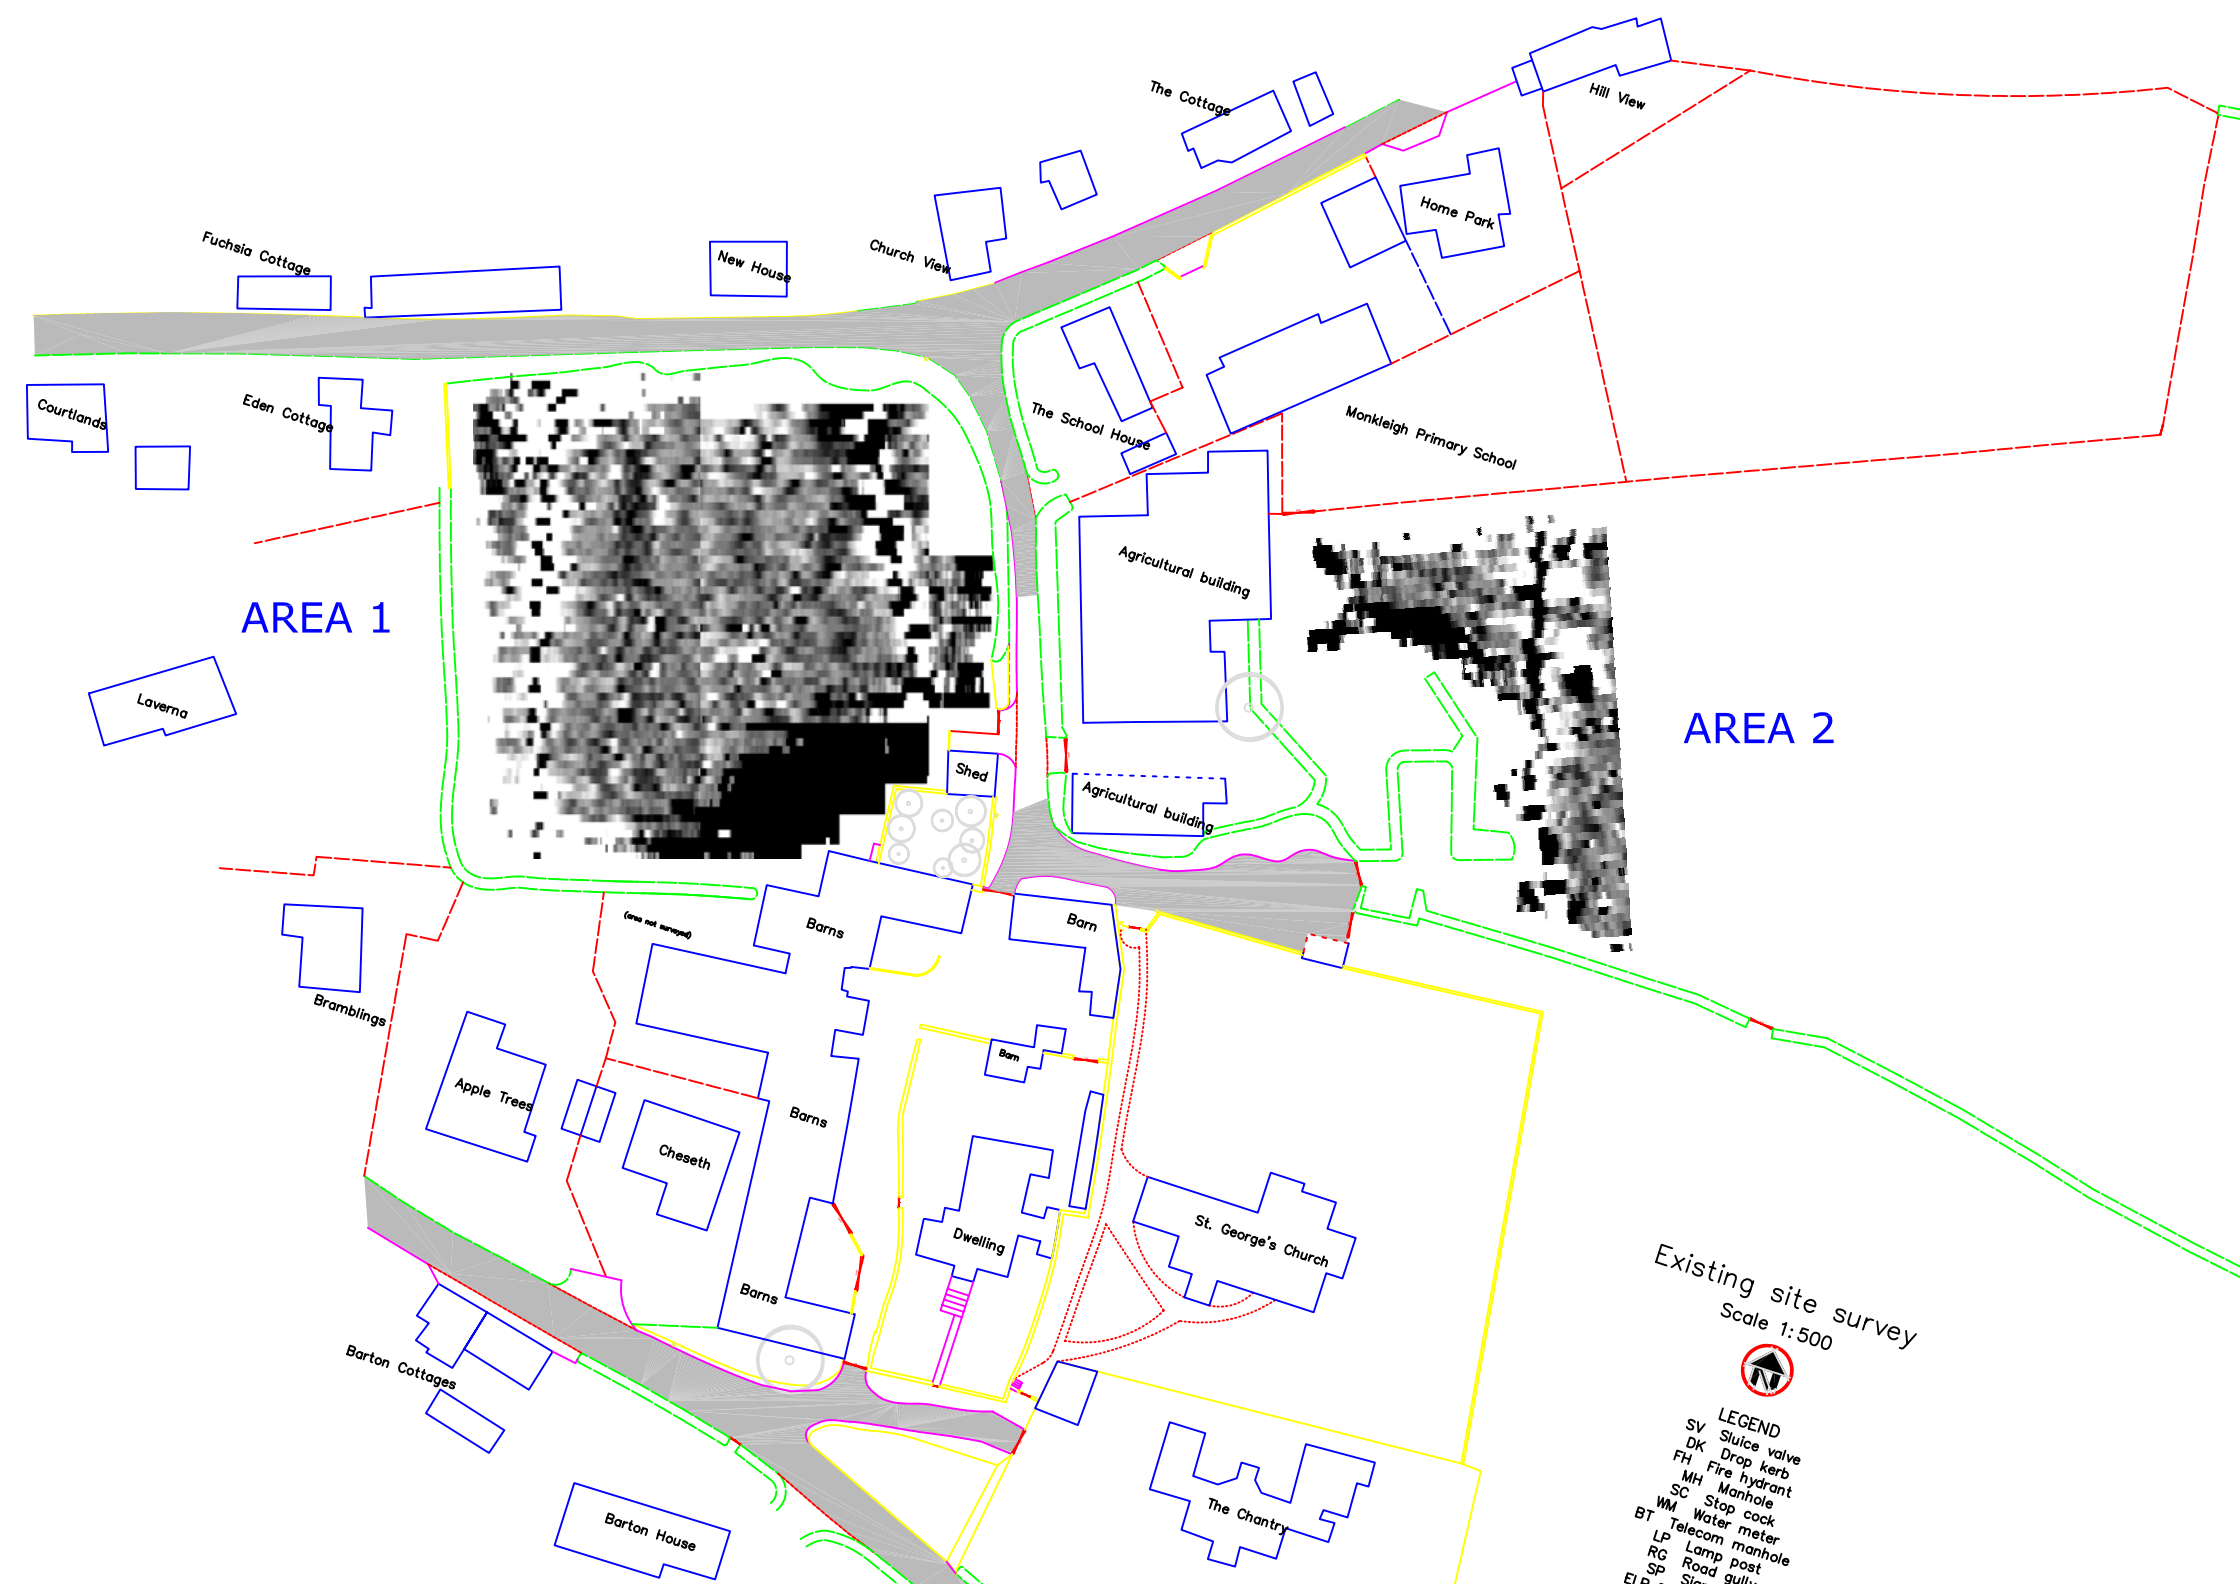

Client  
**EXETER ARCHAEOLOGY**

Project Title  
**GEOPHYSICAL SURVEY - MONKLEIGH NORTH DEVON**

Job No. 2219

Subject  
**PLOT OF PROCESSED GRADIOMETER DATA**


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Scale 1:1000

0m 10 20 30 40 50

- Existing site survey  
Scale 1:500
- 
- LEGEND**
- SV Sluice valve
  - DK Drop kerb
  - FH Fire hydrant
  - MH Manhole
  - SC Stop cock
  - WM Water meter
  - BT Telecom manhole
  - LP Lamp post
  - RG Road gully
  - SP Sign
  - ELP

Plot	Checked by	Issue No.
A3	SAS	01
Survey date	Drawn by	Figure No.
SEPT 06	HH	06

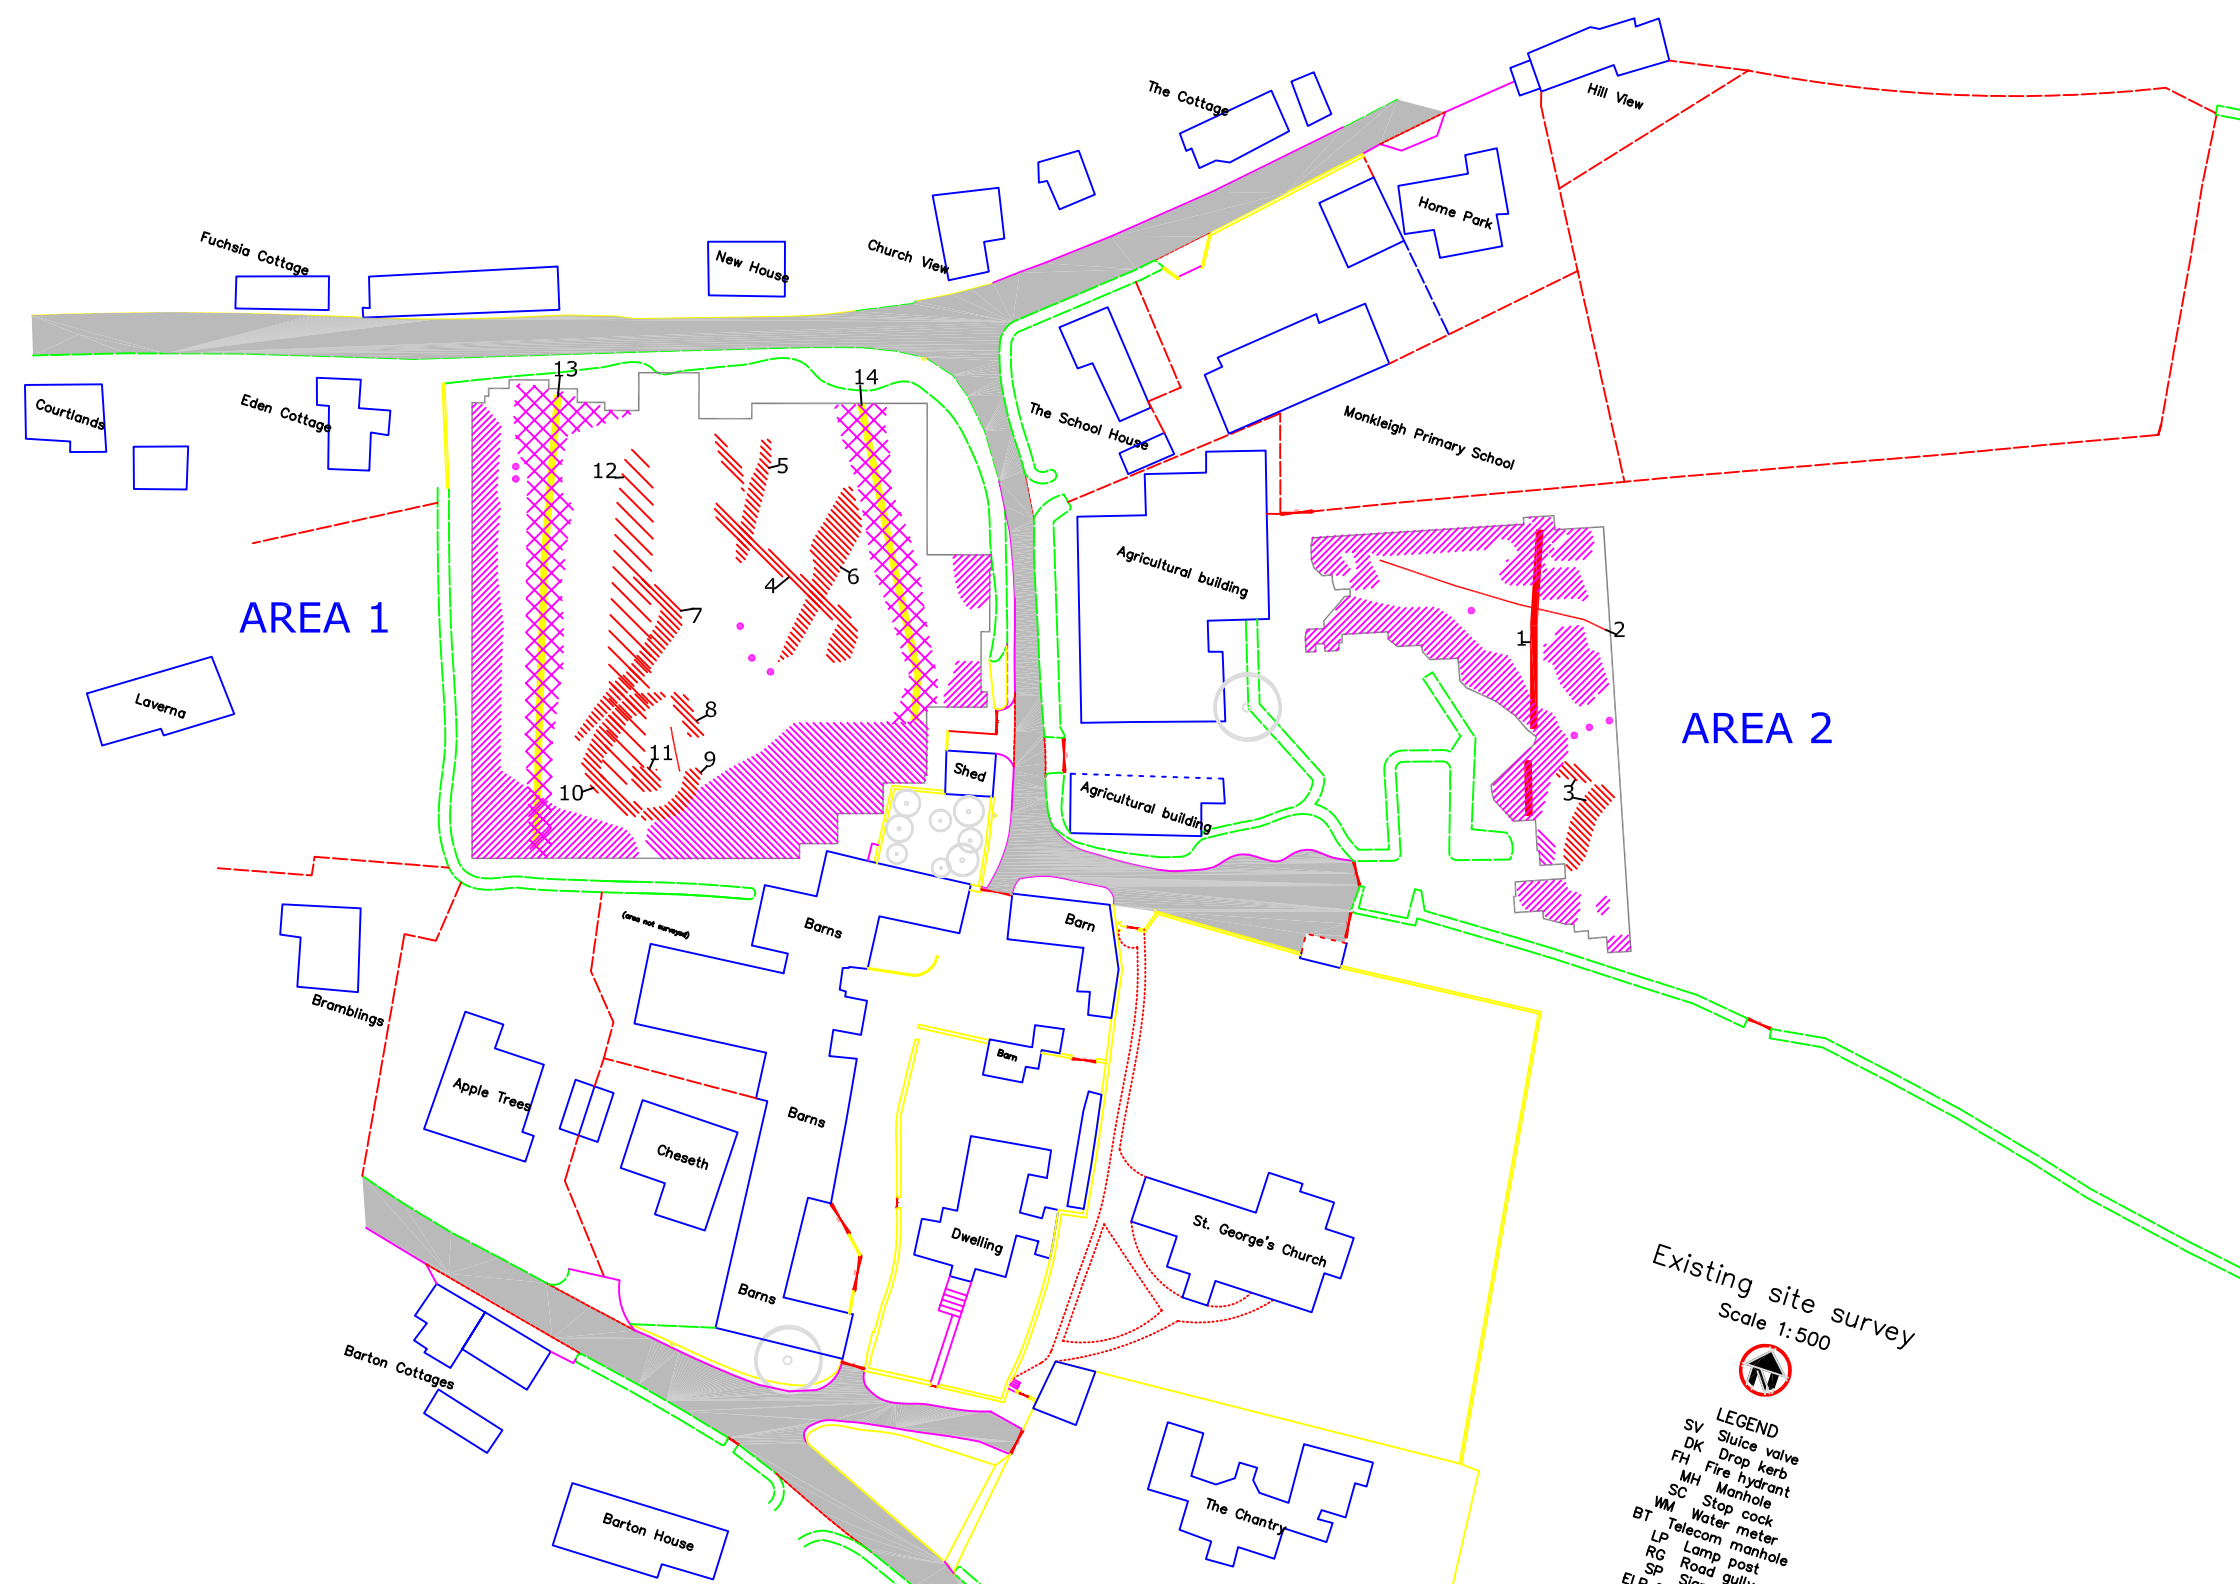

Amendments		
Issue No.	Date	Description
-	-	-
-	-	-


KEY	
	Positive anomaly with associated negative response - ferrous object
	Probable service
	Positive linear anomaly - cut feature of possible archaeological origin
	Positive area anomalies - possible cut features of archaeological origin
	Large positive area anomaly - possible cut feature or area of ground disturbance of archaeological origin
	Area of strong positive response likely to be associated with nearby buildings and ground disturbance
	Area of magnetic debris - associated with nearby buildings, field boundaries and ground disturbance of modern origin
	Area of magnetic disturbance associated with service


Client  
**EXETER ARCHAEOLOGY**

Project Title **GEOPHYSICAL SURVEY - MONKLEIGH NORTH DEVON** Job No. 2219

Subject  
**ABSTRACTION AND INTERPRETATION OF GRADIOMETER ANOMALIES**

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- Existing site survey  
 Scale 1:500
- 
- LEGEND**  
 SV Sluice valve  
 DK Drop kerb  
 FH Fire hydrant  
 MH Manhole  
 SC Stop cock  
 WM Water meter  
 BT Telecom manhole  
 LP Lamp post  
 RG Road gully  
 SP Sign  
 ELP

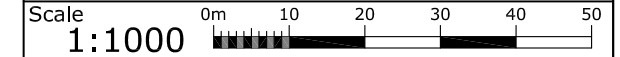Plot <b>A3</b>	Checked by <b>SAS</b>	Issue No. <b>01</b>
Survey date <b>SEPT 06</b>	Drawn by <b>HH</b>	Figure No. <b>07</b>